

COMMUNITY DEVELOPMENT DEPARTMENT

45175 Ten Mile Road Novi, MI 48375 (248) 347-0415 Phone (248) 735-5600 Facsimile www.cityofnovi.org

ZONING BOARD OF APPEALS STAFF REPORT

FOR: City of Novi Zoning Board of Appeals ZONING BOARD APPEALS DATE: September 12, 2023

REGARDING: 1927 West Lake Drive, Parcel # 50-22-03-131-026 (PZ23-0028)

BY: Alan Hall, Deputy Director Community Development

GENERAL INFORMATION:

Applicant

Ronnie & Wafaa Jamil

Variance Type

Dimensional Variance

Property Characteristics

Zoning District: This property is zoned One Family Residential (R-4)

Location: East of West Park Drive, South of Pontiac Trail

Parcel #: 50-22-03-131-026

Request

The applicant is requesting variances from City of Novi Zoning Ordinance Section 3.1.5 for a side yard setback of 2.25 ft. (10 ft. required, variance of 7.75 ft.); for an aggregate total of 4.5 ft. (25 ft. required, variance of 20.5 ft.); for an increase in lot coverage to 42.5% (25% maximum, variance of 17.5%) This variance would accommodate the building of a new home. This property is zoned One-Family Residential (R-4).

II. STAFF COMMENTS:

This property is 30' wide and located on Walled Lake. Currently the property has a house and a detached garage that are both nonconforming to the required setbacks. The existing house and detached garage are planned to be demolished. The new home and attached garage appear to be similar in lot coverage as other new homes in the area. There are (2) variances requested.

Case # PZ23-0028

III. RECOMMENDATION:

	The Z	oning Boa	rd of Appeal	s mav take	one of the	following actions:
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1.	I	mo		that				_		Case		PZ23-0028,	_	by
	be	caus	e 	Pe	tition	er 	has	shown		practi	cal	difficulty	requi	iring
		(a)					etition	er will be ur	nrea	sonably	preve	nted or limite	d with res	pect
		(b)	The	prope	erty is	s unique	e beca	use						
		(c)	Pet	itioner	did n	ot creat	e the c							
		(d)			_				-			n adjacent oi		_
		(e)	The	relie	f if	consiste	ent wi	th the spi	rit	and int	ent o	of the ordina	ance beca	ause
		(f)	The	variar	ice gr	anted is	subjec	et to:						•
				1. 2. 3. 4.	- - -									
2.	I	mo	ve	that	we	<u>deny</u>	the	variance 				PZ23-0028,	sought	by
						ner				show		practical	diffic	ulty

(a)	The	circumst	ances	features				includin ecause the
	exist g	generally th	roughout			_	•	•
(b)		reated beca	ause	 of the prope	<u>,</u>			
(c)		_		lt in mere in rn based	on		staten	nents tha
(d)		rties by	 	 interference	with	the adjacei	nt and	surrounding
(e)	_	•		consistent w		spirit and int	tent of th	ne ordinance

Should you have any further questions with regards to the matter please feel free to contact me at (248) 347-0423.

Alan Hall – Deputy Director Community Development - City of Novi

RECL. VED



Community Development Department

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JUL 1 1 2023

ZONING BOARD OF APPEALS **APPLICATION** COMMUNITY DEVELOPMENT

APPLICATION MUST BE FILLED OUT COMPLETELY

I. PROPERTY INFORMATION (Address of s	ubject ZBA Ca	se)	Application Fee:	250
PROJECT NAME / SUBDIVISION				
ADDRESS 1927 West Lake Drive		LOT/SIUTE/SPACE #		ZIP CODE ZIP CODE 48331 NE NO. ZIP CODE ZIP
50-22-03 -131 -026		tained from the Department	ZBA Case #: PZ	
CROSS ROADS OF PROPERTY	(240) 547-0	403		
IS THE PROPERTY WITHIN A HOMEOWNER'S ASSOCIATION	JURISDICTIONS	REQUEST IS FOR:		
YES NO		RESIDENTIAL 0	COMMERCIAL VACAN	t property Signage
DOES YOUR APPEAL RESULT FROM A NOTICE OF V	'IOLATION OR C	ITATION ISSUED?	□yes ⊠ no	
II. APPLICANT INFORMATION				
(NO)ME	amil (wg	asngoods.Ca	CELL PHONE NO. 248 - 330 - TELEPHONE NO.	8462
ORGANIZATION/COMPANY			FAX NO.	
ADDRESS 35649 Lancashire Drive		TTY 1 111	STATE	ZIP CODE
		Farmington Hill	s Mi	48551
	ADDRESS	THE PROPERTY OWNER	CELL PHONE NO.	
NAME			TELEPHONE NO.	
ORGANIZATION/COMPANY			FAX NO.	
ADDRESS		CITY	STATE	ZIP CODE
III. ZONING INFORMATION				
A. ZONING DISTRICT □ R-A □ R-1 □ R-2 □ R-3	☐ R-4	RM-1RM-2	Шмн	
□I-1 □I-2 □RC □TC	☐ TC-1	OTHER		
B. VARIANCE REQUESTED				
INDICATE ORDINANCE SECTION (S) AND VARIANCE		11 - 1.1	1 ()	1' 2'
1. Section 3 • 1 • 5 Variance	e requested _	Min Swe Yu	rd 10"/ Kegu	ies ling 2.25
2. SectionVariance	e requested _	Agg total	required 251 1	Equesting 4.5
3. SectionVariance	e requested	Max Let Cover	ge 25% request	179 42.5%
4. SectionVariance	e requested =			
IV. FEES AND DRAWNINGS				
A. FEES	_			
Single Family Residential (Existing) \$200	(With Violati	ion) \$250 🔀 Single	Family Residential (New	/) \$250
Multiple/Commercial/Industrial \$300	☐(With Violati	on) \$400 🗌 Signs S	\$300 🔲 (With Violation) \$400
		etings (At discretion	of Board) \$600	
 B. DRAWINGS 1-COPY & 1 DIGITAL COI Dimensioned Drawings and Plans 	Y SUBMITTED A		oned distances to ending	a a mala manana a mito o 18 co o
Site/Plot Plan		 Location of exi 	osed distance to adjac sting & proposed signs,	ent property lines if applicable
Existing or proposed buildings or addition	on the propert	y • Floor plans & e	levations	
 Number & location of all on-site parking, i 	r applicable	 Any other infor 	mation relevant to the	Variance application



ZONING BOARD OF APPEALS APPLICATION

V. VARIANCE
A. VARIANCE (S) REQUESTED
MDIMENSIONAL USE SIGN
There is a five (5) hold period before work/action can be taken on variance approvals.
B. SIGN CASES (ONLY) Your signature on this application indicates that you agree to install a Mock-Up Sign ten (10) days before the scheduled ZBA meeting. Failure to install a mock-up sign may result in your case not being heard by the Board, postponed to the next schedule ZBA meeting, or cancelled. A mock-up sign is NOT to be an actual sign. Upon approval, the mock-up sign must be removed within five (5) days of the meeting. If the case is denied, the applicant is responsible for all costs involved in the removal of the mock-up or actual sign (if erected under violation) within five (5) days of the meeting.
C. ORDINANCE
City of Novi Ordinance, Section 7.10 – Miscellaneous
No order of the ZBA permitting the erection of a building shall be valid for a period longer than one (1) year, unless a building permit for such erection or alteration is obtained within such period and such erection or alteration is started and proceeds to completion in accordance with the terms of such permit.
No order of the ZBA permitting a use of a building or premises shall be valid for a period longer than one-hundred and eighty (180) days unless such use is established within such a period; provided, however, where such use permitted is dependent upon the erection or alteration of a building such order shall continue in force and effect if a building permit for such erection or alteration is obtained within one (1) year and such erection or alteration is started and proceeds to completion in accordance with the terms of such permit.
D. APPEAL THE DETERMINATION OF THE BUILDING OFFICIAL
PLEASE TAKE NOTICE:
The undersigned hereby appeals the determination of the Building Official / Inspector or Ordinance made
Construct new home/building addition to existing home/building signage
ACCESSORY BUILDING USE OTHER
VI. APPLICANT & PROPERTY SIGNATURES
A. APPLICANT /
Applicant Signature Date
Applicant Signature. Date
B. PROPERTY OWNER If the applicant is not the owner, the property owner must read and sign below: The undersigned affirms and acknowledges that he, she or they are the owner(s) of the property described in this application, and is/are aware of the contents of this application and related enclosures.
Property Owner Signature Date
VII. FOR OFFICIAL USE ONLY
DECISION ON APPEAL:
☐ GRANTED ☐ DENIED
The Building Inspector is hereby directed to issue a permit to the Applicant upon the following conditions:
I



Community Development Department

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REVIEW STANDARDS DIMENSIONAL VARIANCE

The Zoning Board of Appeals (ZBA) will review the application package and determine if the proposed Dimensional Variance meets the required standards for approval. In the space below, and on additional paper if necessary, explain how the proposed project meets each of the following standards. (Increased costs associated with complying with the Zoning Ordinance will not be considered a basis for granting a Dimensional Variance.)

Standard #1. Circumstances or Physical Conditions.

Explain the circumstances or physical conditions that apply to the property that do not apply generally to other properties in the same zoning district or in the general vicinity. Circumstances or physical conditions may include:

a.	Shape of Lot. Exceptional narrowness, shallowness or shape of a specific property in existence on the effective date of the Zoning Ordinance or amendment. ☐ Not Applicable ☐ Applicable ☐ If applicable, describe below:
	Lot is Narrow to build a house
	and/or
b.	Environmental Conditions. Exceptional topographic or environmental conditions or other extraordinary situations on the land, building or structure. Not Applicable ☐ Applicable ☐ If applicable, describe below:
	and/or
c.	Abutting Property. The use or development of the property immediately adjacent to the subject property would prohibit the literal enforcement of the requirements of the Zoning Ordinance or would involve significant practical difficulties. ✓ Not Applicable ☐ Applicable ☐ If applicable, describe below:

Standard #2. Not Self-Created.

Describe the immediate practical difficulty causing the need for the Dimensional Variance, that the need for the requested variance is not the result of actions of the property owner or previous property owners (i.e., is not self-created).

I aguirou the Property as is

Standard #3. Strict Compliance.

Explain how the Dimensional Variance in strict compliance with regulations governing area, setback, frontage, height, bulk, density or other dimensional requirements will unreasonably prevent the property owner from using the property for a permitted purpose, or will render conformity with those regulations unnecessarily burdensome.

Let is too Small to build a house with the required Setbook

Standard #4. Minimum Variance Necessary.

Explain how the Dimensional Variance requested is the minimum variance necessary to do substantial justice to the applicant as well as to other property owners in the district.

hat is only 30 Ft wide as the other homes on the sum. Threat. need the Variance to build a Livable home

Standard #5. Adverse Impact on Surrounding Area.


Explain how the Dimensional Variance will not cause an adverse impact on surrounding property, property values, or the use and enjoyment of property in the neighborhood or zoning district.

the House will add more Value to Someon ling Homes in the area

SINGLE FAMILY HOUSE

1927 W Lake Rd, Novi, MI 48377



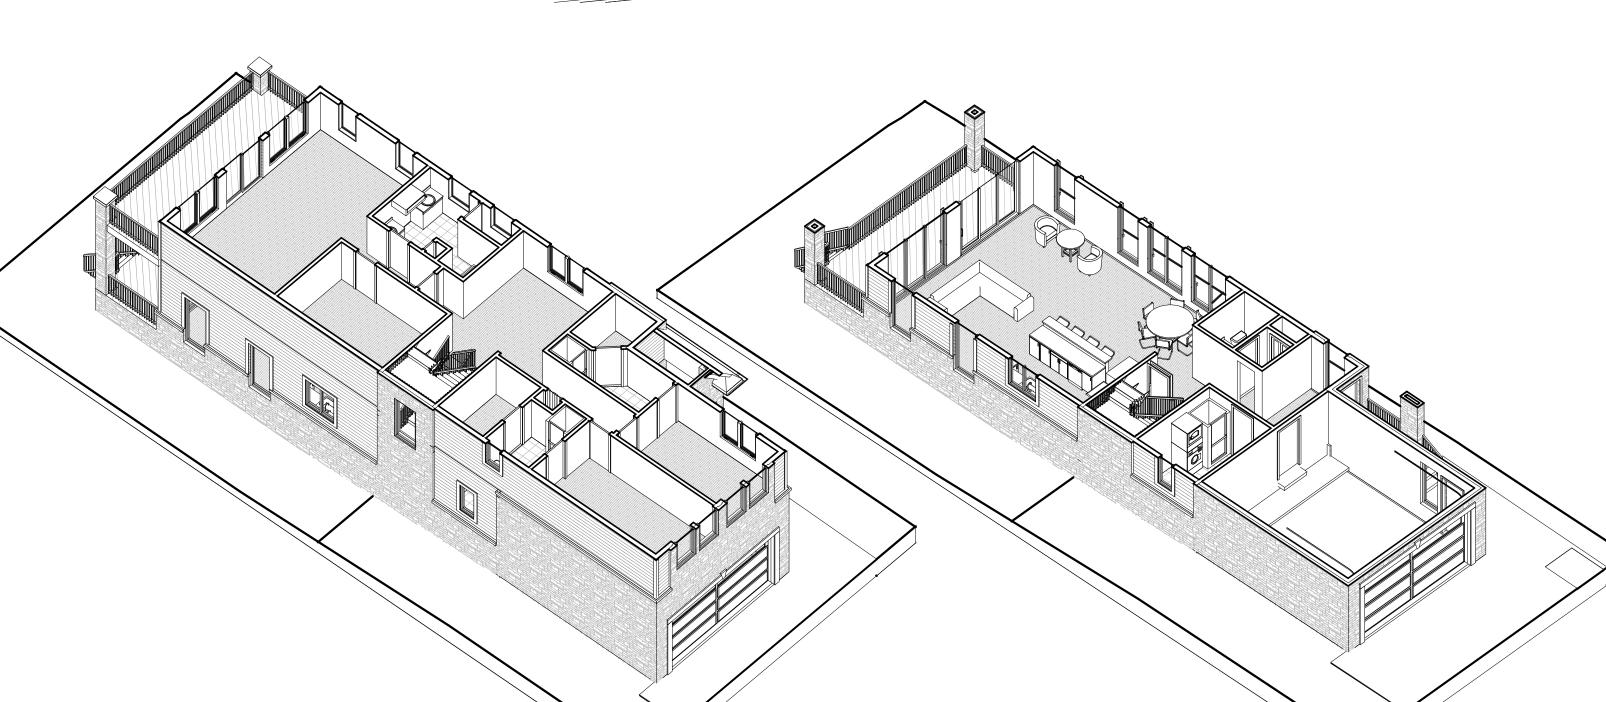

(4) 1ST FLOOR

SHEET LIST				
Sheet Number	Sheet Name			
A100	COVER SHEET			
A101	FOUNDATION PLAN			
A102	FLOOR PLANS			
A103	ELEVATIONS			
A104	ELEVATIONS			
A106	3D VIEWS			
A105	SECTIONS			

AREA SCHEDULE	(GROSS BUILDING)
Level	Area
1ST FLOOR	1200 SF
2ND FLOOR	1578 SF
	2778 SE

Deferred submittal: sealed truss drawings by truss company mrc 2015, 802.10

DESIGN LO

2ND FLOOR

3/32" = 1'-0"

THE STRUCTURE IS DESIGNED FOR THE FOLLOWING LIVE LOADS, IN ADDITION TO THE LATERAL LOADS AND SUPERIMPOSED DEAD LOADS AND SELF-WEIGHT OF THE STRUCTURE.


BUILDING OCCUPANCY CATEGORY: 11

LIVELOADS

- ROOF SNOW LOAD:
 GROUND SNOW LOAD: 25.0 PSF
 FLAT ROOF SNOW LOAD (PI): (MINIMUM ROOF LOAD): 20 PSF
- SNOW EXPOSURE FACTOR (Ce): 1.0
 SNOW LOAD IMPORTANCE FACTOR (I): 1.0
 THERMAL FACTOR (Ct): 1.0

ELEVATIONS AND ICE AT OVERHANGS PER APPLICABLE CODE. DESIGN DEAD LOAD: 15 PSF TOTAL DESIGN ROOF LOAD: 35 PSF



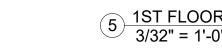

E ALARM INTERIOR

317.1 SINGLE-AND MULTIPLE- STATION SMOKE ALARMS. SINGLE AND MULTIPLE STATION SMOKE ALARM SHALL BE INSTALLED IN THE FOLLOWING LOCATIONS: 1- IN EACH SLEEPING ROOM.

2- OUTSIDE OF EACH SEPARATE SLEEPING AREA MAXIMUM TEN-FOOT EPOM THE REPPROMEDION.

3-ON EACH ADDITIONAL STORY OF THE DWELLING, INCLUDING BASEMENTS AND CELLARS BUT NOT INCLUDING CRAWL SPACES AND UNINHABITABLE ATTICS OR DWELLING UNITS WITH SPLIT LEVELS AND WITHOUT AN INTERVENING DOOR BETWEEN THE ADJACENT LEVELS, A SMOKE ALARM INSTALLED ON THE UPPER LEVEL SHALL SUFFICE FOR THE ADJACENT LOWER LEVEL PROVIDED THAT THE LOWER LEVEL IS LESS THAN ONE FULL STORY BELOW THE UPPER LEVEL NOTES FROM MICHIGAN RESIDENTIAL CODE 2009

FRAMING:

-notches in solid lumber joists,rafters and beams shall not EXCEED ONE-SIXTH OF THE DEPTH OF THE MEMBER, SHALL NOT BE LONGER THAN ONE THIRD OF THE DEPTH OF THE MEMBER AND SHALL NOT BE LOCATED IN THE MIDDLE ONE THIRD OF THE SPAN.NOTCHES AT THE ENDS OF THE MEMBER SHALL NOT EXCEED ONE-FORTH THE DEPTH OF THE MEMBER.THE DIAMETER OF THE HOLES BORED OR CUT INTO MEMBERS SHALL NOT EXCEED ONE-THIRD THE DEPTH OF THE MEMBER.HOLES SHALL NOT BE CLOSER THAN 2" TO THE TOP OR BOTTOM OF THE MEMBER, OR TO ANY OTHER HOLE OR NOTCH LOCATED IN THE MEMBER. -TOP PLATES WOOD STUDS WALLS SHALL BE CAPPED WITH A DOUBLE TOP PLATE INSTALLED TO PROVIDE OVERLAPPING AT CORNERS AND INTERSECTIONS WITH BEARING PARTITIONS. END JOINTS IN TOP PLATES SHALL BE OFFSET AT LEAST 24 INCHES. -DRILLING AND NOTCHING STUDS: ANY STUD IN AN EXTERIOR WALL OR BEARING PARTITION MAY BE CUT OR NOTCHED TO A DEPTH NOT EXCEEDING 25 PERCENT OF ITS WIDTH. STUDS IN NONBEARING PARTITIONS MAY BE NOTCHED TO A DEPTH NOT TO EXCEED 40 PERCENT OF A SINGLE STUD WIDTH.ANY STUD MAY BE BOARD OR DRILLED, PROVIDED THAT THE DIAMETER OF THE RESULTING HOLE IS NO GREATER THAN 40 PERCENT OF THE STUD WIDTH, THE EDGE OF THE HOLE IS NO CLOSER THAN 5/8" TO THE EDGE OF THE STUD, AND THE HOLE IS NOT LOCATED IN THE SAME SECTION AS THE A CUT OF A NOTCH. -WHEN THE TOP PLATE OF AN EXTERIOR OR INTERIOR LOAD BEARING WALL IS CUT BY MORE THAN 50 WIDTH A GALVANIZED METAL TIE NOT LESS THAN 0.054 INCH THICK AND 1.5 INCH WIDE SHALL BE FASTENED TO EACH PLATE ACROSS AND TO EACH SIDE OF THE OPENING WITH NOT LESS THAN SIX 16D NAILS.

-JOISTS FRAMING FROM OPPOSITE SIDES OVER A BEARING SUPPORT SHALL LAP A MINIMUM OF 3 INCHES AND SHALL BE NAILED TOGETHER WITH A MIN. OF THREE FACE NAIL -JOIST FRAMING INTO THE SIDE OF WOOD GIRDER SHALL BE SUPPORTED BY APPROVED FRAMING ANCHORS OR ON LEDGER STRIP NOT LESS THAN NOMINAL 2 INCHES BY 2 INCHES. -THE ENDS OF EACH JOIST, BEAM OR GIRDER SHALL HAVE NOT LESS THAN 1 1/2" INCHES OF BEARING ON WOOD AND NOT LESS THAN 3 INCHES ON CONCRETE.

FLASHING: -FLASHING INSPECTION WILL BE REQUIRED PRIOR TO INSTALLING THE FULL WALL OF BRICK

-WEEP HOLES: WEEP HOLES SHALL BE PROVIDED IN THE OUTSIDE WYTH OF MASONRY WALLS AT A MAXIMUM SPACING OF 33 INCHES ON CENTER, SHALL NOT BE LESS THAN 3/16" IN DIAMETER.
-PROVIDE CORROSION-RESISTANT FLASHING AT THE EXTERIOR FRONT PORCH AT THE LINE OF ATTACHMENT WITH THE HOUSE AT THE FOYER.

FIRE SAFET

-FIRE BLOCKING SHALL BE PROVIDED BY USING BATTS OR BLANKETS OF MINERAL OR GLASS FIBER OR OTHER APPROVED NONRIGID MATERIAL AT OPENINGS AROUND VENTS, PIPES AND DUCTS AT CEILING AND FLOOR LEVEL, AT THE CONCEALED SPACE BETWEEN STAIR STRINGERS AT THE TOP AND BOTTOM OF RUN, AT CONCEALED SPACES OF STUD WALLS AND PARTITIONS AT THE CEILING AND FLOOR LEVEL.
-DRAFT STOP SHOULD BE INSTALLED AT THE SECOND FLOOR AND DIVIDE THE FLOOR AREA INTO TWO EQUAL AREAS IF FLOOR FRAMING CONSTRUCTED OF TRUSS-TYPE OPEN WEB OR PERFORATED MEMBERS, DRAFT STOPPING MATERIAL SHOULD BE 1/2" GYPSUM BOARD. (R502.12 MI. RES. CODE 2009)

EXTERIOR FINISHES:

-BRICK VENEER IS ANCHORED TO WOOD STUDS BY USING CORRUGATED SHEET METAL TIES, NO.22 U.S. GAGE BY 7/8" CORRUGATED ,SPACED AT 24"HORIZONTALLY AND 16" VERTICALLY.
-ADDITIONAL METAL TIES WILL BE PROVIDED AROUND ALL WALL

OPENINGS GREATER THAN 16" IN EITHER DIMENSION.

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-BATHTUB AND SHOWER FLOORS AND WALLS ABOVE BATHTUBS WITH INSTALLED SHOWER HEADS SHALL BE FINISHED WITH NONABSORBENT SURFACE AND SHALL EXTEND TO A HEIGHT OF 6 FT ABOVE THE FLOOR.
-GYPSUM BACKER: GYPSUM BOARD USED AS THE BASE OR BACKER BOARD FOR ADHESIVE APPLICATION OF CERAMIC TILE OR OTHER NONABSORBENT FINISH MATERIAL SHALL CONFIRM WITH ASTM C 630 OR C1178. WATER RESISTANT GYPSUM BACKING BOARD SHALL BE PERMITTED TO BE USED ON CEILINGS WHERE FRAMING SPACING DOES NOT EXCEED 12 INCHES ON CENTER FOR 1/2" THICK OR 16 INCHES FOR 5/8" INCH THICK GYPSUM BOARD.

-TEMPERED GLASS SHOULD BE USED OVER THE MASTER TUB.

-HABITABLE ROOMS, HALLWAYS, CORRIDORS, BATHROOMS, LAUNDRY ROOMS AND BASEMENT SHALL HAVE A CEILING HEIGHT NOT LESS THAN 7 FEET MEASURED FROM THE FINISH FLOOR TO THE LOWEST PROJECTION FROM THE CEILING.

ROOM CEILING HEIGHTS:
-HABITABLE ROOMS, HALLWAYS, CORRIDORS, BATHROOMS, LAUNDRY
ROOMS AND BASEMENT SHALL HAVE A CEILING HEIGHT NOT LESS
THAN 7 FEET MEASURED FROM THE FINISH FLOOR TO THE LOWEST
PROJECTION FROM THE CEILING.

SMOKE ALARMS:

-THE SMOKE ALARM DEVICES SHALL BE INTERCONNECTED IN SUCH A MANNER THAT THE ACTUATION OF ONE ALARM WILL ACTIVATE ALL OF THE ALARMS IN THE DWELLING UNIT, THE ALARM SHALL BE CLEARLY AUDIBLE IN ALL BEDROOMS OVER BACKGROUND NOISE LEVELS WITH ALL INTERVENING DOORS CLOSED.

-ALL SMOKE ALARMS SHALL BE LISTED AND INSTALLED IN ACCORDANCE WITH THE PROVISIONS OF THIS CODE AND THE HOUSEHOLD FIRE WARNING EQUIPMENT PROVISIONS OF NFPA 72.
-THE SMOKE ALARM SHALL RECEIVE THEIR PRIMARY POWER FROM THE BUILDING WIRING WHEN SUCH WIRING IS SERVED FROM A COMMERCIAL SOURCE AND WHEN PRIMARY POWER IS INTERRUPTED SHALL RECEIVE POWER FROM BATTERY .WIRING SHALL BE PERMANENT AND WITHOUT A DISCONNECTING SWITCH OTHER THAN THOSE REQUIRED FOR OVER CURRENT PROTECTION.

ROOF CONSTRUCTION:

-TRUSS MANUFACTURER SHALL HAVE TRUSS TIES PROVIDED AT BEARING LOCATIONS IN ACCORDANCE WITH TABLE 802.11.A OF THE CODE, CONTINUOUS LOAD PATH SHALL BE PROVIDED TO TRANSMIT THE UPLIFT FORCES FROM THE TRUSS TIES TO THE FOUNDATION. WIND UPLIFT PRESSURE ON ROOF ASSEMBLIES SHALL BE DETERMINED USING THE EFFECTIVE WIND AREA OF 100 SQ. FT. AND ZONE 1 IN TABLE R301.2(2)

EMERGENCY ESCAPE:


EVERY SLEEPING SPACE SHALL HAVE AT LEAST ONE OPENABLE EMERGENCY ESCAPE WINDOW WITH SILL HEIGHT NOT MORE THAN 44" ABOVE THE FLOOR, MIN. NET CLEAR OPENING HEIGHT 24" AND MIN. NET OPENING WIDTH OF 20". R310 MICH. RESIDENTIAL CODE 2009.

FOR ALL HEADERS OVER FOUR FEET AND LVL BEAMS
USE TWO JACK STUD UNDER EACH END AND ONE KING STUD


ELECTRICAL


A SWITCH CONTROLLED LIGHT FIXTURE OR RECEPTACLE MUST BE INSTALLED IN: EVERY HABITABLE ROOM, BATHROOM, HALLWAY, STAIRWAY, UTILITY ROOM, ATTACHED GARAGE, DETACHED GARAGE W/ELECTRIC POWER, STORAGE SPACE, AND EXTERIOR DOOR GRADE-LEVEL DOOR LOCATIONS. ATTICS AND UNDER FLOOR SPACES CONTAINING EQUIPMENT OR USED FOR STORAGE MUST BE PROVIDED WITH A SWITCH OPERATED LIGHT.

RECEPTACLE OUTLETS ARE REQUIRED IN EVERY KITCHEN, FAMILY ROOM, DINING ROOM, LIVING ROOM, PARLOR, LIBRARY, DEN, SUNROOM, BEDROOM, REC ROOM, HALLWAY 6 FT. OR MORE IN LENGTH AND SIMILAR DWELLING AREAS SPACED SO THAT NO POINT ALONG THE WALL LINE EXCEEDS 6 FT. FROM AN OUTLET. AT LEAST 1 RECEPTACLE SHALL BE INSTALLED IN A BATHROOM WITHIN 36" OF EACH BASIN. COUNTERS 12" IN WIDTH OR WIDER SHALL HAVE RECEPTACLES PLACED WITHIN 20" ABOVE THE COUNTER TOP AND SPACED SO NO POINT EXCEEDS 24" FROM AN OUTLET. AT LEAST ONE RECEPTACLE OUTLET MUST BE INSTALLED IN EACH LAUNDRY, BASEMENT, ATTACHED GARAGE. OUTDOOR OUTLETS MUST BE INSTALLED AT THE FRONT AND BACK OF EACH DWELLING WITHIN 6'-6" ABOVE GRADE. ATTICS OR CRAWLSPACES CONTAINING EQUIPMENT MUST BE PROVIDED WITH AT LEAST ONE RECEPTACLE OUTLET WITHIN 25 FT. OF THE EQUIPMENT.

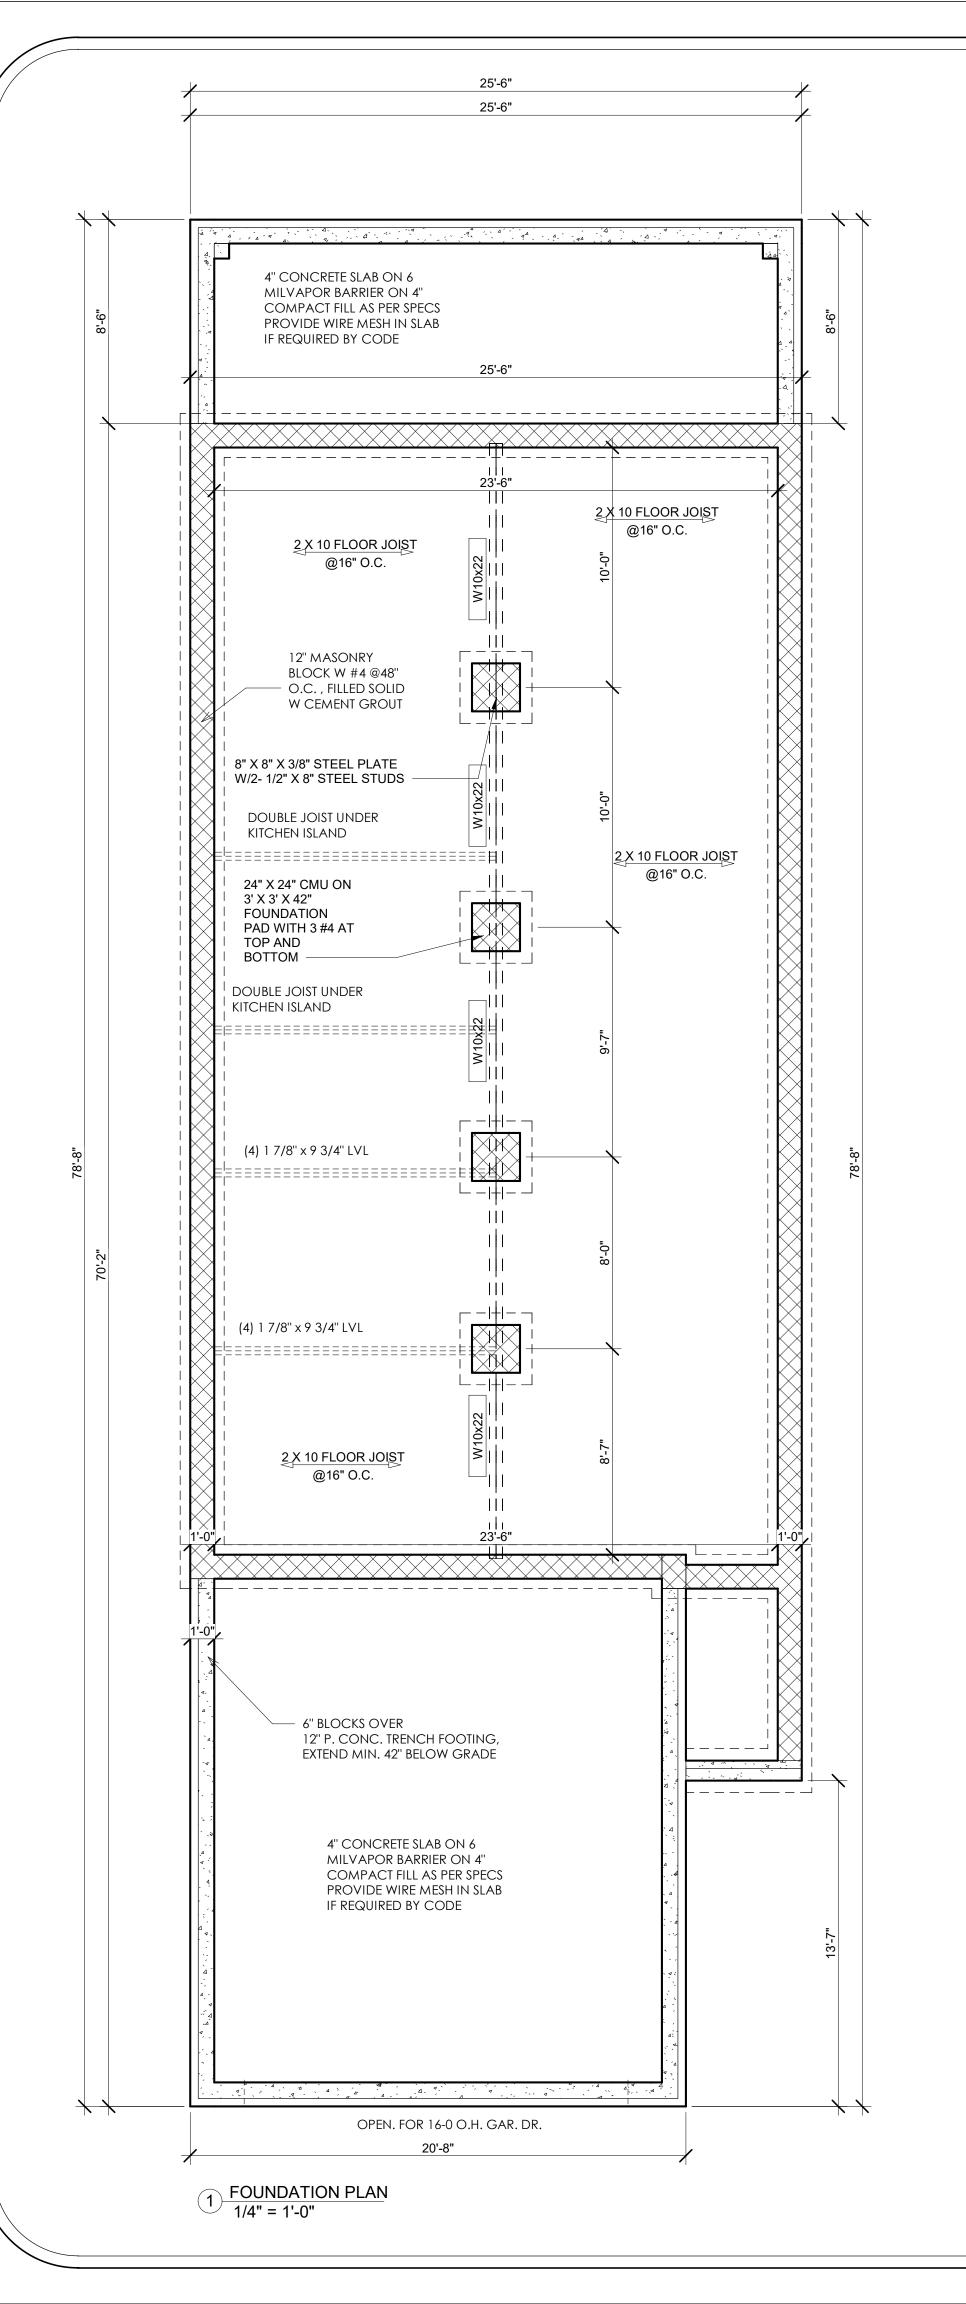

O IX	AWL SPACE NOTES		
1.	SEAL EXTERIOR WALL PENETRATIONS AND MATING SURFACES AT TOP AND BOTTOM OF SILL	11.	CONTROL MOISTURE VAPOR IN THE CRAWL SPACE WITH SUPPLY AIR FROM THE HOUSE AIRCONDITIONII
	PLATE AND AT TOP AND BOTTOM OF BAND		SYSTEM. SET SUPPLY AIR
	JOIST. CRAWL SPACE ACCESS PANEL(S) OR		VOLUME PER LOCAL RESIDENTIAL CODE
	DOOR(S) MUST BE AIR-SEALED.		REQUIREMENT. ADJUST AS NEEDED TO CONTROL
			RELATIVE HUMIDITY IN CRAWL SPACE TO DESIRED
2.	NO OPEN FOUNDATION VENTS ARE ALLOWED IN		LEVEL. PROVIDE A BACKFLOW DAMPER AND
	EXTERIOR WALLS. OPENINGS TO VENTILATED		EITHER A BALANCING DAMPER OR CONSTANT
	PORCH FOUNDATIONS MUST BE AIR-SEALED		AIRFLOW REGULATOR TO CONTROL AIRFLOW.
	WITH AN ACCESS PANEL OR PERMANENT		MULTIPLE SUPPLY VENTS MAY BE USED TO
	MATERIALS. INSTALL FLOOD VENTS PER LOCAL		ACHIEVE THE DESIRED AIRFLOW AND/OR DESIRED
	RESIDENTIAL CODE WHERE REQUIRED.		DISTRIBUTION OF AIR. NO RETURN AIR VENT IS
			ALLOWED IN THE CRAWL SPACE.
3.	SLOPE FINISHED GRADE AWAY FROM BUILDING		
	PER LOCAL RESIDENTIAL CODE OR FOR 6-INCH	12.	TERMINATE WATER HEATER DRAINS,
	DROP OVER 10 FEET. PROVIDE A METHOD TO		TEMPERATURE/PRESSURE RELIEF PIPES, AND
	TRANSPORT ROOF RUNOFF AWAY FROM THE		A/C CONDENSATE DRAINS TO OUTDOORS OR TO
	HOUSE. GUTTERS AND DOWNSPOUTS ARE ONE		AN INTERIOR PUMP THAT DISCHARGES TO A
	SUCH METHOD.		DRAIN OR OUTDOORS. TERMINATE ALL KITCHEN,
			BATHROOM AND CLOTHES DRYER VENTS TO
4.	DAMPPROOF OR WATERPROOF THE EXTERIOR		OUTDOORS.
	WALL SURFACE WHEN THE CRAWL SPACE FLOOR		
	IS BELOW EXTERIOR GRADE.	13.	ANY FUEL-FIRED FURNACES, WATER HEATERS, OR
			OTHER APPLIANCE IN A CLOSED CRAWL SPACE
5.	IT IS NOT NECESSARY TO PROVIDE A CAPILLARY		SHOULD BE OF A "DIRECT VENT" OR "TWO PIPE"
	BREAK BETWEEN THE FOOTINGS AND		DESIGN, MEANING THAT ALL AIR FOR
	FOUNDATION WALLS OR INTERIOR COLUMNS.		COMBUSTION IS PIPED DIRECTLY FROM
			OUTSIDE TO THE APPLIANCE AND ALL
6.	PROVIDE FOUNDATION DRAIN TO DAYLIGHT PER		COMBUSTION EXHAUST GASES ARE PIPED
	LOCAL RESIDENTIAL CODE REQUIREMENTS.		DIRECTLY FROM THE APPLIANCE TO OUTSIDE.
7.	SEAL ALL PLUMBING, ELECTRICAL, DUCT, CABLE,	14.	COVER 100% OF THE CRAWL SPACE FLOOR WITH
	AND OTHER PENETRATIONS THROUGH THE		A MINIMUM 6-MIL VAPOR RETARDER. INSTALL
	SUB-FLOOR WITH FIRE-STOP MATERIALS		VAPOR RETARDER MATERIAL ON THE INSIDE WALL
	AND SEALANTS. FIBERGLASS OR ROCKWOOL		SURFACES, AND MECHANICALLY FASTEN AND
	INSULATION ALONE ARE NOT SUFFICIENT.		SEAL IT TO THE TOP OF THE WALLS, LEAVING THE
			REQUIRED INSPECTION GAP. EXTEND THE
8.	INSULATE THE CRAWL SPACE WALL OVER THE WALL		MATERIAL UP THE INTERIOR COLUMNS AT LEAST
	VAPOR RETARDER MATERIAL WITH RIGID FOAM OR		4 INCHES ABOVE THE CRAWL SPACE FLOOR.
	OTHER NON-POROUS INSULATION MATERIAL.		SEAL ALL SEAMS AND EDGES WITH FIBERGLASS
	LEAVE A MINIMUM 3" TERMITE INSPECTION		MESH TAPE AND MASTIC OR EQUIVALENT.
	GAP BETWEEN THE TOP OF THE WALL INSULATION AND		MECHANICALLY SECURE THE VAPOR RETARDER TO
	THE TOP OF THE MASONRY. LEAVE A 3" WICKING		THE GROUND AS NECESSARY.
	GAP BETWEEN THE BOTTOM OF THE WALL INSULATION		
	AND THE CRAWL SPACE FLOOR SURFACE. OBTAIN	15.	GRADE THE CRAWL SPACE FLOOR TO ONE OR
	R-VALUE FROM LOCAL RESIDENTIAL CODE. ENSURE		MORE LOW POINTS. PROVIDE CRAWL SPACE
	THAT THE INSULATION COMPLIES WITH LOCAL RESID.		DRAIN(S) OR SUMP PUMP(S) AT LOWEST
	CODE REQUIREMENTS FOR INSTALLATION WITHOUT A		POINT(S). SLOPE DRAINS TO DAYLIGHT AND
	THERMAL BARRIER OR IGNITION BARRIER. INSULATE		INCLUDE AN ACCESSIBLE BACKFLOW VALVE AND
	BAND JOIST WITH BATT INSULATION TO FACILITATE		1/4-INCH RODENT SCREENING. GUTTER DRAINS
	REMOVAL AND REINSERTION DURING PEST CONTROL		AND FOUNDATION DRAINS (INTERIOR OR EXTERIOR)
	INSPECTIONS. ENSURE THAT BATT FACINGS COMPLY		MUST NOT BE CONNECTED TO THE CRAWL
	WITH LOCAL FIRE REQUIREMENTS.		SPACE DRAIN.
6			
9.	LEAVE A MINIMUM 3" TERMITE INSPECTION		
	GAP BETWEEN THE TOP OF THE WALL VAPOR		
	RETARDER AND THE TOP OF THE MASONRY WALL.		
	SEAL THE TOP OF THE VAPOR RETARDER TO THE		
	WALL WITH DUCT MASTIC OR EQUIVALENT		
	SEALANT. OPTIONALLY, APPLY A LIGHT COLORED		
	PAINT OR COATING OVER THE INSPECTION GAP		
	TO IMPROVE INSPECTABILITY BY PEST CONTROL		
	PROFESSIONALS.		
10	AID SEAL ALL LIEATING AND COOLING BUGTWOOD		
10.	AIR SEAL ALL HEATING AND COOLING DUCTWORK		
	WITH A MASTIC SYSTEM. INSTALL ALL DUCTWORK LOCATED IN THE CRAWL SPACE WITH R-VALUE		

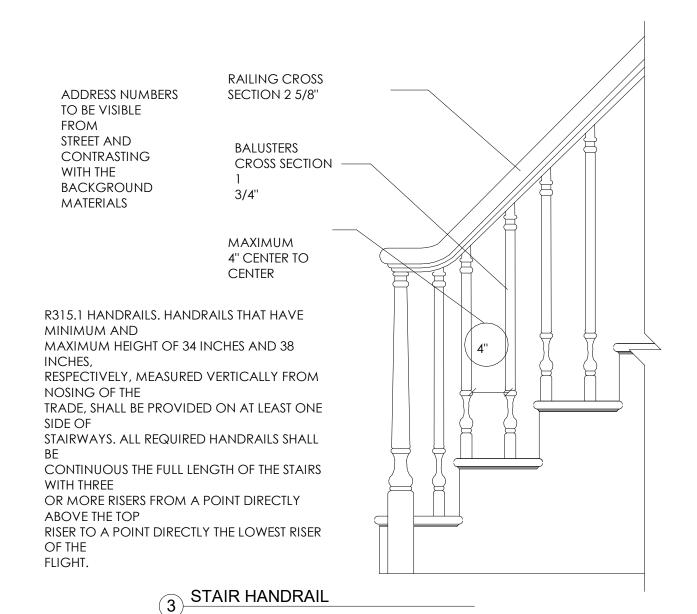

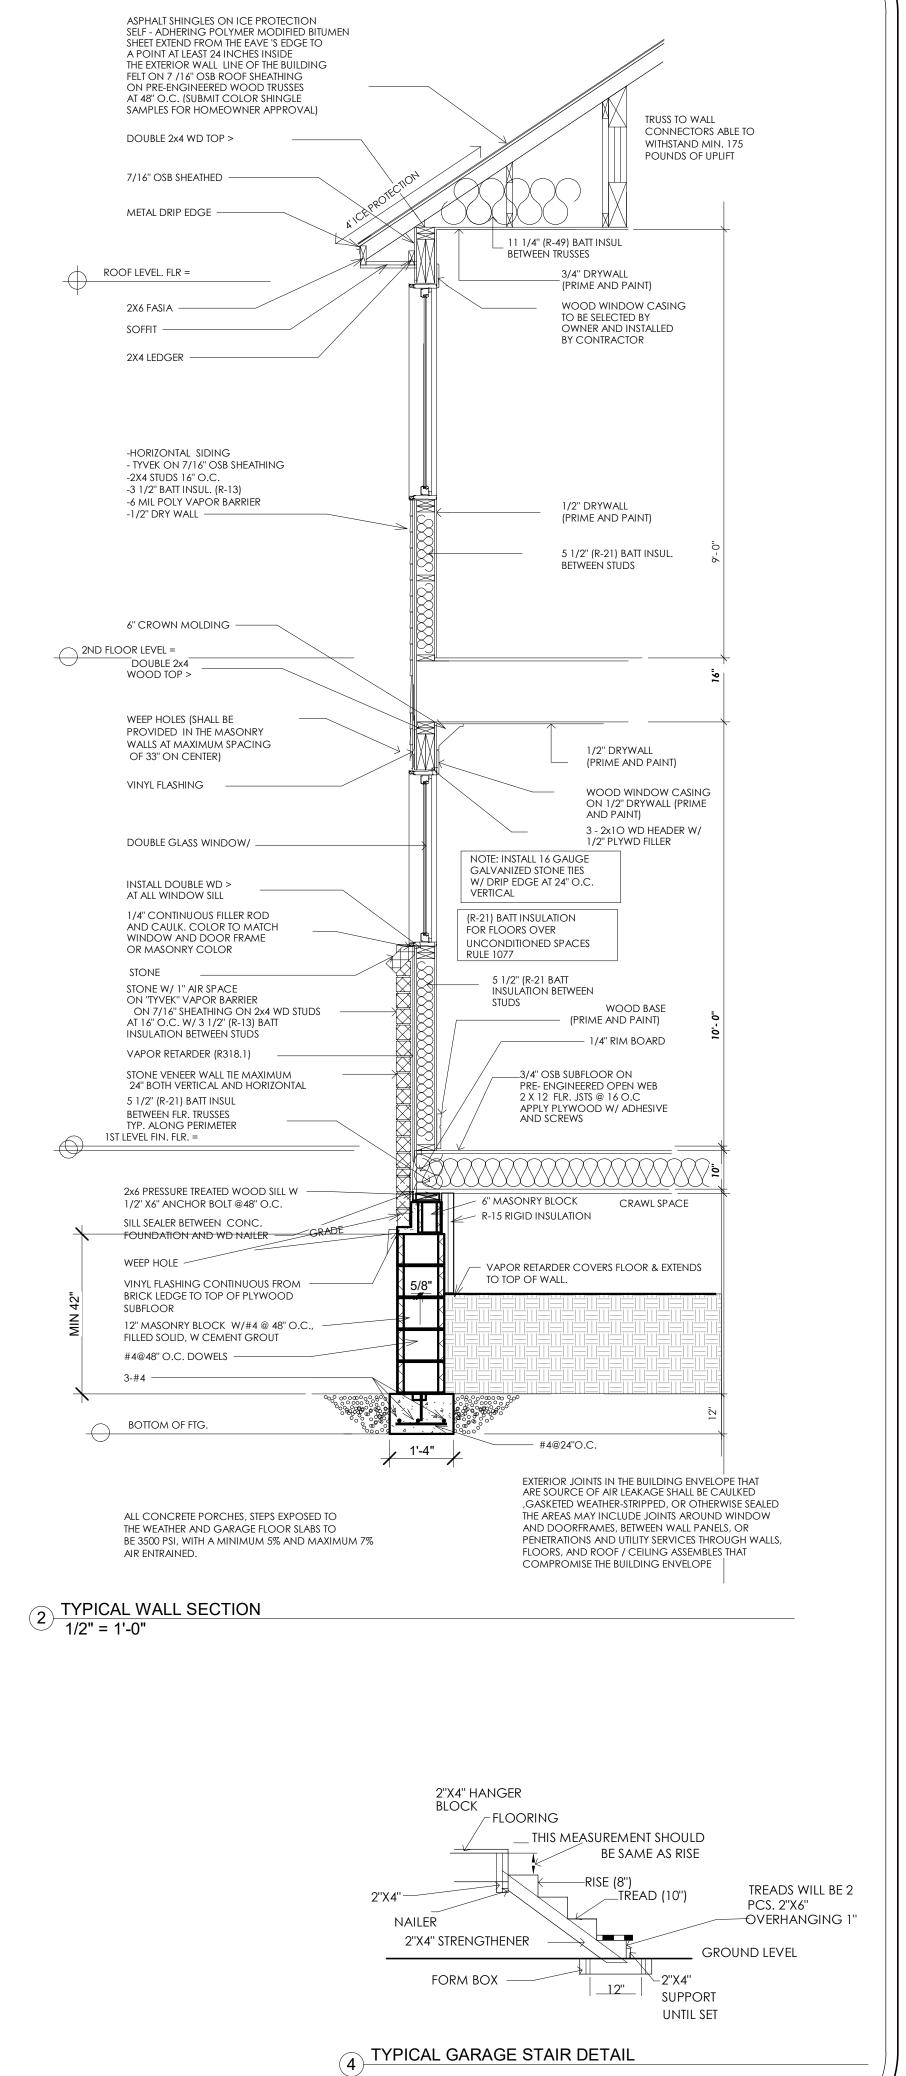

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PROJECT: SINGLE FAMILY HOUSE **ADDRESS** 1927 W Lake Rd, Novi, MI 48377 <u>OWNER</u> **CONTRACTOR**


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SHEET TITLE FOUNDATION PLAN



AREA SCHEDULE (GROSS BUILDING) 1ST FLOOR

2'-8" x 7'-0"

2' - 8"

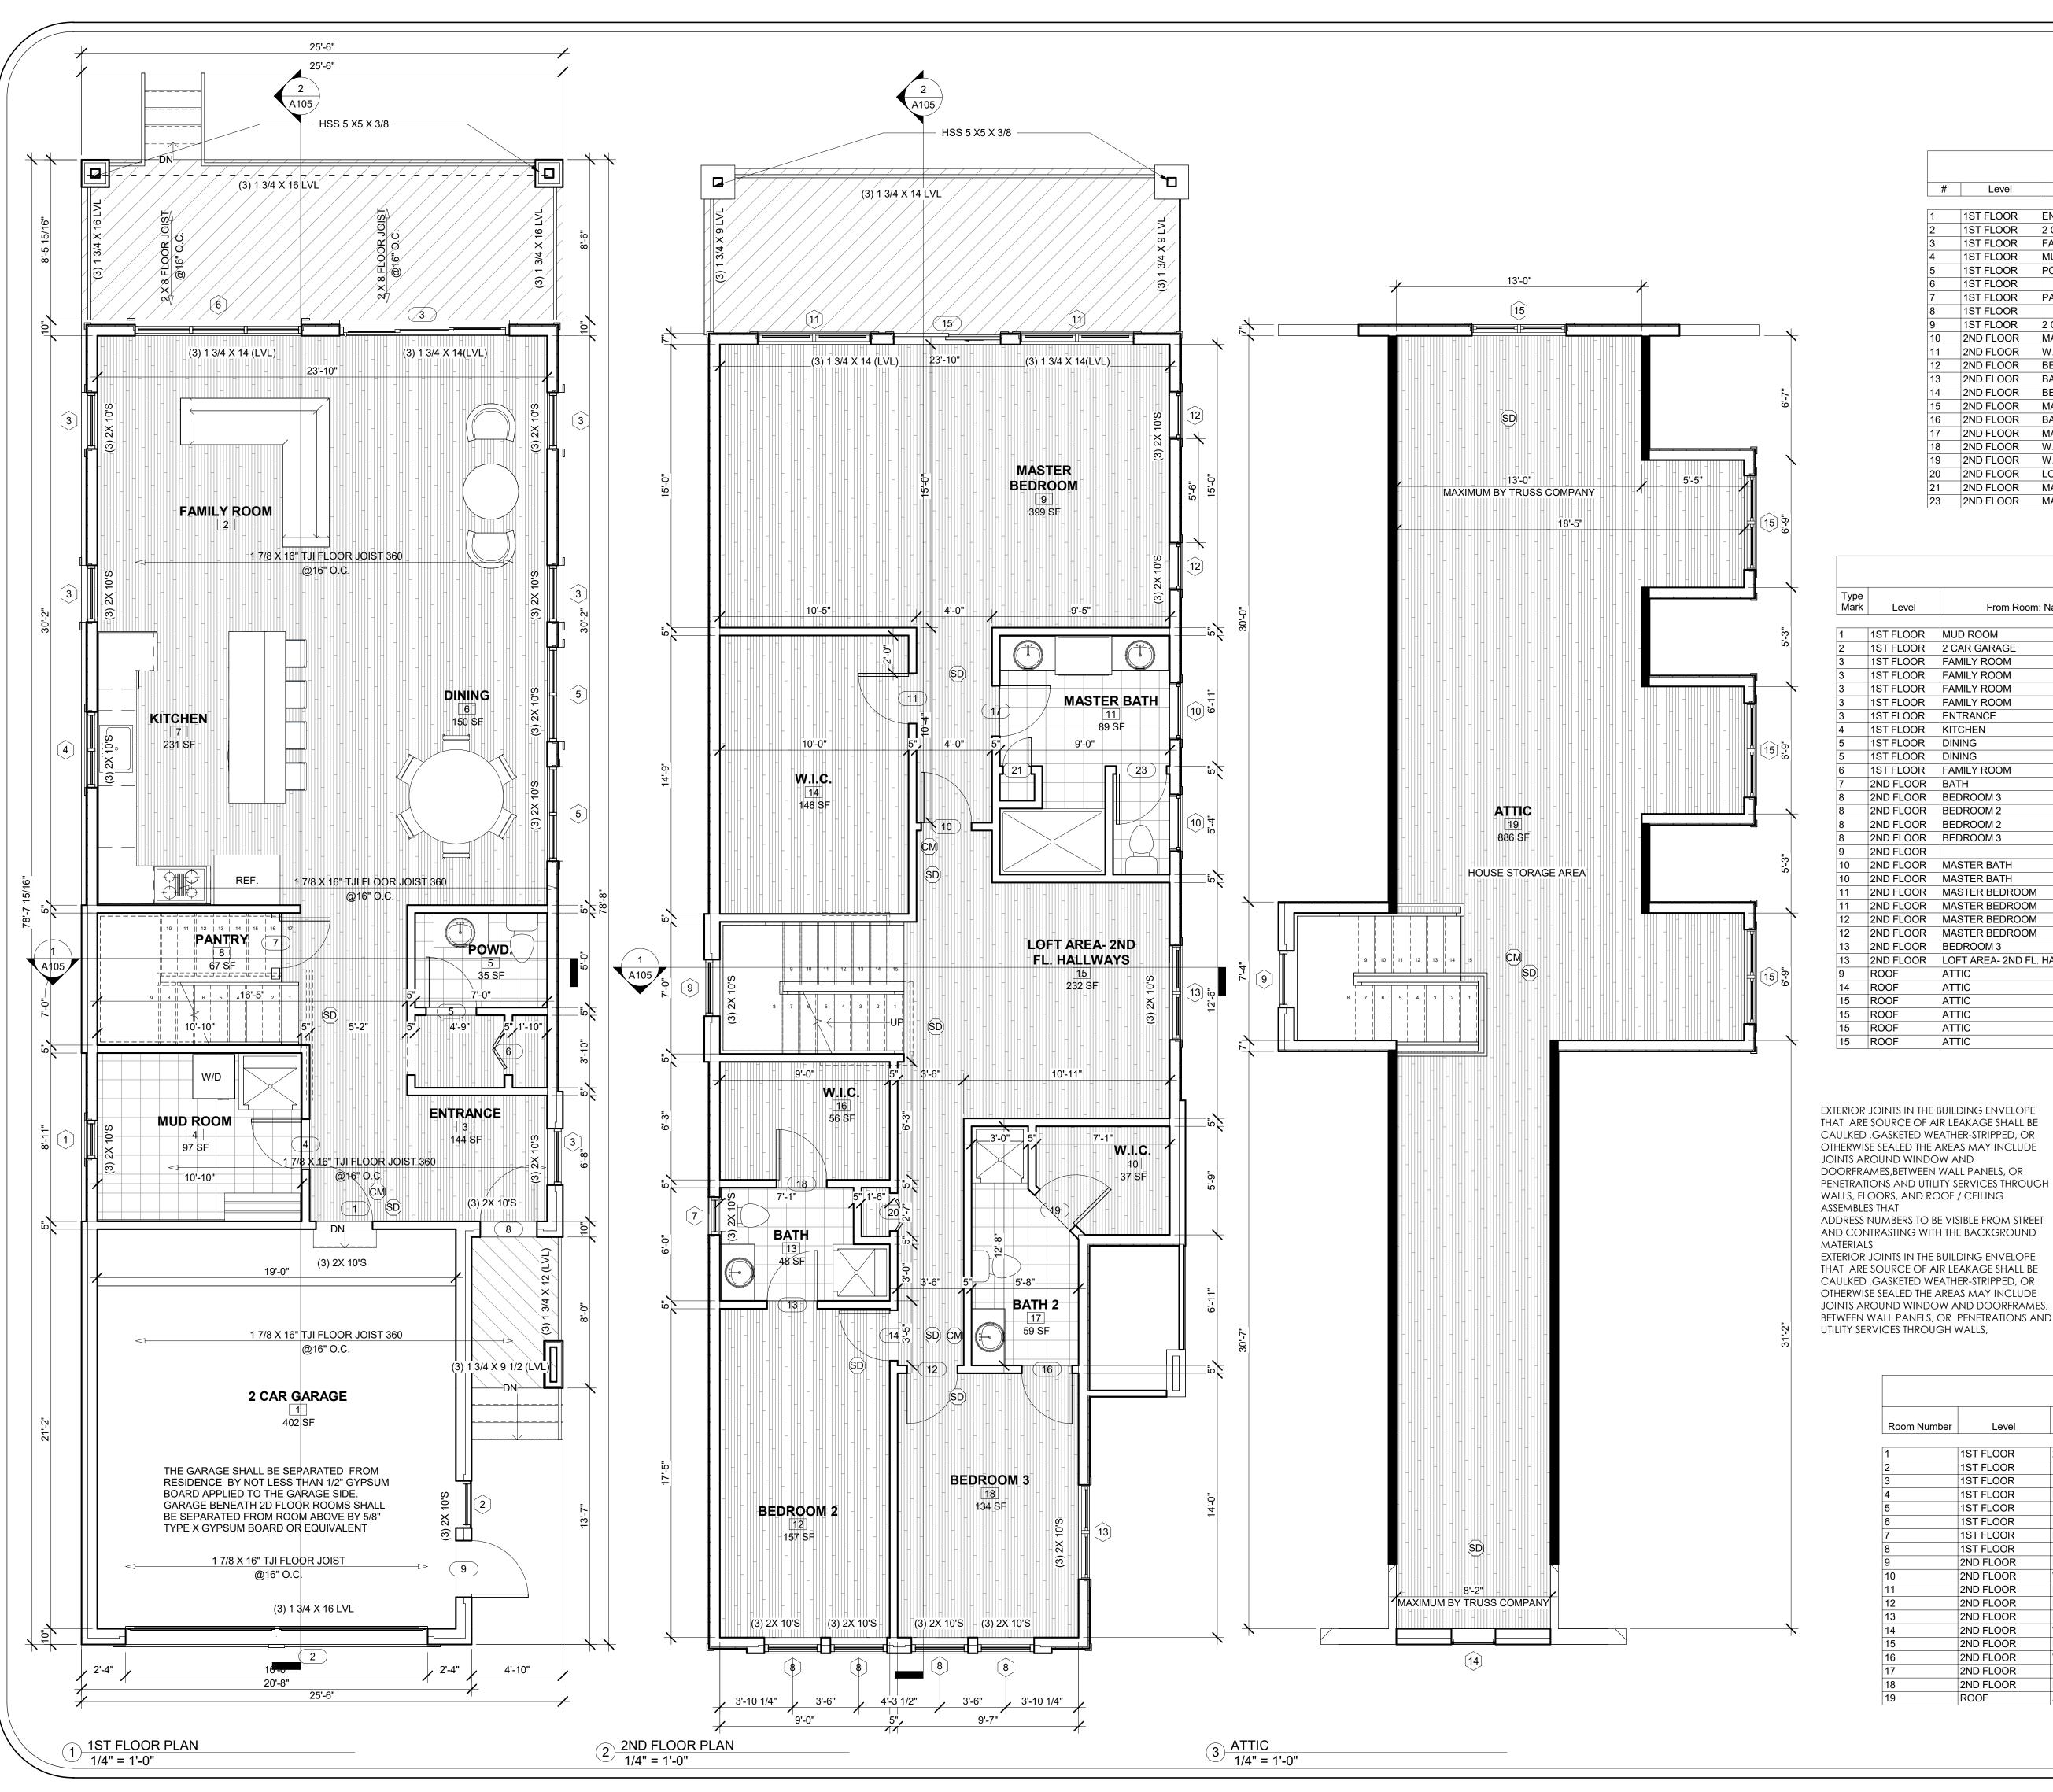1578 SF

2778 SF

2ND FLOOR

		DOOR SCHEDU	JLE	
#	Level	From Room: Name	Description	Widt
1	1ST FLOOR	ENTRANCE	20 MIN FIRE RATED	3' - 0"
2	1ST FLOOR	2 CAR GARAGE	16'-0" X 8'-0" GARAGE DOOR	16' - 0'
3	1ST FLOOR	FAMILY ROOM	3 PANELS SLIDING DOOR	8' - 7"
4	1ST FLOOR	MUD ROOM	2'-8" x 8'-0"	2' - 8"
5	1ST FLOOR	POWD.	2'-8" x 8'-0"	2' - 8"
6	1ST FLOOR		BIFOLD	2' - 6"
7	1ST FLOOR	PANTRY	2'-8" x 8'-0"	2' - 8"
8	1ST FLOOR		MAIN ENTRANCE	3' - 0"
9	1ST FLOOR	2 CAR GARAGE	EXTERIOR DOOR	3' - 0"
10	2ND FLOOR	MASTER BEDROOM	2'-8" x 7'-0"	2' - 8"
11	2ND FLOOR	W.I.C.	2'-8" x 7'-0"	2' - 8"
12	2ND FLOOR	BEDROOM 3	2'-8" x 7'-0"	2' - 8"
13	2ND FLOOR	BATH	2'-8" x 7'-0"	2' - 8"
14	2ND FLOOR	BEDROOM 2	2'-8" x 7'-0"	2' - 8"
15	2ND FLOOR	MASTER BEDROOM	EXTERIOR SLIDING DOOR	5' - 8"
16	2ND FLOOR	BATH 2	2'-8" x 7'-0"	2' - 8"
17	2ND FLOOR	MASTER BEDROOM	2'-8" x 7'-0"	2' - 8"
18	2ND FLOOR	W.I.C.	2'-8" x 7'-0"	2' - 8"
19	2ND FLOOR	W.I.C.	2'-8" x 7'-0"	2' - 8"
20	2ND FLOOR	LOFT AREA- 2ND FL. HALLWAYS	2'-0" BIFOLD	2' - 0"
21	2ND FLOOR	MASTER BATH	CLOSED DOOR	1' - 6"
			+	

		WINDO	N SCHEDI	JLE	
Туре			Rough	Opening	
Mark	Level	From Room: Name	Width	Height	Description
1	1ST FLOOR	MUD ROOM	2' - 0"	4' - 0"	CASEMENT
2	1ST FLOOR	2 CAR GARAGE	2' - 6"	6' - 0"	CASEMENT
3	1ST FLOOR	FAMILY ROOM	3' - 0"	7' - 0"	FIXED TEMPERED
3	1ST FLOOR	FAMILY ROOM	3' - 0"	7' - 0"	FIXED TEMPERED
3	1ST FLOOR	FAMILY ROOM	3' - 0"	7' - 0"	FIXED TEMPERED
3	1ST FLOOR	FAMILY ROOM	3' - 0"	7' - 0"	FIXED TEMPERED
3	1ST FLOOR	ENTRANCE	3' - 0"	7' - 0"	FIXED TEMPERED
4	1ST FLOOR	KITCHEN	4' - 0"	4' - 0"	SLIDING
5	1ST FLOOR	DINING	5' - 0"	7' - 0"	FIXED TEMPERED
5	1ST FLOOR	DINING	5' - 0"	7' - 0"	FIXED TEMPERED
6	1ST FLOOR	FAMILY ROOM	8' - 10"	8' - 0"	3 PANELS FIXED WINDOW- TEMPERED
7	2ND FLOOR	BATH	2' - 0"	4' - 0"	CASEMENT- TEMPERED
3	2ND FLOOR	BEDROOM 3	3' - 0"	5' - 0"	CASEMENT - EGRESS
3	2ND FLOOR	BEDROOM 2	3' - 0"	5' - 0"	CASEMENT - EGRESS
8	2ND FLOOR	BEDROOM 2	3' - 0"	5' - 0"	CASEMENT - EGRESS
8	2ND FLOOR	BEDROOM 3	3' - 0"	5' - 0"	CASEMENT - EGRESS
9	2ND FLOOR		3' - 0"	6' - 0"	STAIR WINDOW
10	2ND FLOOR	MASTER BATH	3' - 0"	4' - 1"	CASEMENT- TEMPERED
10	2ND FLOOR	MASTER BATH	3' - 0"	4' - 1"	CASEMENT- TEMPERED
11	2ND FLOOR	MASTER BEDROOM	6' - 0"	6' - 0"	2 CASEMENT
11	2ND FLOOR	MASTER BEDROOM	6' - 0"	6' - 0"	2 CASEMENT
12	2ND FLOOR	MASTER BEDROOM	2' - 6"	5' - 1"	FIXED- TEMPERED
12	2ND FLOOR	MASTER BEDROOM	2' - 6"	5' - 1"	FIXED- TEMPERED
13	2ND FLOOR	BEDROOM 3	5' - 0"	5' - 0"	2 CASEMENT- EGRESS
13	2ND FLOOR	LOFT AREA- 2ND FL. HALLWAYS	5' - 0"	5' - 0"	2 CASEMENT- EGRESS
9	ROOF	ATTIC	3' - 0"	6' - 0"	STAIR WINDOW
14	ROOF	ATTIC	2' - 4"	3' - 6"	SLOPE TO MATCH ROOF - SEE ELEVATION
15	ROOF	ATTIC	5' - 0"	4' - 0"	2 CASEMENT- EGRESS
15	ROOF	ATTIC	5' - 0"	4' - 0"	2 CASEMENT- EGRESS
15	ROOF	ATTIC	5' - 0"	4' - 0"	2 CASEMENT- EGRESS
15	ROOF	ATTIC	5' - 0"	4' - 0"	2 CASEMENT- EGRESS

23 2ND FLOOR MASTER BATH

EXTERIOR JOINTS IN THE BUILDING ENVELOPE THAT ARE SOURCE OF AIR LEAKAGE SHALL BE CAULKED, GASKETED WEATHER-STRIPPED, OR OTHERWISE SEALED THE AREAS MAY INCLUDE JOINTS AROUND WINDOW AND DOORFRAMES,BETWEEN WALL PANELS, OR

ADDRESS NUMBERS TO BE VISIBLE FROM STREET AND CONTRASTING WITH THE BACKGROUND

EXTERIOR JOINTS IN THE BUILDING ENVELOPE THAT ARE SOURCE OF AIR LEAKAGE SHALL BE CAULKED, GASKETED WEATHER-STRIPPED, OR OTHERWISE SEALED THE AREAS MAY INCLUDE JOINTS AROUND WINDOW AND DOORFRAMES, BETWEEN WALL PANELS, OR PENETRATIONS AND UTILITY SERVICES THROUGH WALLS,

FIELD VERIFY CODE COMPLIANT IS PROVIDED AT THE FOLLOWING LOCATIONS:

A. CONCEALED SPACES OF STUDS, WALLS AND PARTITIONS, INCLUDING FURRED SPACES, AT THE CEILING AND FLOOR LEVEL.

B. ALL INTERCONNECTIONS BETWEEN CONCEALED VERTICAL AND HORIZONTAL SPACES, SUCH AS OCCURS AT SOFFITS, DROP CEILINGS, COVE CEILING.

C. CONCEALED SPACES BETWEEN STAIRS STRINGERS AT THE TOP ANDS BOTTOM OF THE RUN; AND OPENINGS AROUND VENTS, PIPES, DUCTS, CHIMNEYS AND FIREPLACES AT CEILING AND FLOOR LEVEL, WITHOUT NONCOMBUSTIBLE MATERIALS

				Finish
Room Number	Level	Room Name	Area	Floor
1	1ST FLOOR	2 CAR GARAGE	402 SF	
2	1ST FLOOR	FAMILY ROOM	341 SF	
3	1ST FLOOR	ENTRANCE	144 SF	
4	1ST FLOOR	MUD ROOM	97 SF	
5	1ST FLOOR	POWD.	35 SF	
6	1ST FLOOR	DINING	150 SF	
7	1ST FLOOR	KITCHEN	231 SF	
8	1ST FLOOR	PANTRY	67 SF	
9	2ND FLOOR	MASTER BEDROOM	399 SF	
10	2ND FLOOR	W.I.C.	37 SF	
11	2ND FLOOR	MASTER BATH	89 SF	
12	2ND FLOOR	BEDROOM 2	157 SF	
13	2ND FLOOR	BATH	48 SF	
14	2ND FLOOR	W.I.C.	148 SF	
15	2ND FLOOR	LOFT AREA- 2ND FL. HALLWAYS	232 SF	
16	2ND FLOOR	W.I.C.	56 SF	
17	2ND FLOOR	BATH 2	59 SF	
18	2ND FLOOR	BEDROOM 3	134 SF	
19	ROOF	ATTIC	886 SF	

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SHEET TITLE FLOOR PLANS



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<u>CONTRACTOR</u>

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SHEET TITLE **ELEVATIONS**



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<u>DATE</u>

6/23/2023

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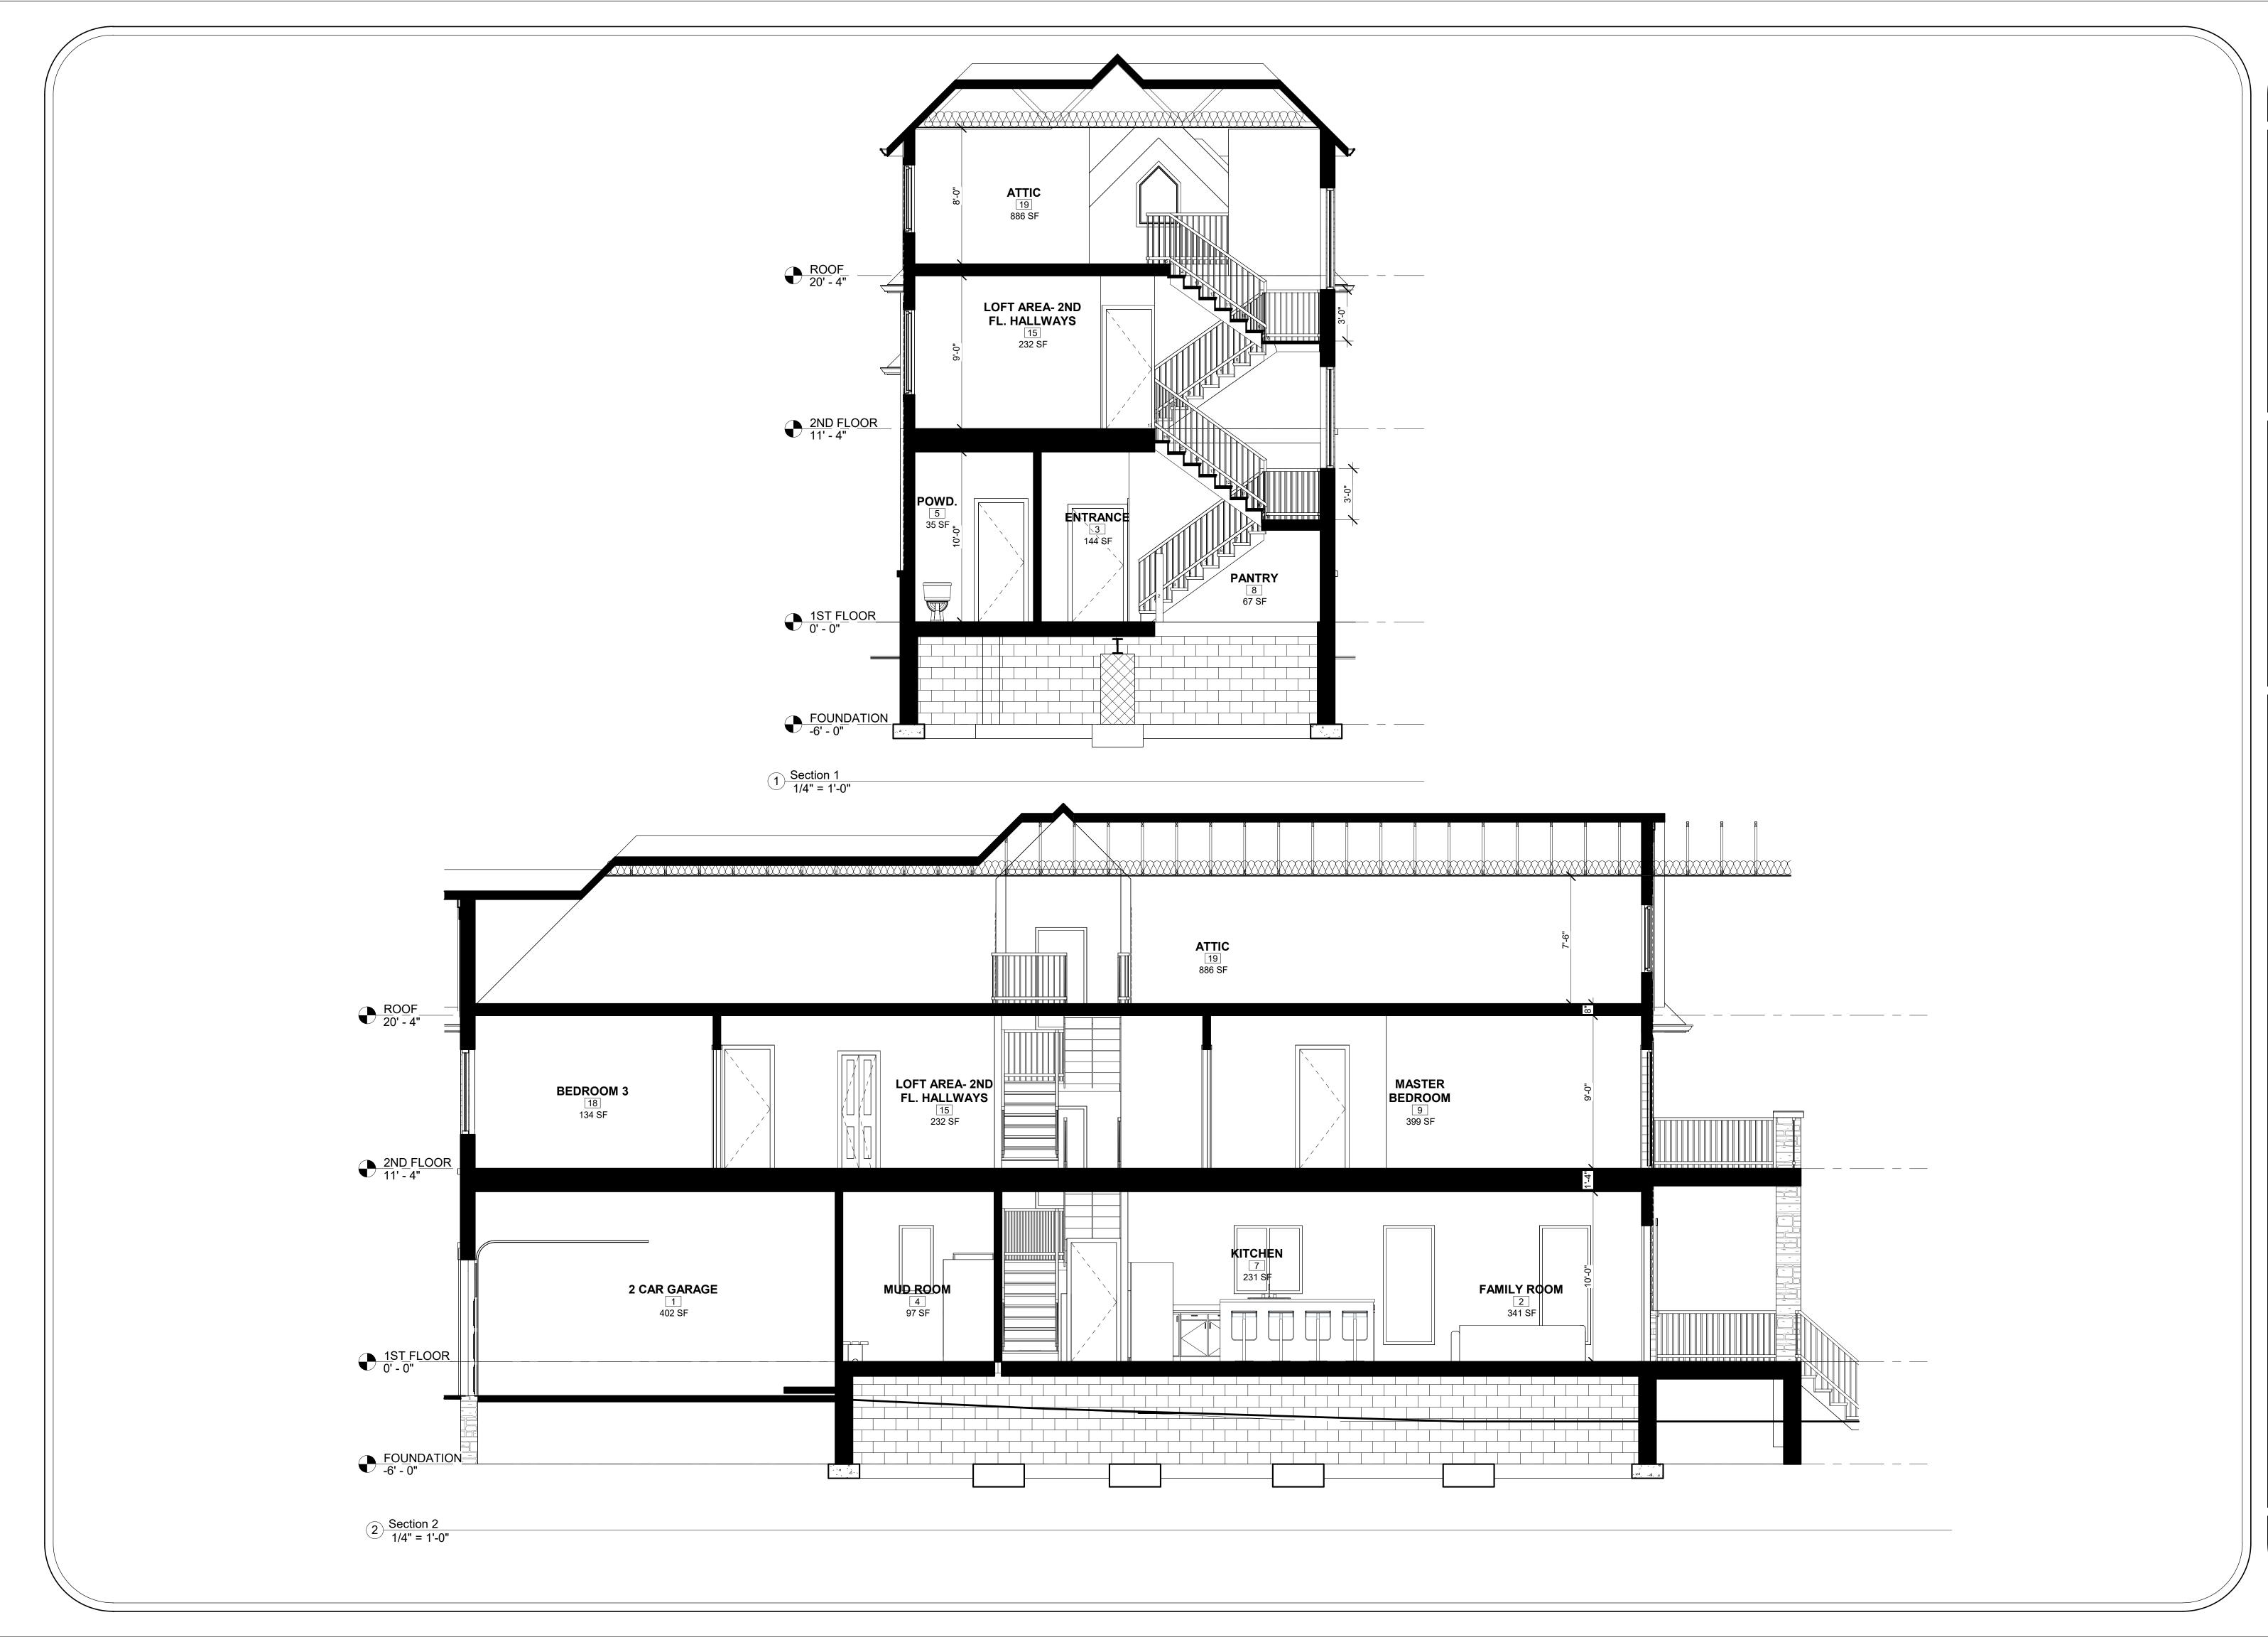
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SHEET TITLE **ELEVATIONS**



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PROJECT: SINGLE FAMILY HOUSE

<u>ADDRESS</u>

1927 W Lake Rd, Novi, MI 48377

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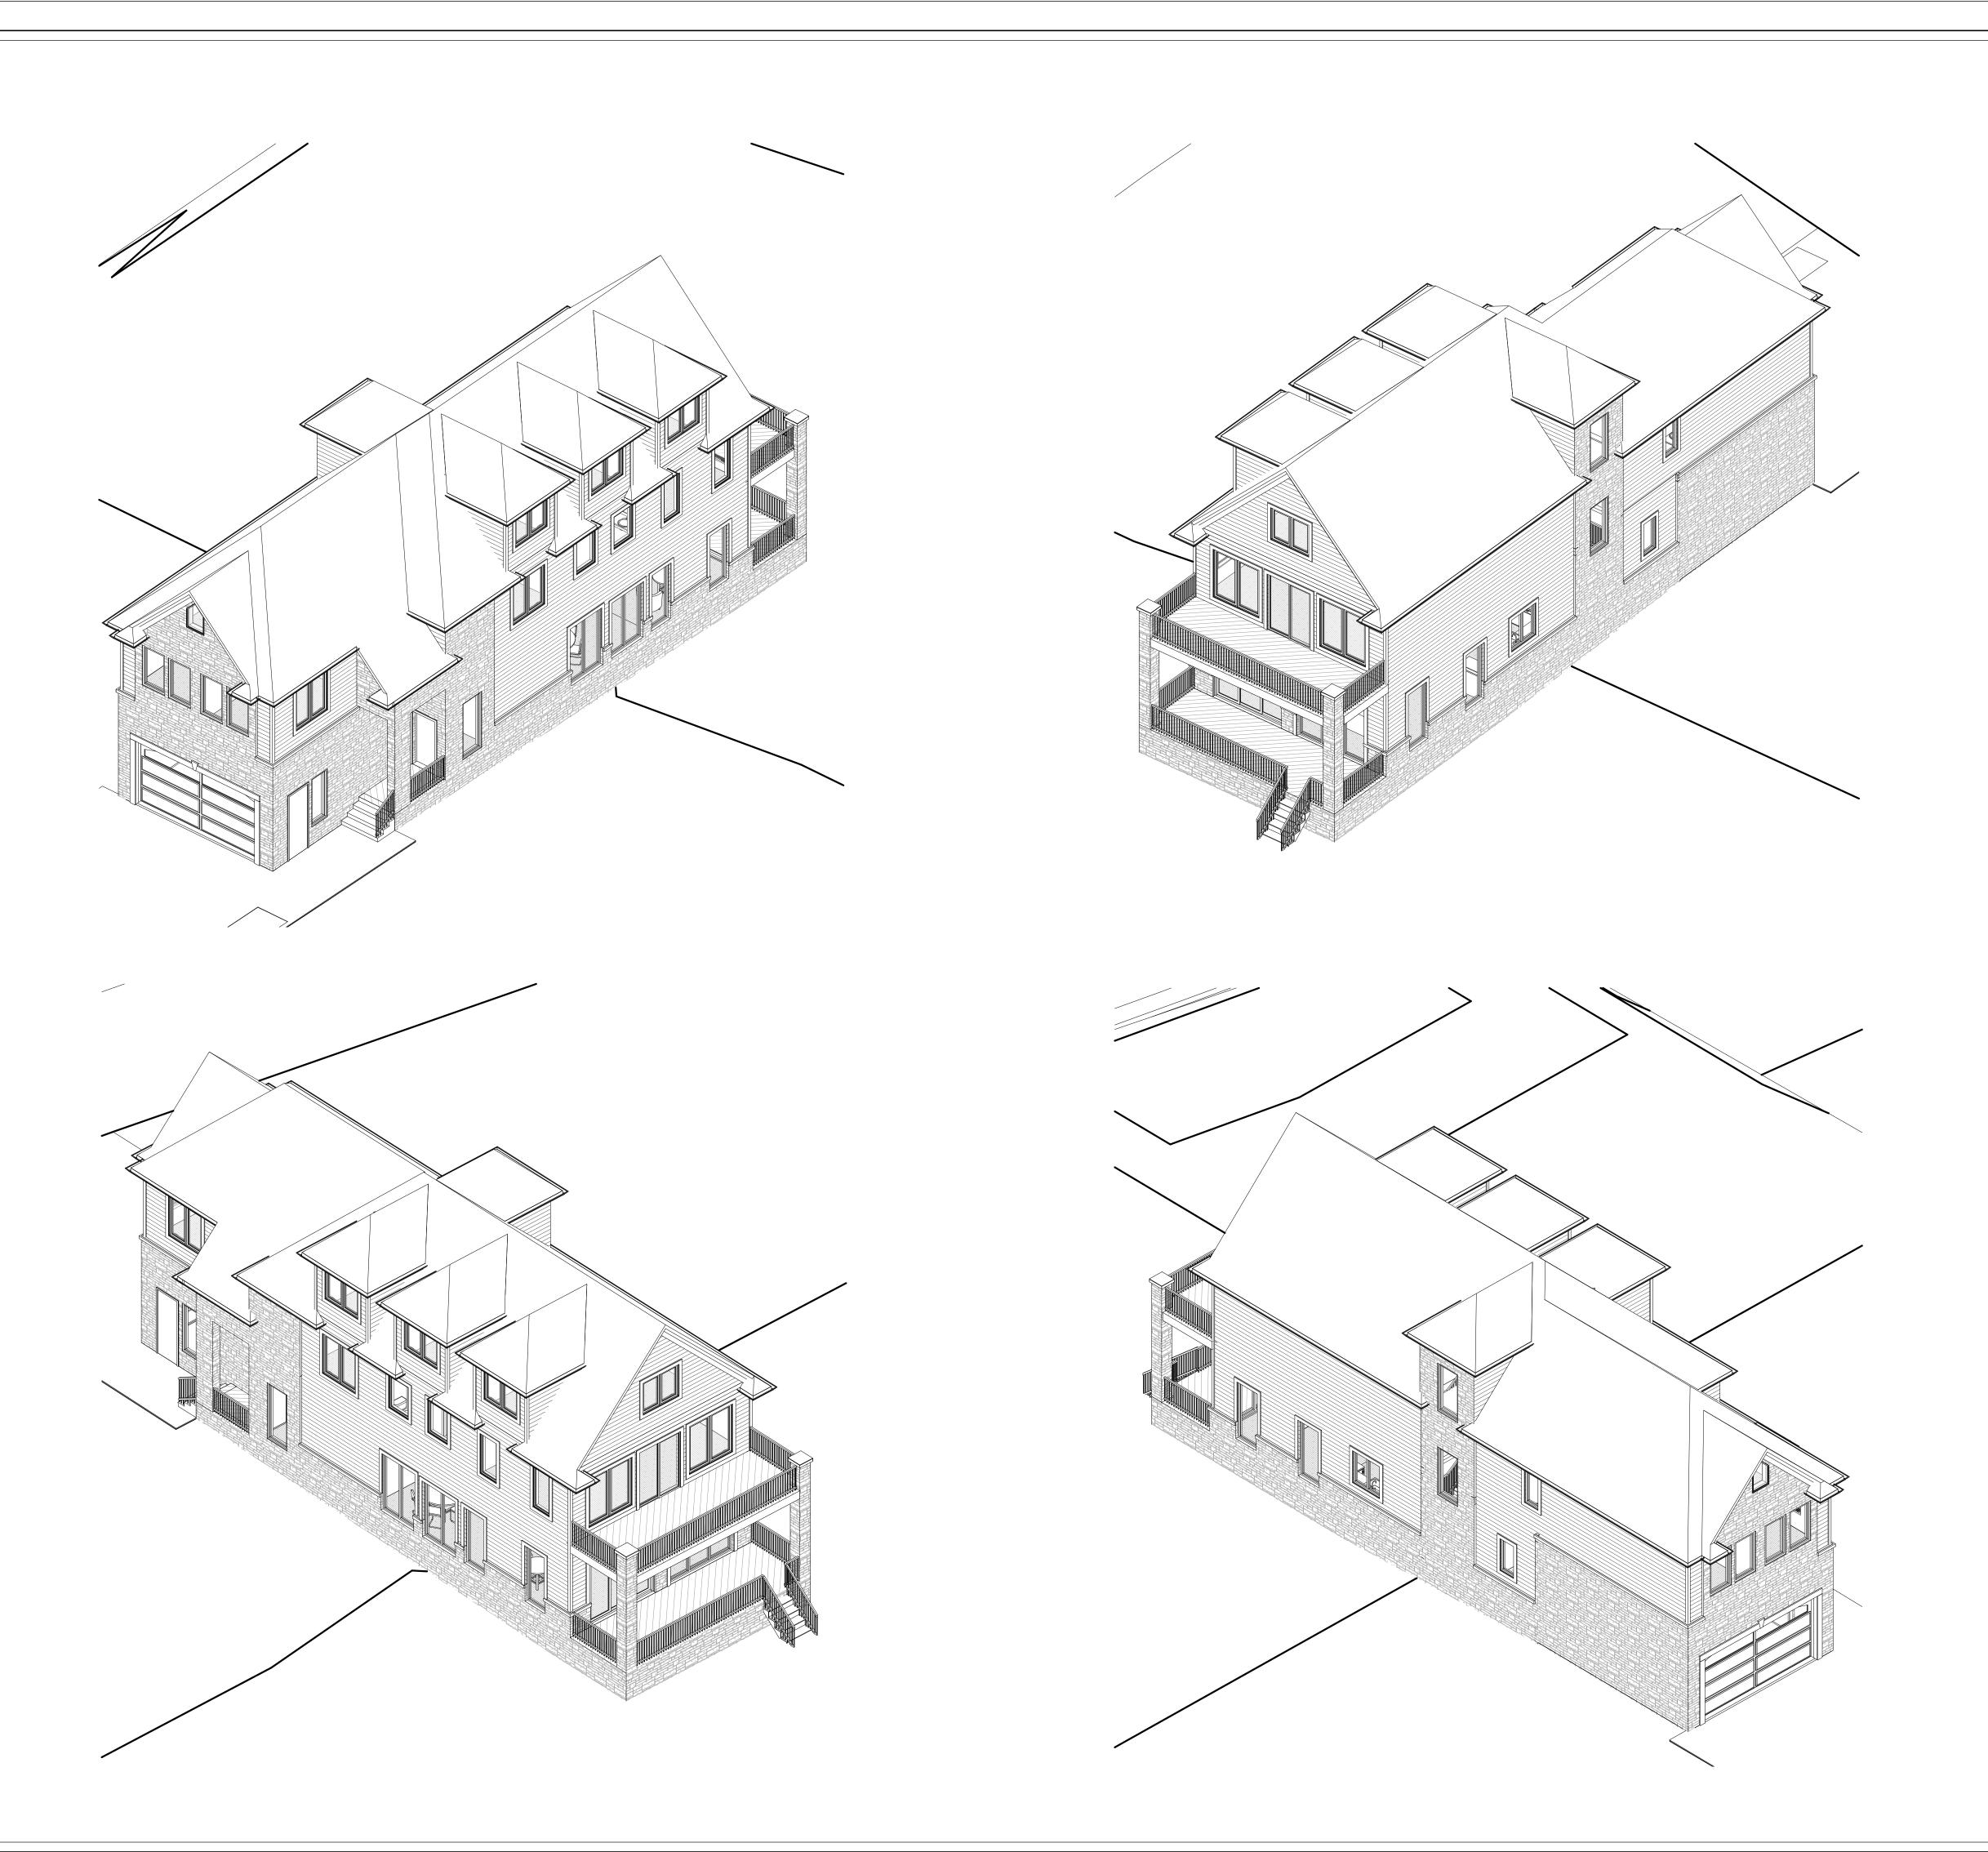
PROJECT NO

<u>DATE</u>

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<u>SCALE</u>

SHEET TITLE SECTIONS



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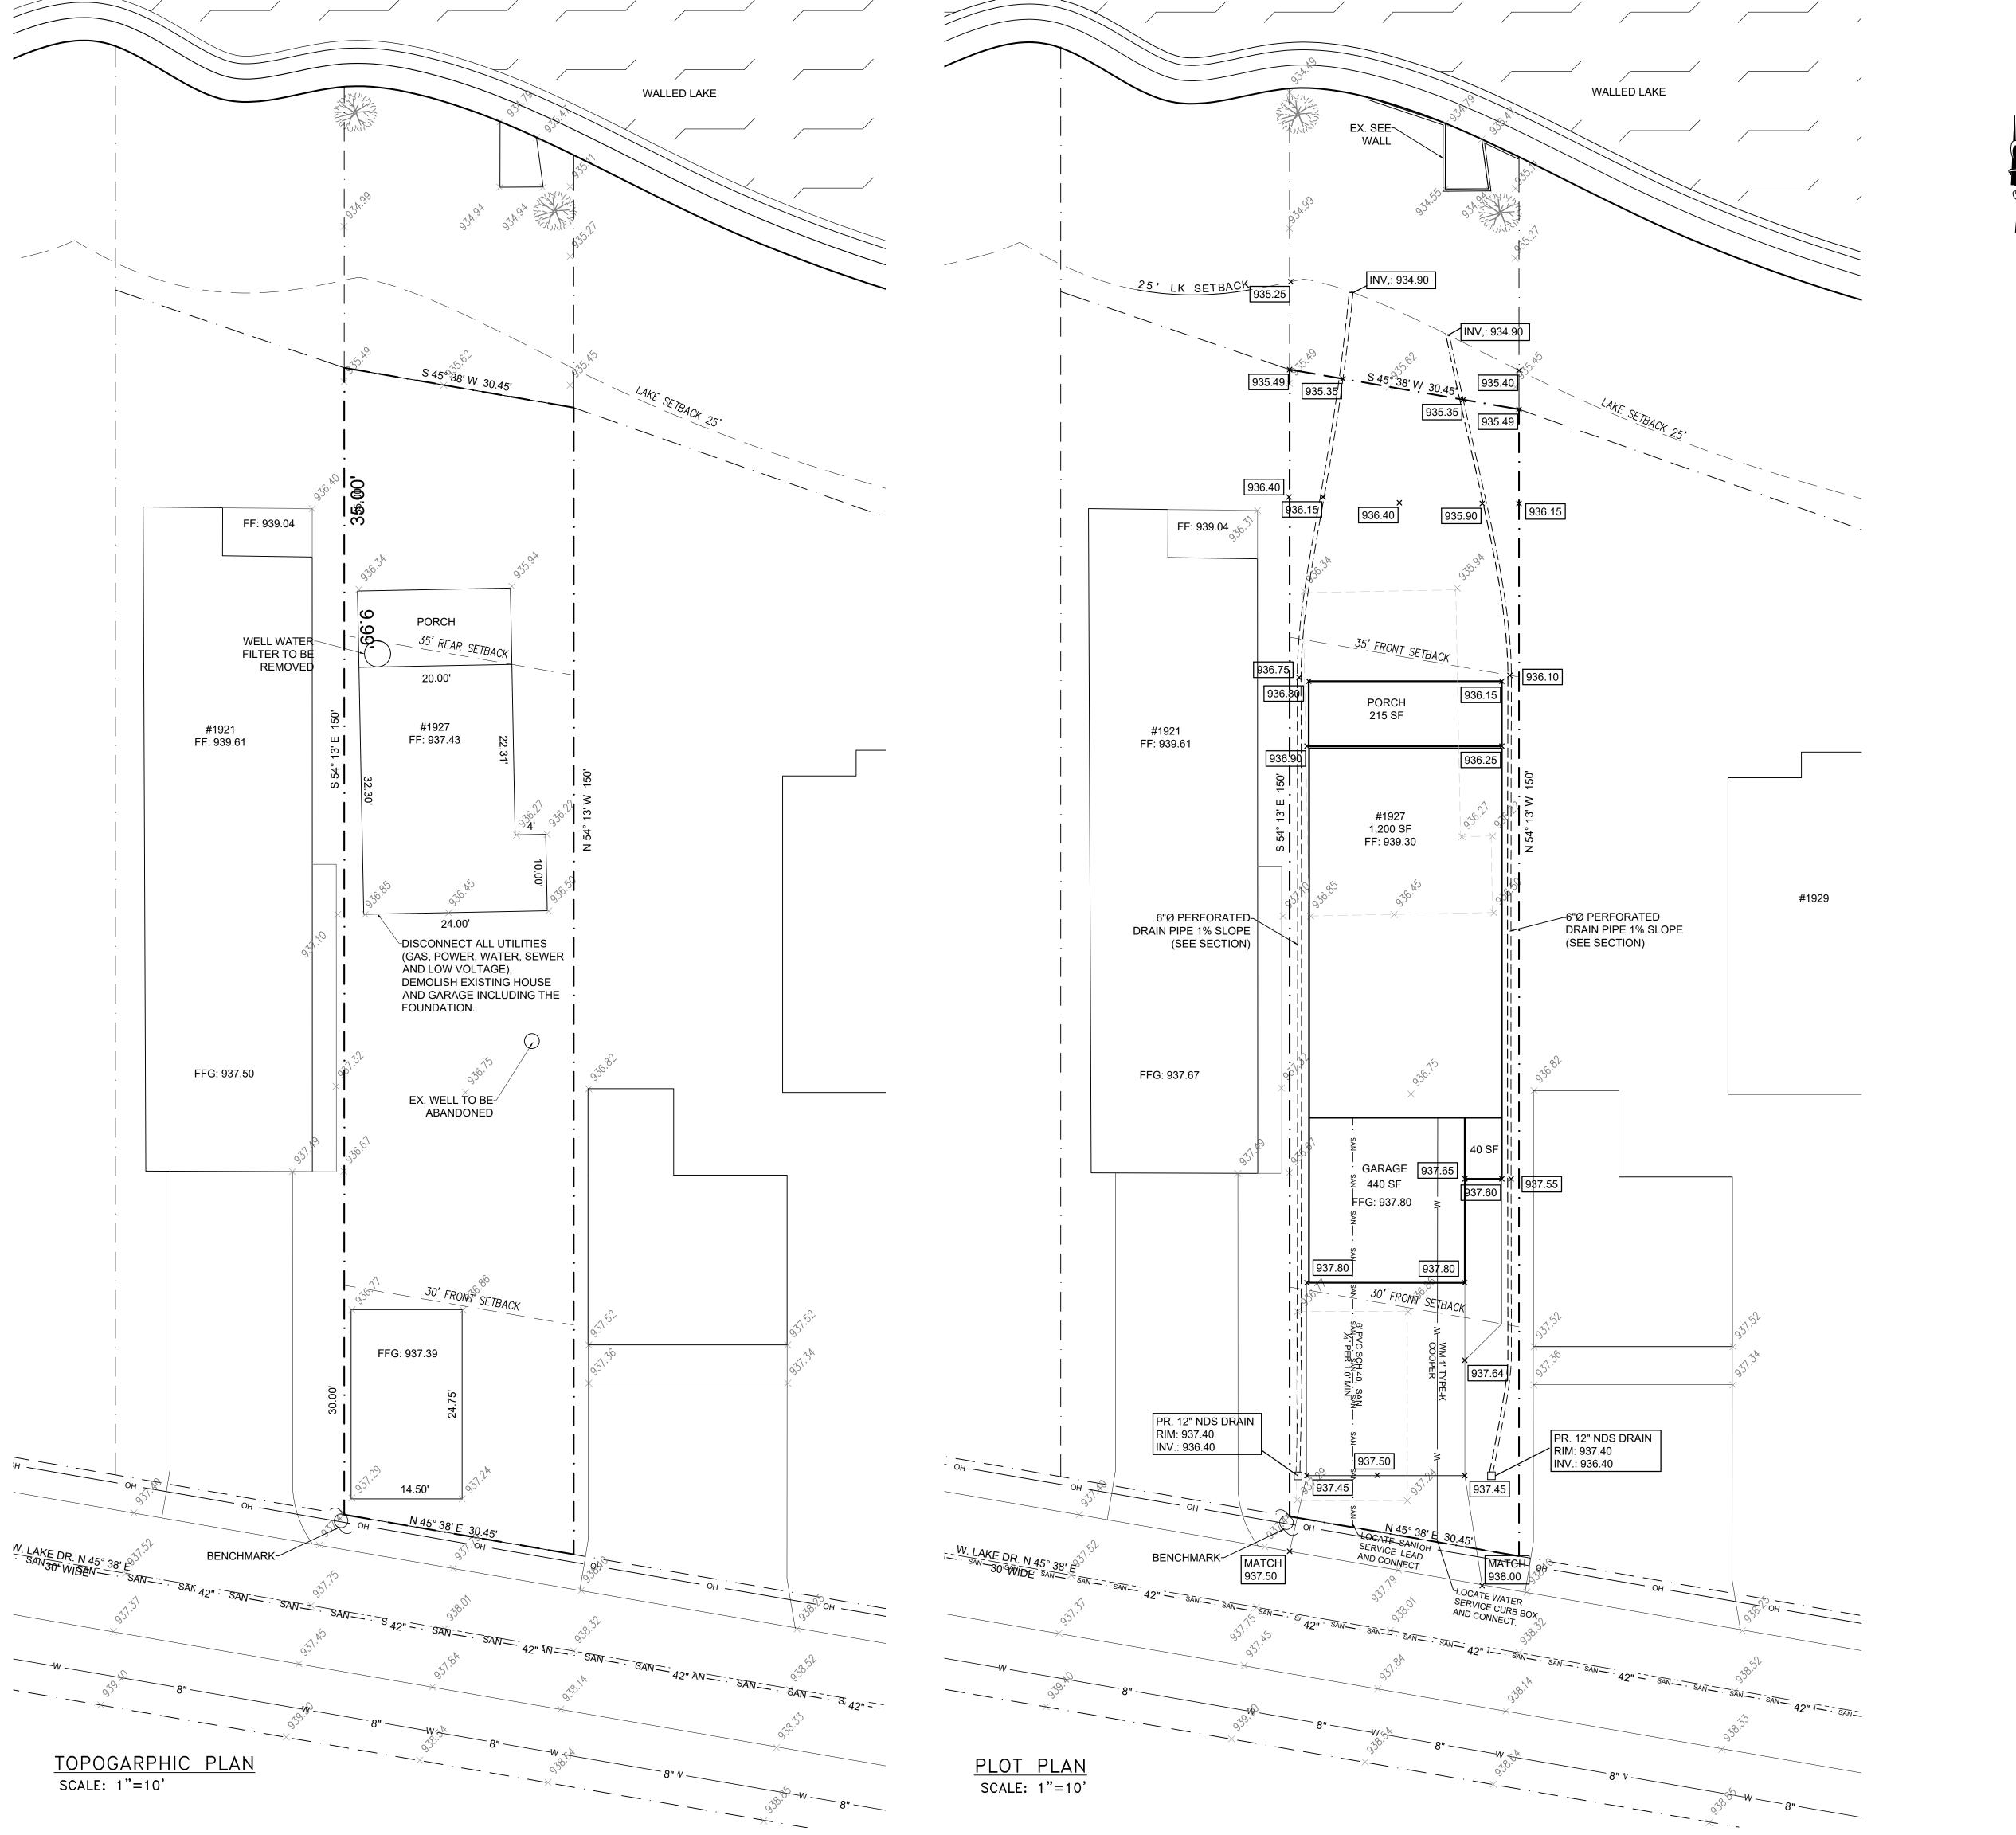
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PROJECT NO

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SHEET TITLE 3D VIEWS





LOCATION MAP

NOT TO SCALE

SITE INFORMATION:
ZONING: R-4
AREA:
4,500 SF ===> 0.10 AC

AREA COVERED:
BUILDING AREA: 1,200 SF
FRONT PORCH: 40 SF
BACK PORCH: 215 SF
GARAGE: 440 SF
1,895 SF

1,896/4,500 x 100%=42.5% ====> 25% MAX.

SETBACKS:

MINIMUM FRONT YARD SETBACK: 30 FT MINIMUM REAR YARD SETBACK: 35 FT

BY GRAPHIC PLOTTING ONLY, THIS PARCEL IS LOCATED WITHIN A FEDERALLY DESIGNATED FLOOD HAZARD AREA ZONE AE. (EL. 934) PER THE FLOOD INSURANCE RATE MAP, MAP NUMBER 26125C0488F, EFFECTIVE DATE OF SEPTEMBER 29, 2006.

MINIMUM SIDE YARD SETBACK: 10 FT ONE SIDE



25 FT TAL 2 SIDES

PREF. PIPE SEXTION
SCALE: 1"=1.0"

BENCH MARK DATA (NAVD-88 DATUM)

BENCHMARK 1
NAIL ON THE WEST SIDE OF
UTILITY POLE.
ELEVATION: 938.81

LEGAL DESCRIPTION: T1N, R8E, SEC 3 BENTLEY SUB LOT 25

	LEGEN	<u>ID</u>	
PROPERTY LINE OVER-HEAD WIRES GAS LINE WATER MAIN SANITARY LINE	GA	AS	GAS ——
STORM LINE	—— STORM	Л	— STORM-
FENCE		_0	<u> </u>
SANITARY SEWER I	MAN HOLE	(SAN.)	
STORM SEWER CA	TCH BASIN		
POWER POLE / LIGH	HT POLE	⊘ PP / LP	•
FIRE HYDRANT		X	
WATER SHOT-OFF		\otimes	
ASPHALT PAVEMEN	NT		
CONCRETE PAVEM	ENT		

SURFACE DRAIN DIRECTION

BEARING CONSTRUCTION CONSULTINGS

L.L.C
32969 HAMILTON CT.
STE. 120
FARMINGTON HILLS, MI
PH:(248) 470-9057

PROJECT

SINGLE FAMILY HOME 1927 W. LAKE DR.

CLIENT

NOVI, MI

REVISIONS

APPROVED BY LARRY MEROGI

SEAL



SCALE:

AS NOTED

6/24/2023

DATE

SHEET TITLE

TOPO AND PLOT PLAN

SHEET

SP-I