

COMMUNITY DEVELOPMENT DEPARTMENT

45175 Ten Mile Road Novi, MI 48375 (248) 347-0415 Phone (248) 735-5600 Facsimile www.cityofnovi.org

ZONING BOARD OF APPEALS STAFF REPORT

FOR: City of Novi Zoning Board of Appeals MEETING DATE: August 13, 2024

REGARDING: 43485 & 43555 Bond Street # 50-22-22-226-009 & 50-22-22-226-008 (PZ24-0035)

BY: Alan Hall, Deputy Director Community Development

GENERAL INFORMATION:

Applicant

The Bond

Variance Type

Dimensional Variance

Property Characteristics

Zoning District: This property is zoned Town Center-1 (TC-1)

Location: south of Grand River Avenue, west of Novi Road

Parcel #: 50-22-22-226-009 & 50-22-22-226-008

Request

The applicant is requesting variances from the City of Novi Zoning Ordinance Section 4.82.2 for increasing the maximum percentage of one-bedroom units allowed for this development (50% maximum allowed, 59% proposed); Section 3.27.1.D to allow parking in the side yard for a commercial building (49 spaces); Section 3.27.1.D to allow parking in front yard for residential section (38 spaces); Section 3.27.1.D to allow parking in side yard for residential section (50 spaces on the east and 35 spaces on the west); Section 4.82.2.e for a reduction of the minimum building setback for Building 1 on the east side (15 ft. required 8.8 ft. proposed); Section 4.82.2.e for a reduction of the minimum building setback for Building 2 on the east side (15 ft. required, 3.8 ft. proposed); Section 4.82.2.e for a reduction of the minimum building setback for the parking garage on the west side (15 ft. required, 5 ft. proposed); Section 5.7.3.L for exceeding the maximum allowed foot candle measurements along the south property line (1 foot candle is allowed, up to 1.7 foot candles is proposed); Section 3.27.1.H. and Section 5.4.2 to allow two loading areas in the side yard for the residential section; Section 5.4.2

The Bond Case # PZ24-0035

for a reduction in the minimum required loading area for each of the two loading spaces in the residential section (2,830 sq. ft. required, 644 sq. ft. provided); Section 3.27.1.I. for a reduction in width of the sidewalk along a non-residential collector (12.5 feet required on both sides, 8 feet proposed on west and 10 feet proposed on east); Section 5.3.2. for a reduction of the minimum parking bay depth for spaces proposed in the parking garage (19 ft. minimum required, 18 ft. proposed). This property is zoned Town Center-1 (TC-1).

II. STAFF COMMENTS:

The applicant is seeking (14) variances.

- 1) 9% increase of one-bedroom units
- 2) To allow (49) parking spaces in the side yard for a commercial building
- 3) To allow (38) parking spaces in the front yard for a residential building
- 4) To allow (50) parking spaces in the east side yard for a residential section
- 5) To allow (35) parking spaces in the west side yard for a residential section
- 6) Building 1 for a 6.2-foot east side building setback variance
- 7) Building 2 for a 11.2-foot east side building setback variance
- 8) Parking Garage for a 10-foot west side building setback variance
- 9) Lighting Variance south property line to allow up to 1.7-foot candles abutting railroad tracks
- 10) To allow (2) loading areas in the side yard for a residential section
- 11) To allow a 77.24% size reduction (2,186 SF variance) for both loading areas
- 12) To allow a 4.5-foot sidewalk width reduction along the west side of a non-residential collector
- 13) To allow a 2.5-foot sidewalk width reduction along the east side of non-residential collector
- 14) To allow a 1-foot reduction of the parking bay depth for the parking garage

History: On August 14, 2018 – Similar variances were approved, but now all have expired.

III. RECOMMENDATION:

The Zoning Board of Appeals may take one of the following actions:

1.	I move that we grant the variance in Case No. PZ24-0035, sought by
	, for
	because Petitioner has shown practical difficulty requiring
	, , , ,
	(a) Without the variance Petitioner will be unreasonably prevented or limited
	with respect to use of the property because

	(b) The property is unique because
	(c) Petitioner did not create the condition because
	(d)The relief granted will not unreasonably interfere with adjacent o
	(e) The relief if consistent with the spirit and intent of the ordinance because
	(f) The variance granted is subject to: 1
	move that we <u>deny</u> the variance in Case No. PZ24-0035 , sought by, for, for, for
_	(a) The circumstances and features of the property including
	are not unique because they exist generally throughout the City. (b) The circumstances and features of the property relating to the variance request are self-created because

` '	The failure to grant relief will result in mere inconvenience or inability to attain higher economic or financial return based on Petitioners statements that
(d)	The variance would result in interference with the adjacent and surrounding properties by
(e)	Granting the variance would be inconsistent with the spirit and intent of the ordinance to

Should you have any further questions with regards to the matter please feel free to contact me at (248) 347-0417.

Alan Hall – Deputy Director Community Development - City of Novi





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ZONING BOARD OF APPEALS APPLICATION

JUN 25 2024

CITY OF NOVI

APPLICATION MUST BE FILLED OUT COMPLETELY COMMUNITY DEVELOPMENT

PROPERTY INFORMATION (Address of subject ZBA Case)			Application Fee:	330.00
PROJECT NAME / SUBDIVISION The Bond		Meeting Date:		
ADDRESS LOT/SIUTE/SPA				
43485 & 43555 Bond Street, Nivi, Mi 48375 SIDWELL # May be obtain from Assessing			ZBA Case #: PZ	24-0035
50-22- <u>22 -226 -008</u>		ent (248) 347-0485		
cross roads of property Bond Street, west of Novi Road				
IS THE PROPERTY WITHIN A HOMEOWNER'S ASS	OCIATION JURISDICTION?	REQUEST IS FOR:		ACREPTY A SIGNA OF
	TOT OF 1/10/1 OF	RESIDENTIAL COM		ROPERTY LI SIGNAGE
DOES YOUR APPEAL RESULT FROM A NOT	ICE OF VIOLATION OR	CITATION ISSUED? Y	es 🗆 no	
	EMAIL ADDRESS		CELL PHONE NO.	
A. APPLICANT	albert@tricapre.cc	om	248-761-6909	
NAME Albert Ludwig			TELEPHONE NO. 248-538-1483	
ORGANIZATION/COMPANY			FAX NO.	
The Bond at Novi LLC		CITY	248-538-1526 STATE	ZIP CODE
30600 Northwestern Suite 430		Farmington Hills	Mi	48334
B. PROPERTY OWNER 🗹 CHECK HE	ERE IF APPLICANT IS ALSO	THE PROPERTY OWNER		
Identify the person or organization that owns the subject property:	EMAIL ADDRESS		CELL PHONE NO.	
NAME			TELEPHONE NO.	
ODC AND A TION I COMPANY				
ORGANIZATION/COMPANY			FAX NO.	
ADDRESS CITY			STATE	ZIP CODE
III. ZONING INFORMATION				
A. ZONING DISTRICT				
□ R-A □ R-1 □ R-2	□ R-3 □ R-4		□ MH	
☐ I-1 ☐ I-2 ☐ RC B. VARIANCE REQUESTED	□ TC IC-1	OTHER	-	
INDICATE ORDINANCE SECTION (S) AND	VARIANCE REQUESTED:			
4 00 0	/ariance requested	Please see attached		
2. Section\				
	·	: <u>-</u>		
	Variance requested	-		
4. Section Variance requested				
IV. FEES AND DRAWNINGS				
A. FEES ☐ Single Family Residential (Existing) \$220 ☐ (With Violation) \$275 ☐ Single Family Residential (New) \$275				
✓ Multiple/Commercial/Industrial \$330 ☐ (With Violation) \$440 ☐ Signs \$330 ☐ (With Violation) \$440				
☐ House Moves \$330 ☐ Special Meetings (At discretion of Board) \$660				
B. DRAWINGS 1-COPY & 1 DIGITAL COPY SUBMITTED AS A PDF				
Dimensioned Drawings and Plans Existing & proposed distance to adjacent property lines Site (Plat Plan) A section of existing & proposed distance to adjacent property lines				
 Site/Plot Plan Existing or proposed buildings or addition on the property Existing or proposed buildings or addition on the property Floor plans & elevations 				
 Number & location of all on-site parking, if applicable Any other information relevant to the Variance application 				



ZONING BOARD OF APPEALS APPLICATION

V. VARIANCE		
A. VARIANCE (S) REQUESTED		
M DIMENSIONAL USE SIGN		
There is a five-(5) hold period before work/action can be taken on variance approvals.		
B. SIGN CASES (ONLY) Your signature on this application indicates that you agree to install a Mock-Up Sign ten-(10) days before the schedule ZBA meeting. Failure to install a mock-up sign may result in your case not being heard by the Board, postponed to the next schedule ZBA meeting, or cancelled. A mock-up sign is NOT to be actual sign. Upon approval, the mock-up sign must be removed within five-(5) days of the meeting. If the case is denied, the applicant is responsible for all costs involved in the removal of the mock-up or actual sign (if erected under violation) within five-(5) days of the meeting.		
C. ORDINANCE		
City of Novi Ordinance, Section 3107 – Miscellaneous		
No order of the Board permitting the erection of a building shall be valid for a period longer than one-(1) year, unless a building permit for such erection or alteration is obtained within such period and such erection or alteration is started and proceeds to completion in accordance with the terms of such permit.		
No order of the Board permitting a use of a building or premises shall be valid for a period longer than one-hundred and eighty-(180) days unless such use is establish within such a period; provided, however, where such use permitted is dependent upon the erection or alteration or a building such order shall continue in force and effect if a building permit for such erection or alteration is obtained within one-(1) year and such erection or alteration is started and proceeds to completion in accordance with the terms of such permit.		
D. APPEAL THE DETERMINATION OF THE BUILDING OFFICIAL		
PLEASE TAKE NOTICE:		
The undersigned hereby appeals the determination of the Building Official / Inspector or Ordinance made CONSTRUCT NEW HOME/BUILDING		
VI. APPLICANT & PROPERTY SIGNATURES		
A. APPLICANT Applicant Signature L-24-2024 Date		
B. PROPERTY OWNER		
If the applicant is not the owner, the property owner must read and sign below: The understand affirms and acknowledges that he, she or they are the owner(s) of the property described in this application, and is/are aware of the contents of this application and related enclosures.		
Proberty Owner Signature Mapager of DIN Accel Management + Development LCC, Date Minnager of DTN Brand at Novi, LLC Date		
Millinager of DTN Brid at Novi, UC		
VII. FOR OFFICIAL USE ONLY		
DECISION ON APPEAL:		
GRANTED DENIED The Building Inspector is hereby directed to issue a permit to the Applicant upon the following and conditions:		
Chairperson, Zoning Board of Appeals Date		



Community Development Department

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REVIEW STANDARDS DIMENSIONAL VARIANCE

The Zoning Board of Appeals (ZBA) will review the application package and determine if the proposed Dimensional Variance meets the required standards for approval. In the space below, and on additional paper if necessary, explain how the proposed project meets each of the following standards. (Increased costs associated with complying with the Zoning Ordinance will not be considered a basis for granting a Dimensional Variance.)

Standard #1. Circumstances or Physical Conditions.

Explain the circumstances or physical conditions that apply to the property that do not apply generally to other properties in the same zoning district or in the general vicinity. Circumstances or physical conditions may include:

	Shape of Lot. Exceptional narrowness, shallowness or shape of a specific property in existence on the effective date of the Zoning Ordinance or amendment. ☐ Not Applicable
	and/or
b.	Environmental Conditions. Exceptional topographic or environmental conditions or other extraordinary situations on the land, building or structure. ✓ Not Applicable ☐ Applicable If applicable, describe below:
	and/or
c.	Abutting Property. The use or development of the property immediately adjacent to the subject property would prohibit the literal enforcement of the requirements of the Zoning Ordinance or would involve significant practical difficulties. Not Applicable

Standard #2. Not Self-Created.

Describe the immediate practical difficulty causing the need for the Dimensional Variance, that the need for the requested variance is not the result of actions of the property owner or previous property owners (i.e., is not self-created).

Narrow depth of property resulting in needed variances that were prepiously approved but have expired.

Standard #3. Strict Compliance.

Explain how the Dimensional Variance in strict compliance with regulations governing area, setback, frontage, height, bulk, density or other dimensional requirements will unreasonably prevent the property owner from using the property for a permitted purpose, or will render conformity with those regulations unnecessarily burdensome.

Narrow depth of property resulting in needed variances that were previously approved but have expired.

Standard #4. Minimum Variance Necessary.


Explain how the Dimensional Variance requested is the minimum variance necessary to do substantial justice to the applicant as well as to other property owners in the district.


This property is an orphan site and does not impact other properties. It is within the T-1 district to provide residents for the downdown area to thrive.


Standard #5. Adverse Impact on Surrounding Area.

Explain how the Dimensional Variance will not cause an adverse impact on surrounding property, property values, or the use and enjoyment of property in the neighborhood or zoning district.


The property has no neighbors. Roads, river and cemetery on both sides and the front, and railroad tracks in the rear.

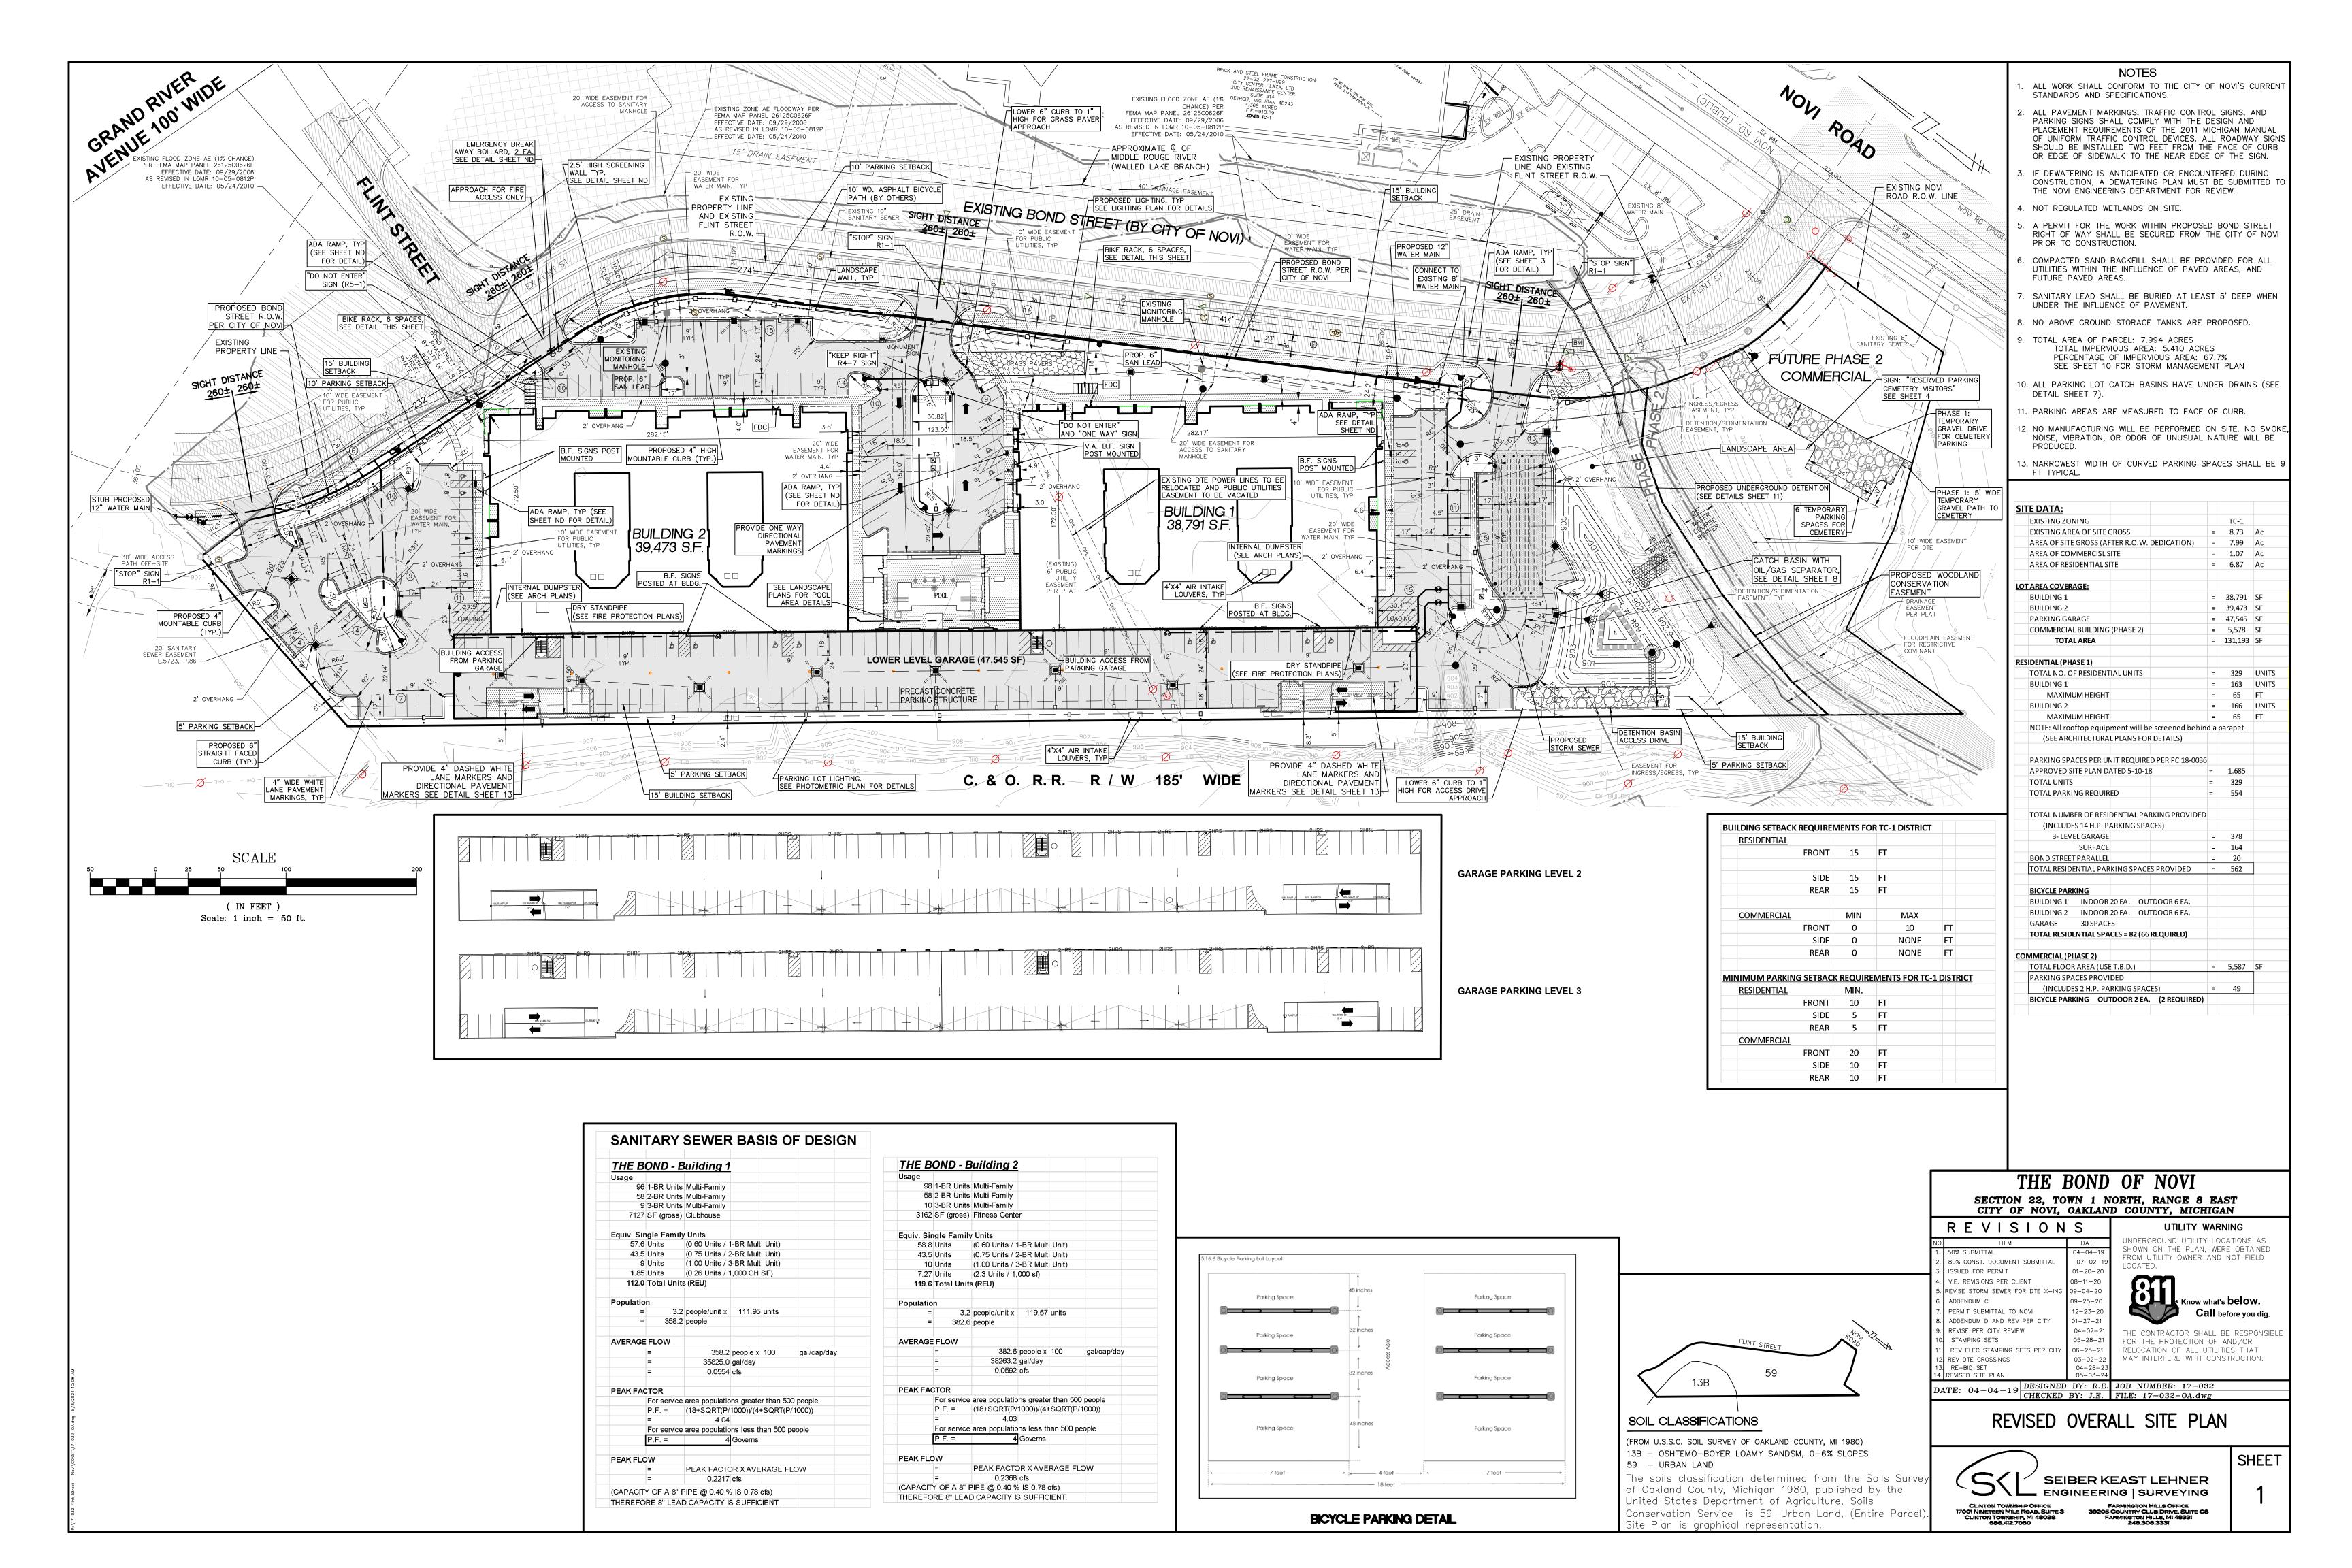

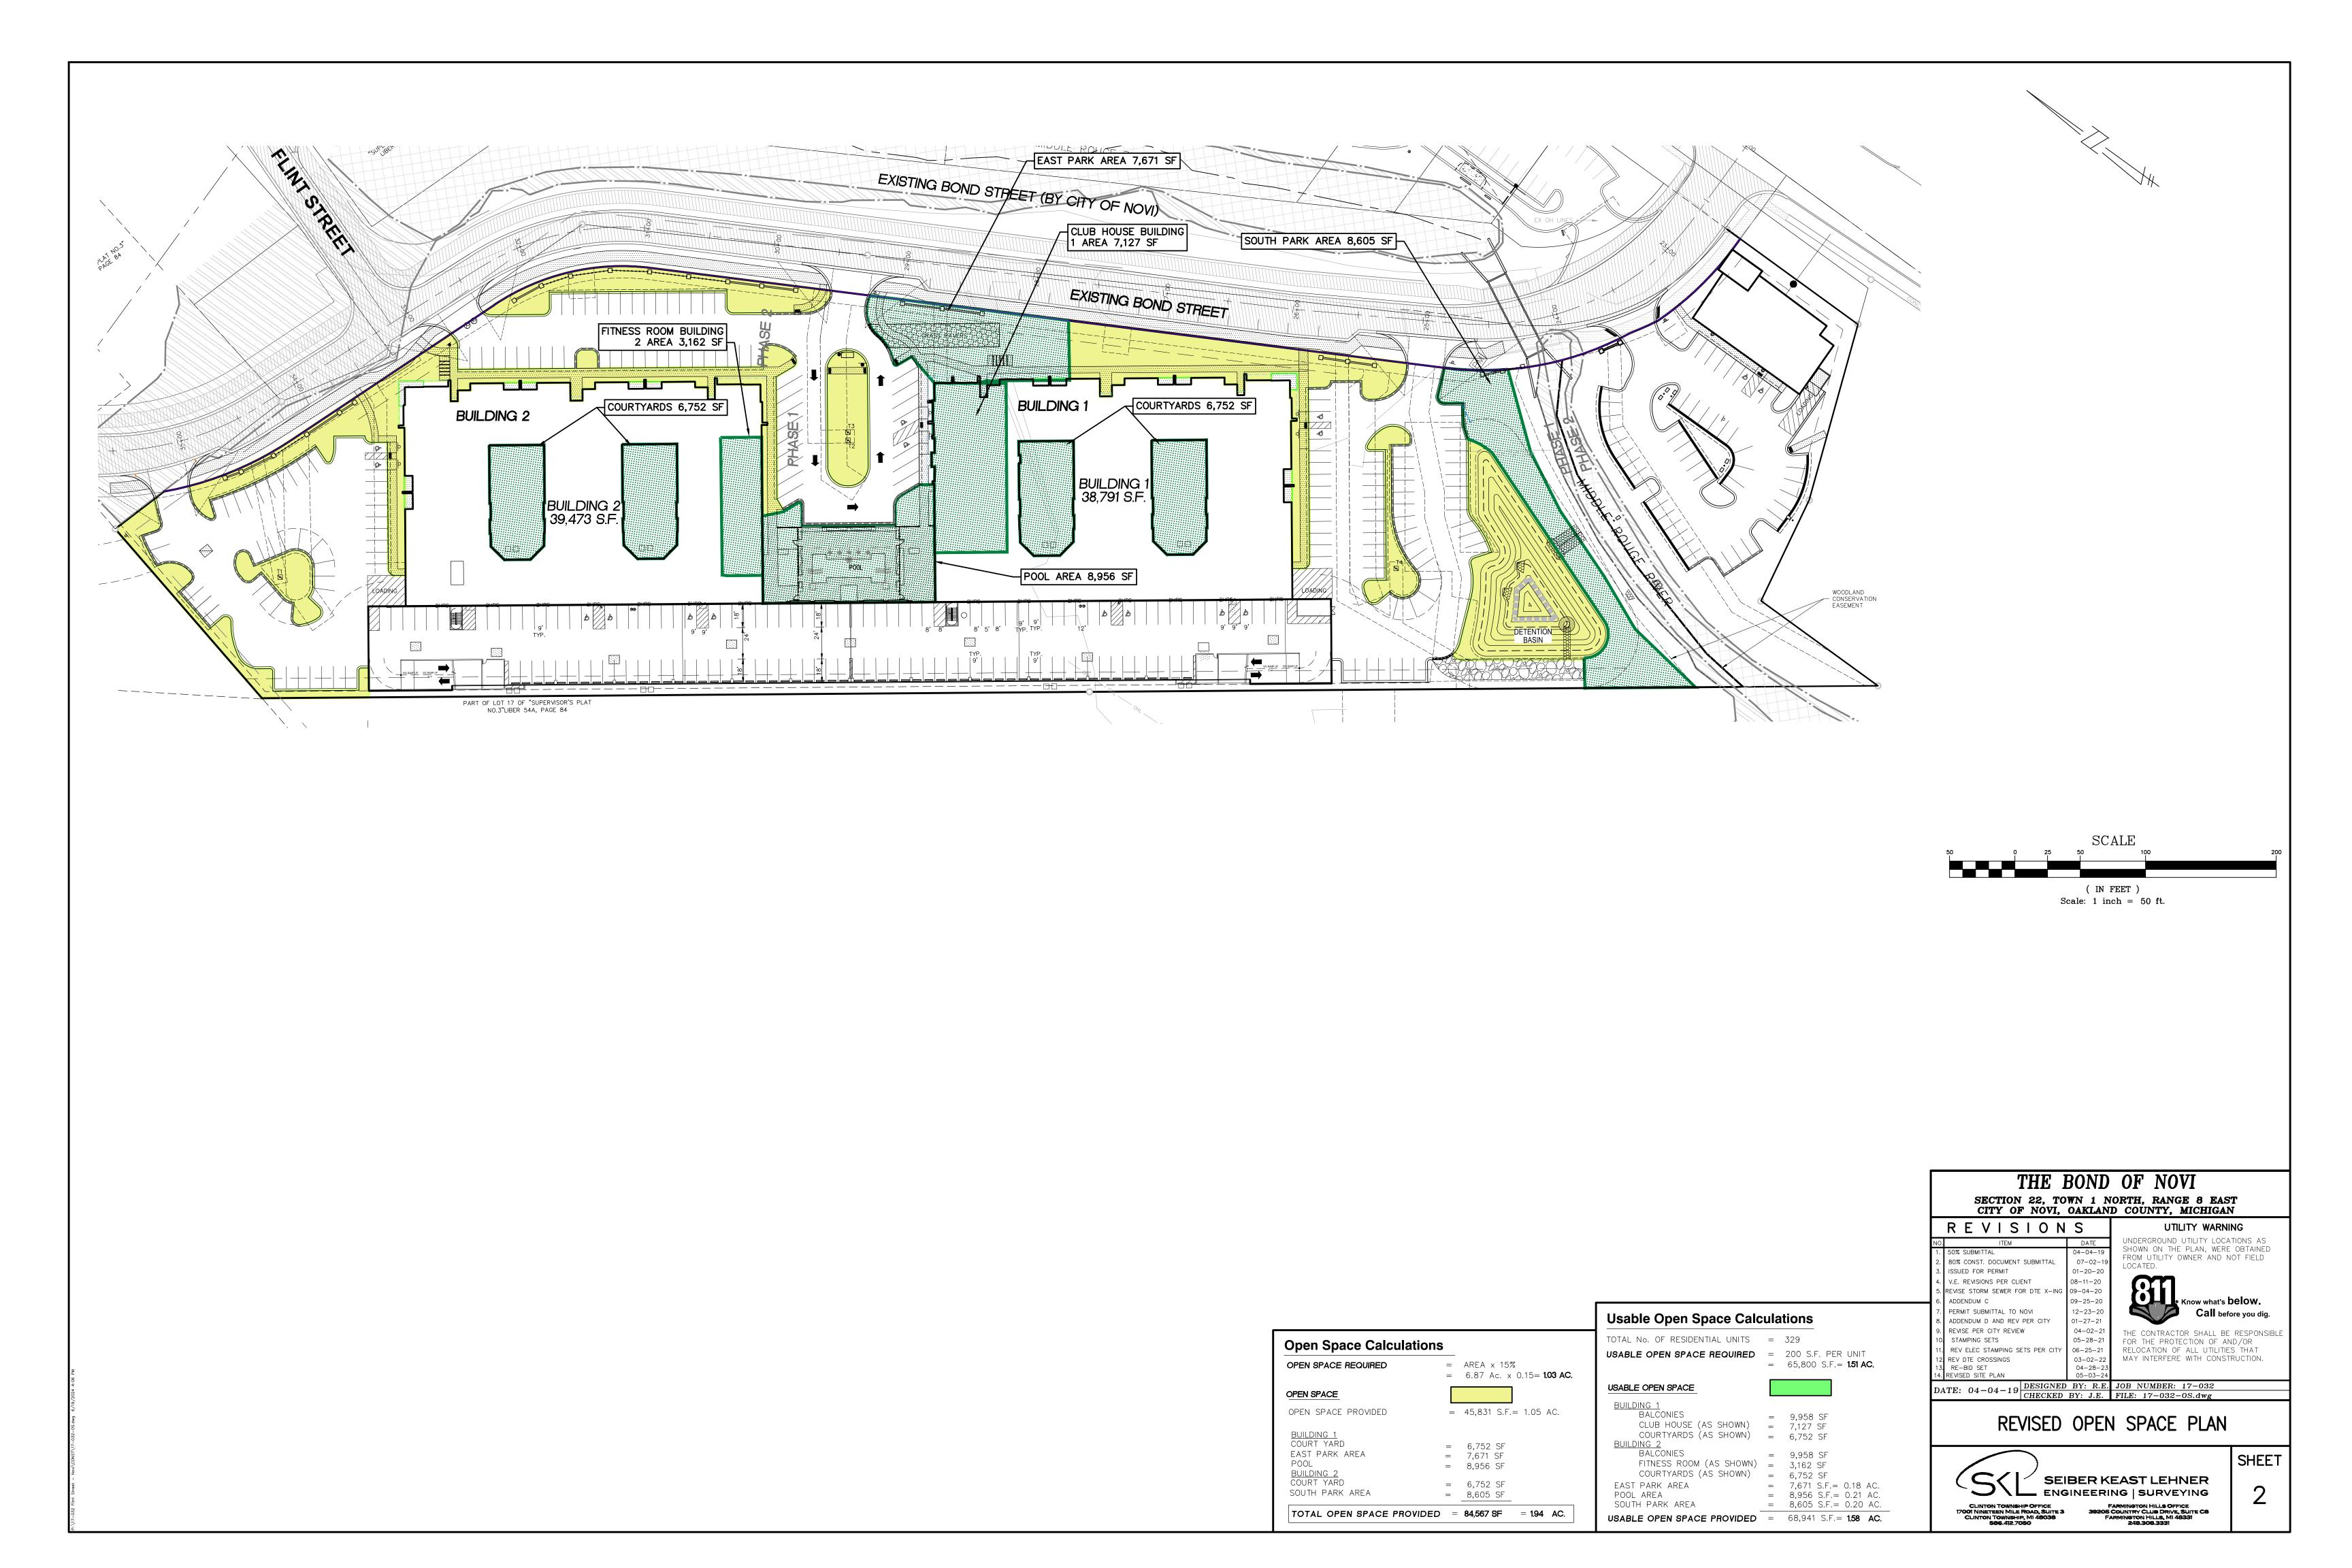


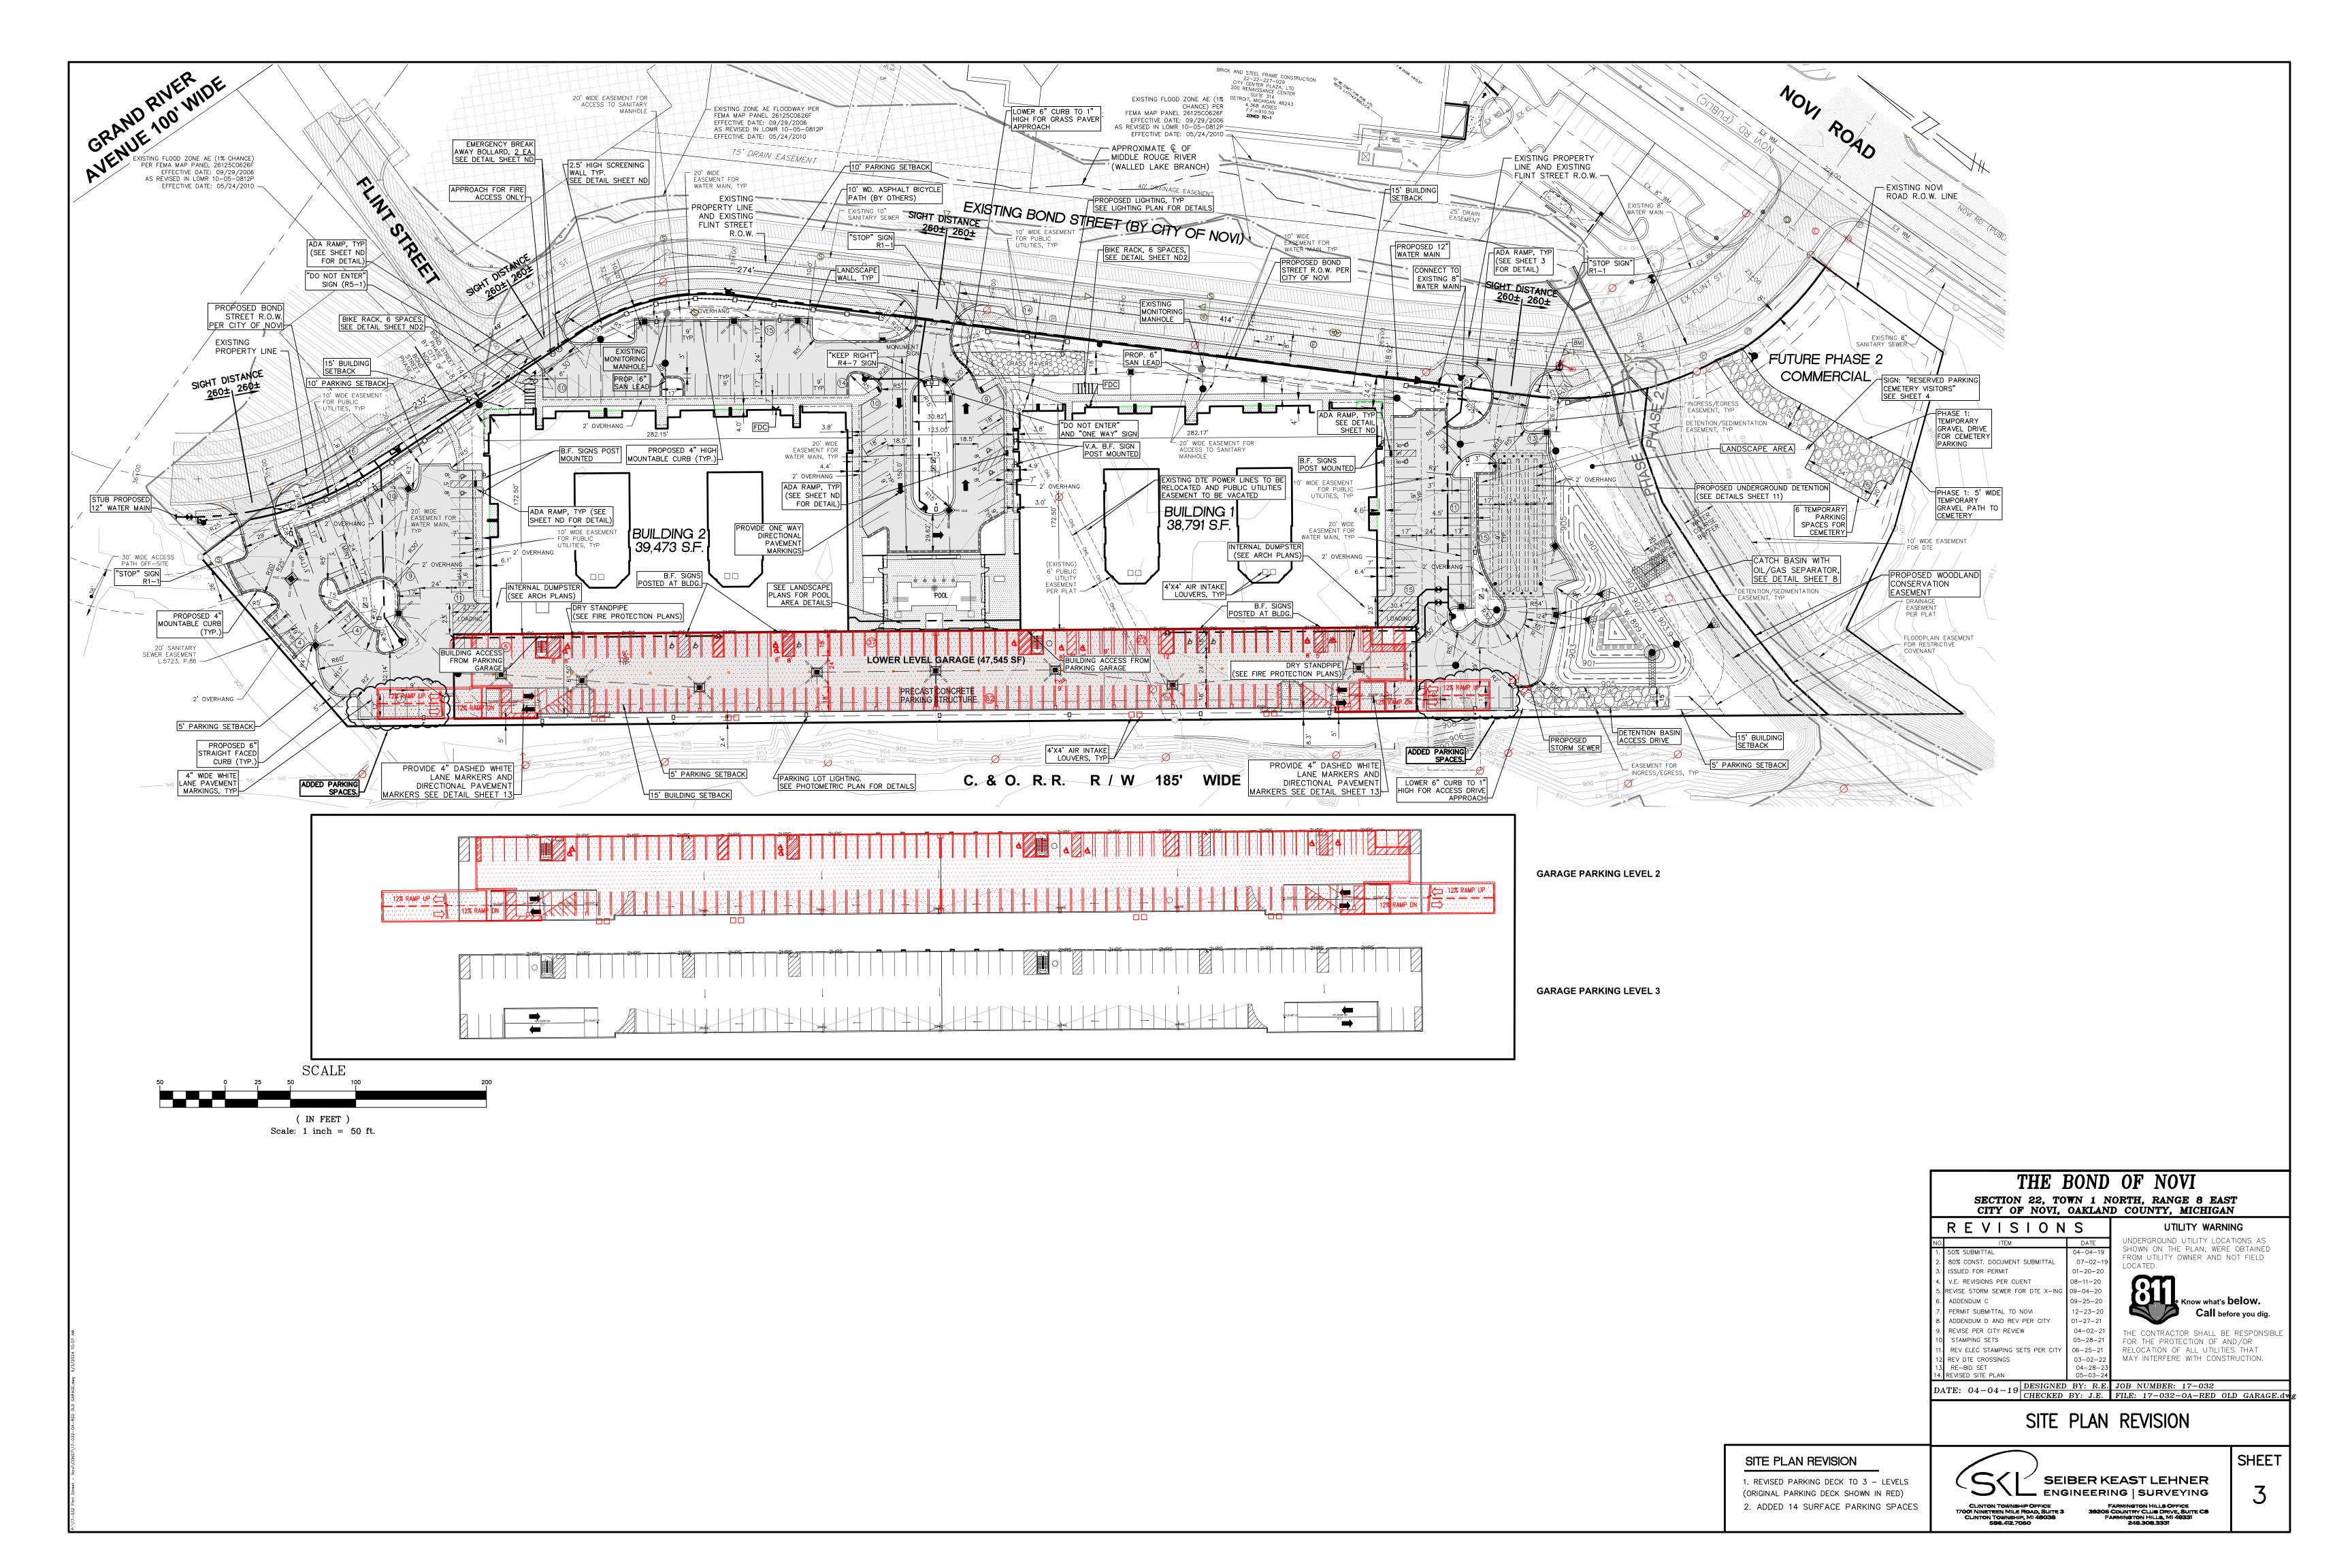


UNIT NAME	UNIT TYPE	AREA(SF)	UNIT COUNT	BED COUNT	TOTAL AREA	UNIT PERCENTAGE	% UNIT BREAKDOWN
E1	1br/1ba	607	18	18	10,926	5.5%	
E1-ALT 1	1br/1ba	607	18	18	10,926	5.5%	
E1-ALT 2	1br/1ba	607	2	2	1,214	0.6%	
E1-ALT 3	1br/1ba	607	2	2	1,214	0.6%	
A0	1br/1ba	637	14	14	8,918	4.3%	
A0-ALT 1	1br/1ba	637	6	6	3,822	1.8%	
A0-ALT 2	1br/1ba	637	10	10	6,370	3.0%	
A0-ALT 3	1br/1ba	637	4	4	2,548	1.2%	59%
A1	1br/1ba	759	40	40	30,360	12.2%	
A1-ALT-1	1br/1ba	759	40	40	30,360	12.2%	
A2	1br/1ba	778	7	7	5,446	2.1%	
A3	1br/1ba	853	13	13	11,089	4.0%	
A3-ANSI	1br/1ba	853	3	3	2,559	0.9%	
A3-ALT 1	1br/1ba	853	16	16	13,648	4.9%	
A4	1br/1ba	825	1	1	825	0.3%	
B0	2br/1ba	871	4	8	3,484	1.2%	
B1	2br/2ba	951	32	64	30,432	9.7%	
B1-ALT 1	2br/2ba	951	8	16	7,608	2.4%	
B2	2br/2ba	1,090	36	72	39,240	10.9%	35%
B3	2br/2ba	1,161	32	64	37,152	9.7%	
B3-ANSI	2br/2ba	1,161	2	4	2,322	0.6%	
B3-ALT 2	2br/2ba	1,161	2	4	2,322	0.6%	
C1	3br/2ba	1,395	16	48	22,320	4.9%	
C1-ANSI	3br/2ba	1,395	1	3	1,395	0.3%	60/
C1-ALT 1	3br/2ba	1,395	1	3	1,395	0.3%	6%
C1-ALT 2	3br/2ba	1,395	1	3	1,395	0.3%	
TOTALS			329	480	287,895	100.0%	100%

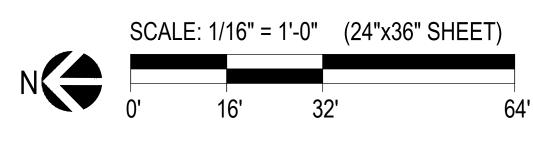




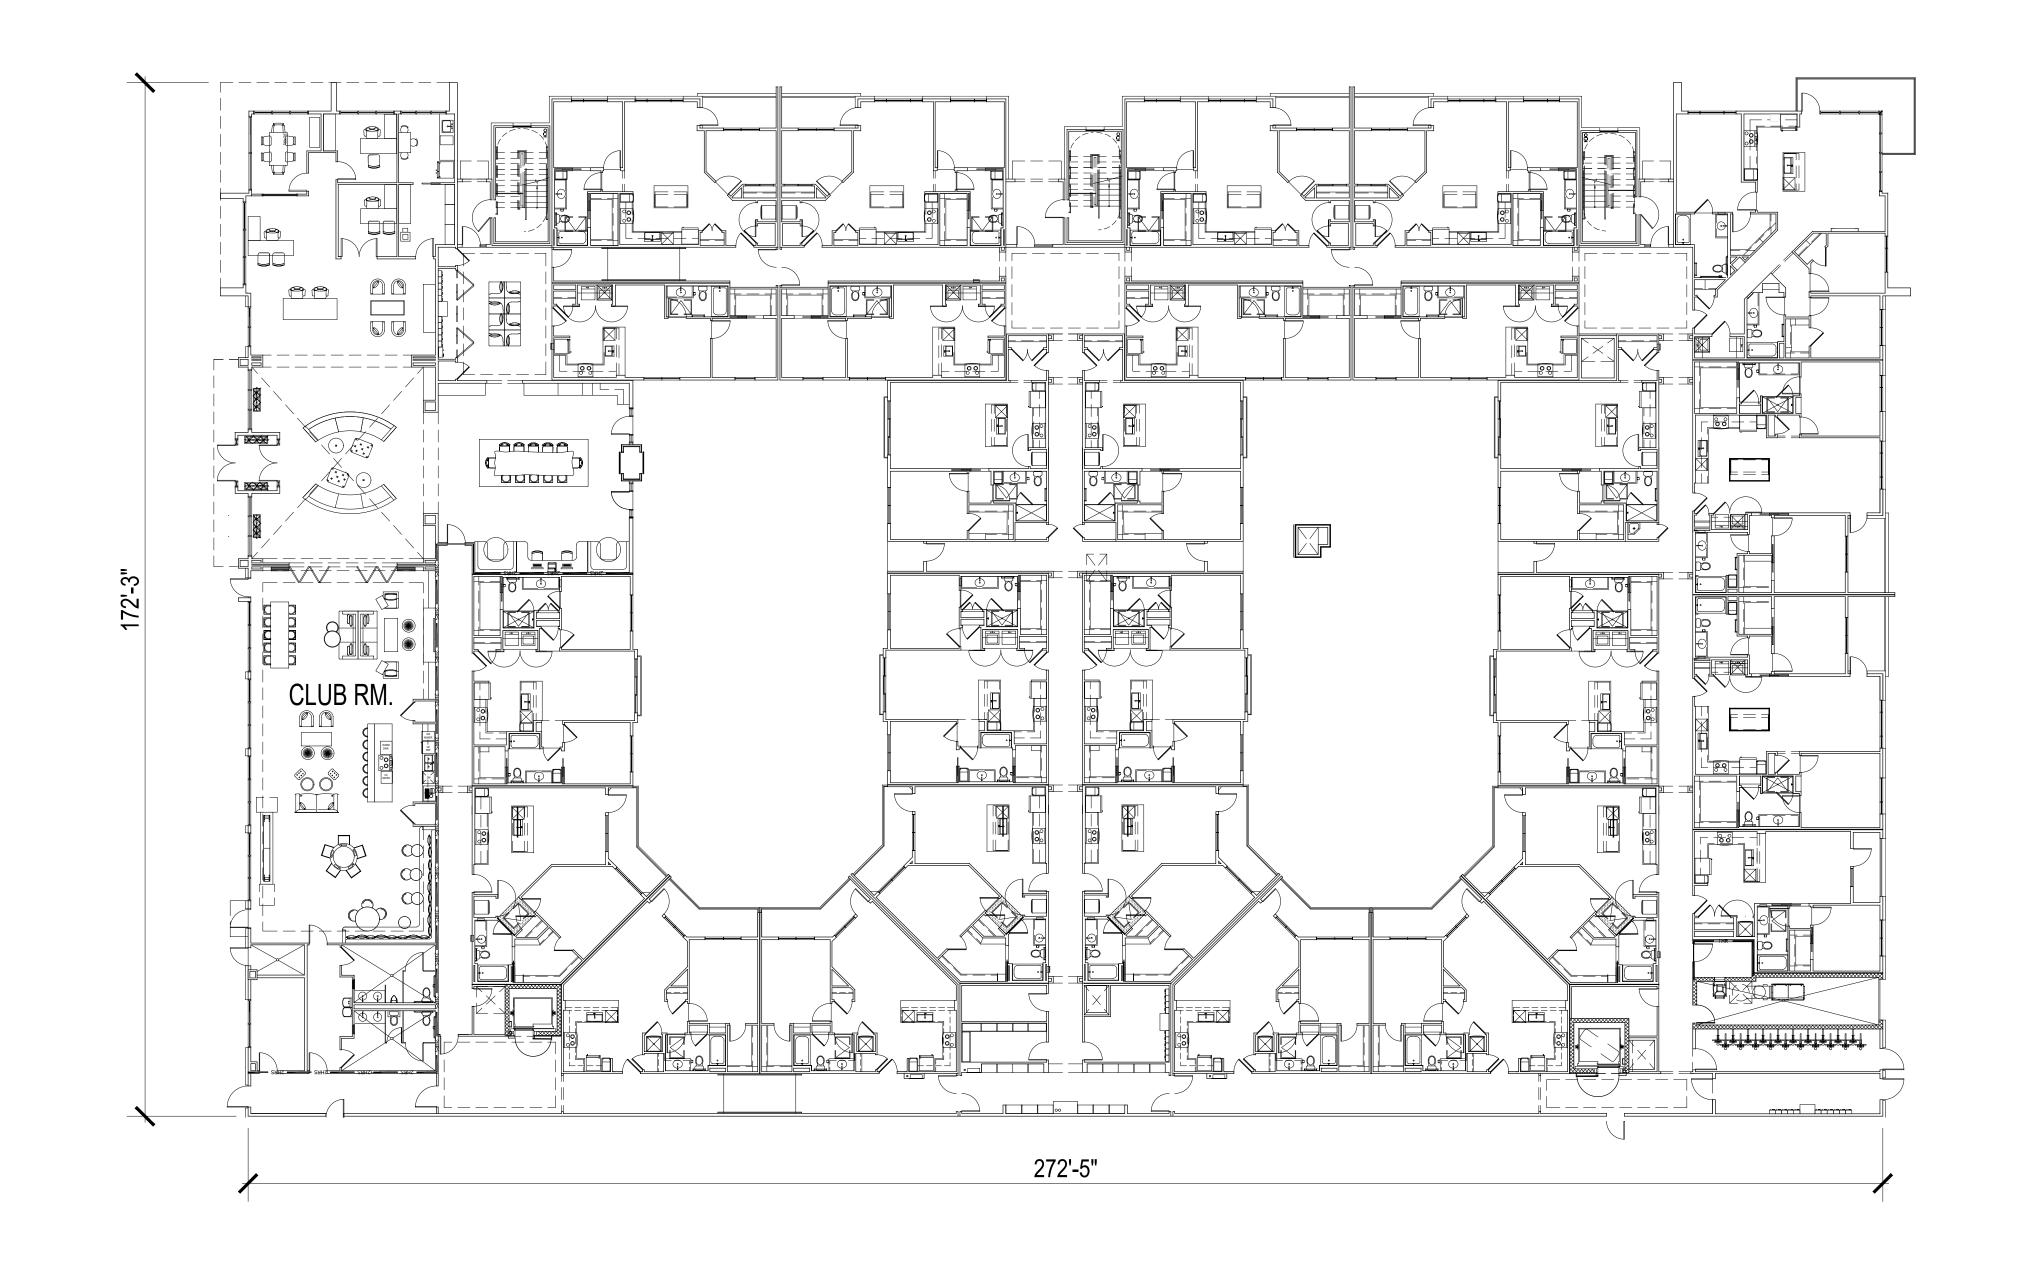


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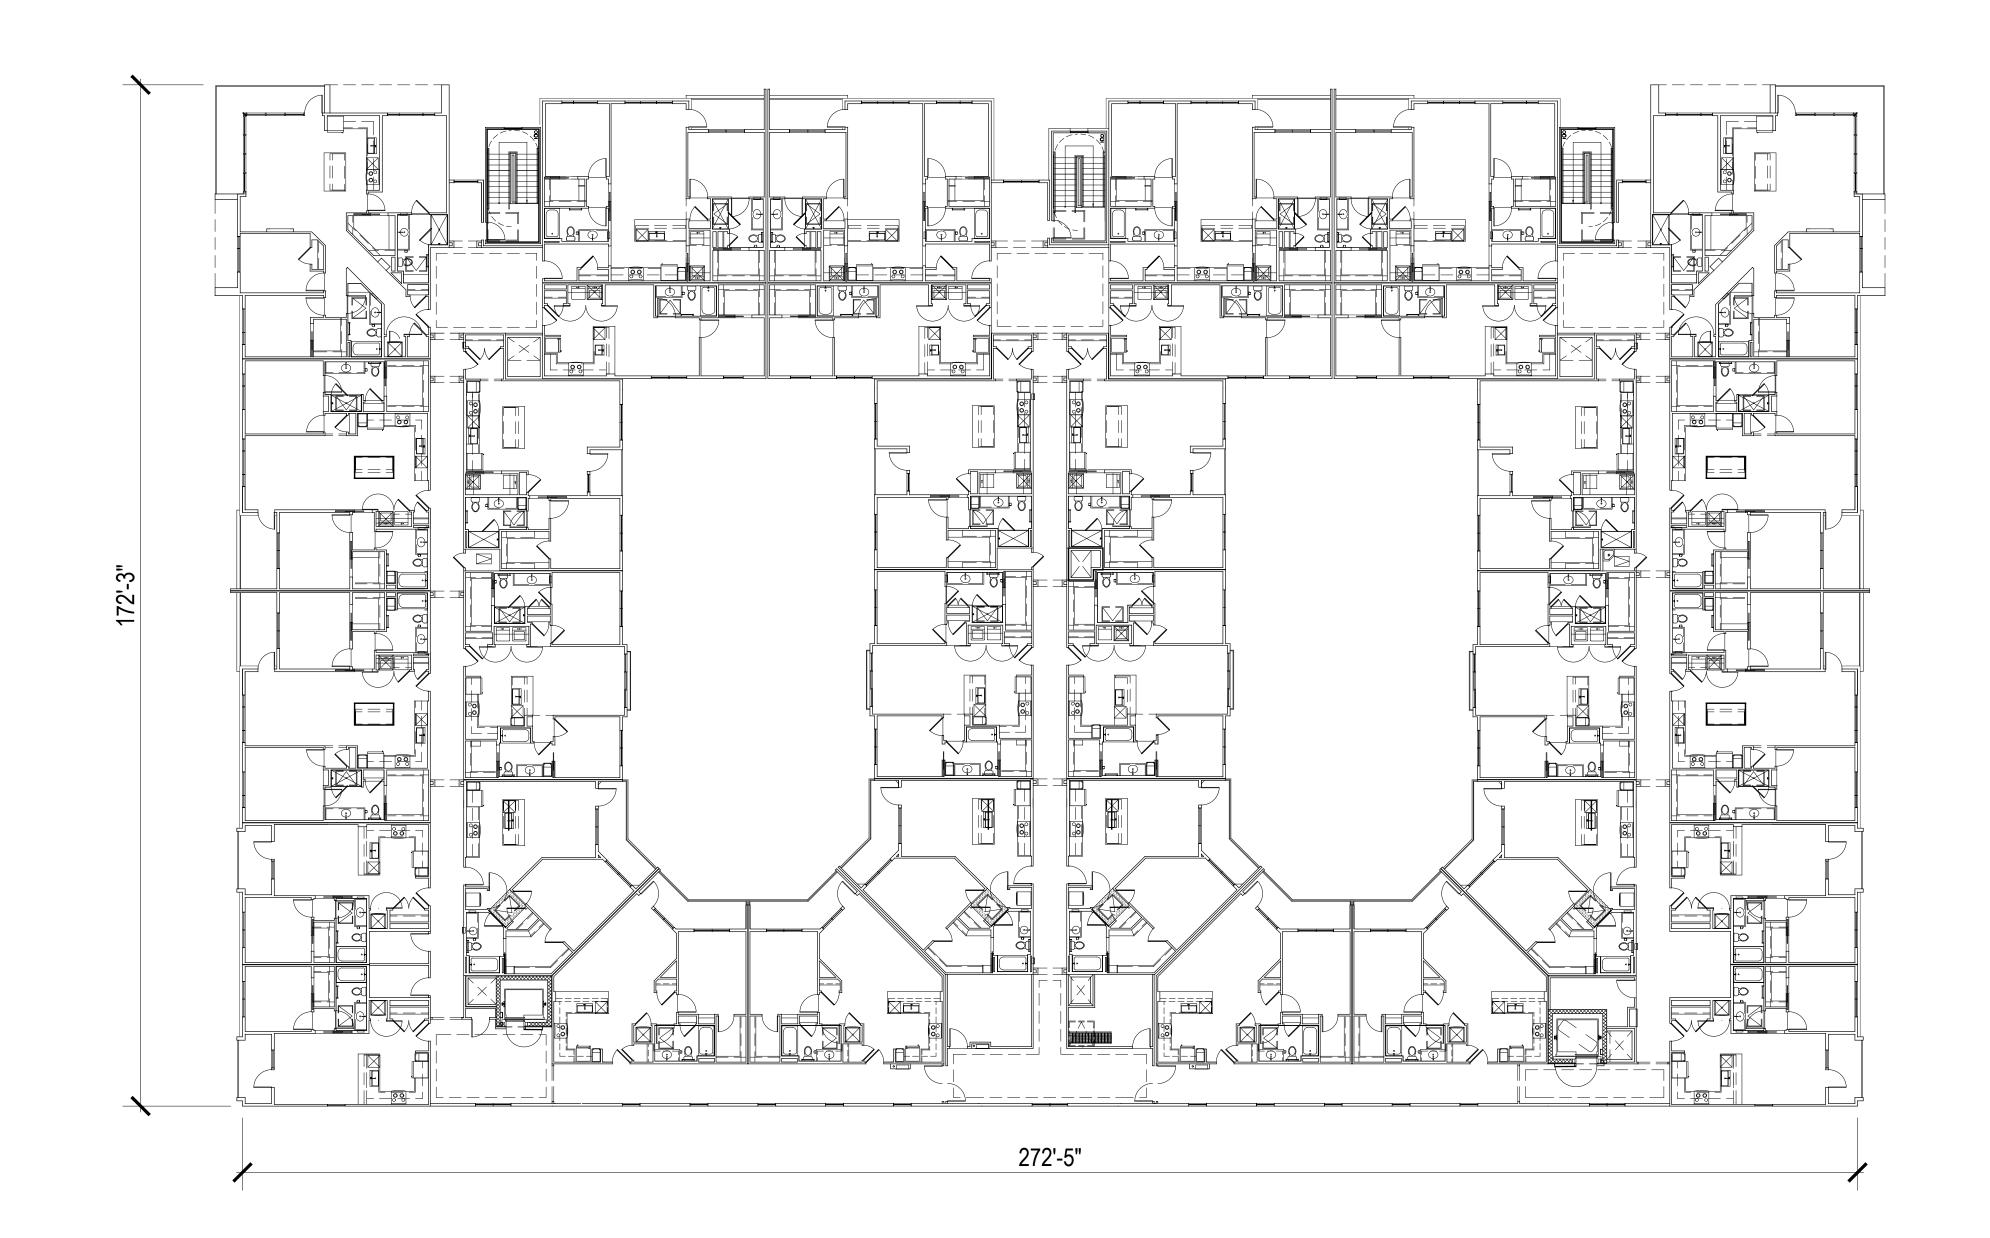


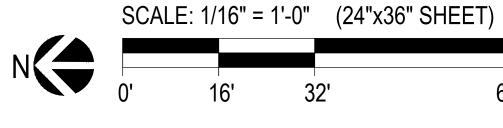




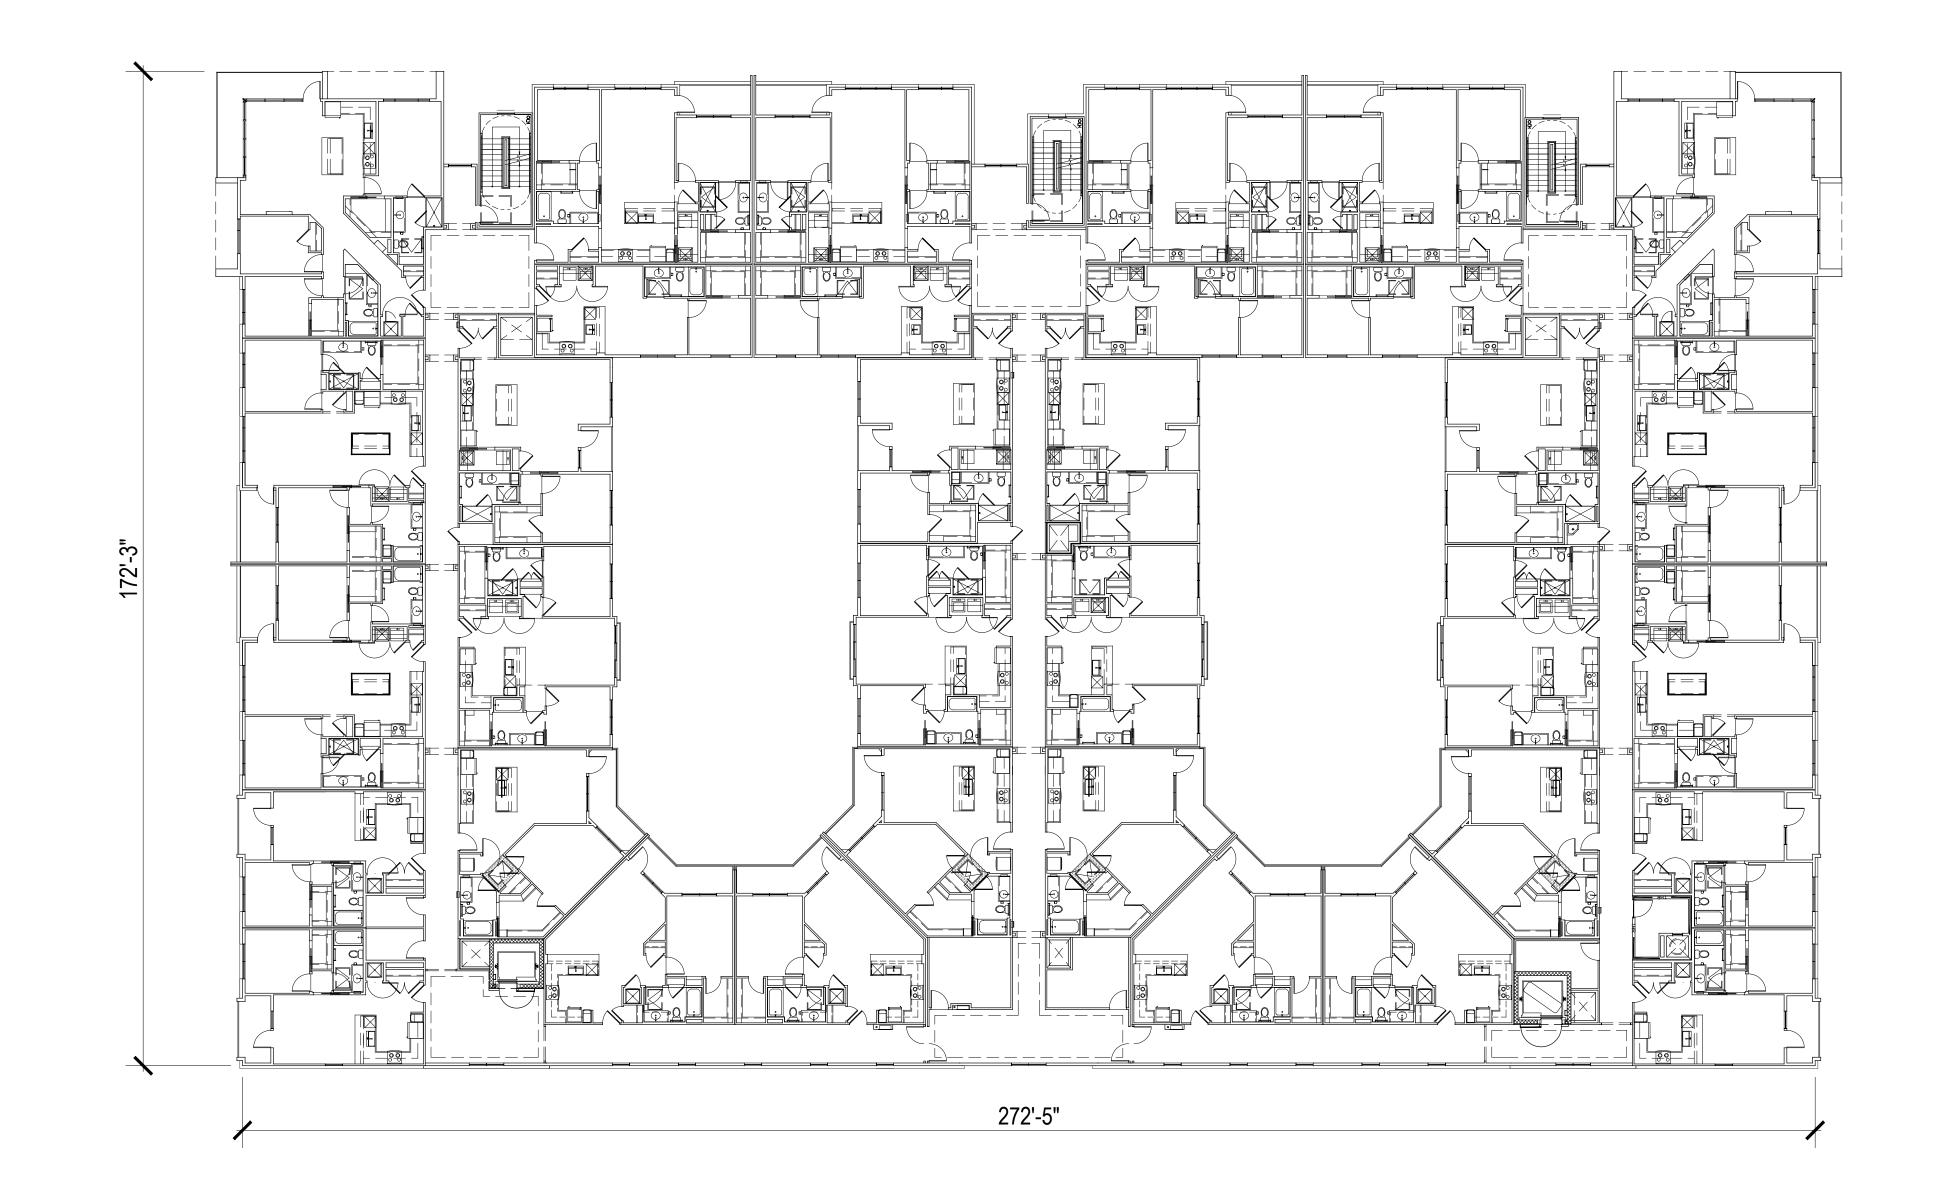


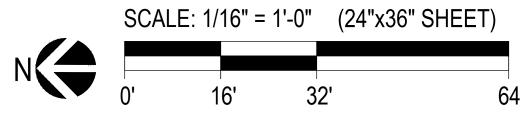



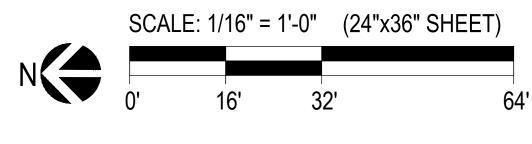




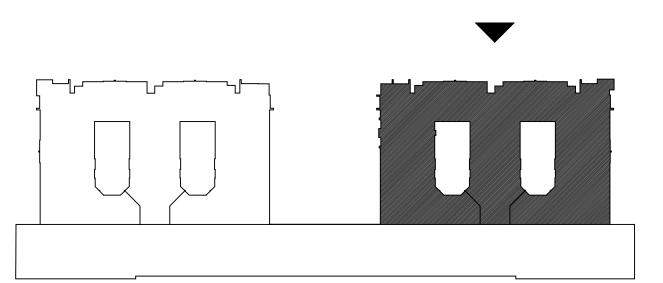



FRONT ELEVATION (East)

BUILDING TYPE 1	EAST (FRONT)
BRICK	18%
CAST STONE	9%
EIFS	52%
METAL PANEL (WOODGRAIN)	15%
SPANDERAL GLASS	2%
FABRIC AWNINGS	2%
FLAT METAL(CANOPIES)	1%
COMBINED BRICK AND STONE	28%

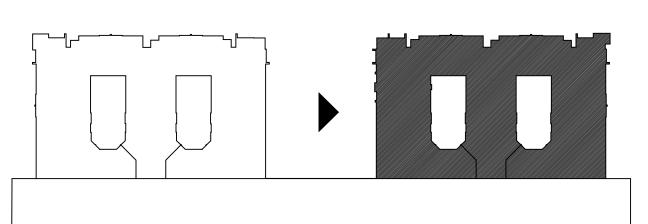




SIDE ELEVATION (North/pool courtyard)

BUILDING TYPE 1	NORTH (SIDE)
BRICK	24%
CAST STONE	10%
EIFS	51%
METAL PANEL (WOODGRAIN)	11%
SPANDERAL GLASS	2%
FABRIC AWNINGS	0.4%
FLAT METAL(CANOPIES)	1%
COMBINED BRICK AND STONE	34%


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BUILDING TYPE- I -ELEVATIONS

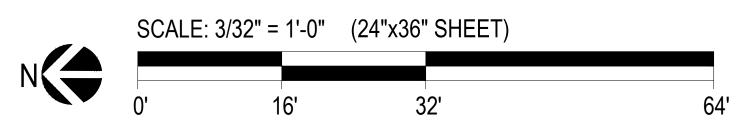THE BOND HPA# 17659


A414



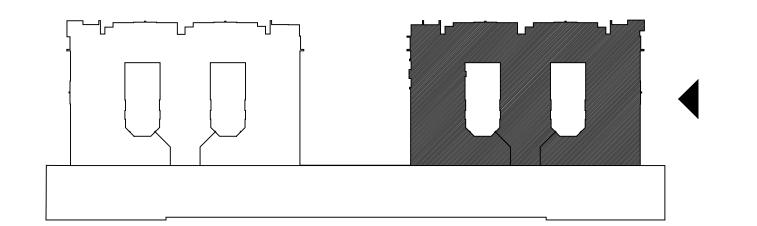


SIDE ELEVATION (South)

BUILDING TYPE 1	SOUTH (SIDE)
BRICK	21%
CAST STONE	12%
EIFS	51%
METAL PANEL WOODGRAIN)	10%
SPANDERAL GLASS	2%
FABRIC AWNINGS	3%
FLAT METAL(CANOPIES)	1%
COMBINED BRICK AND STONE	33%

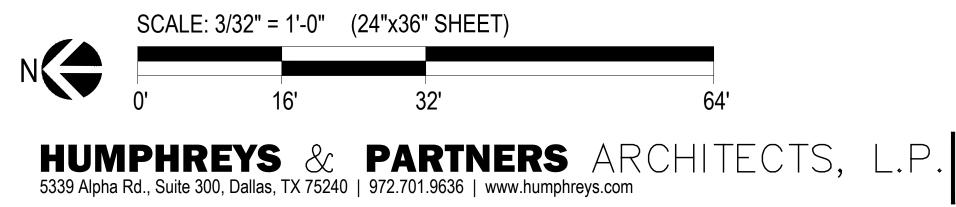




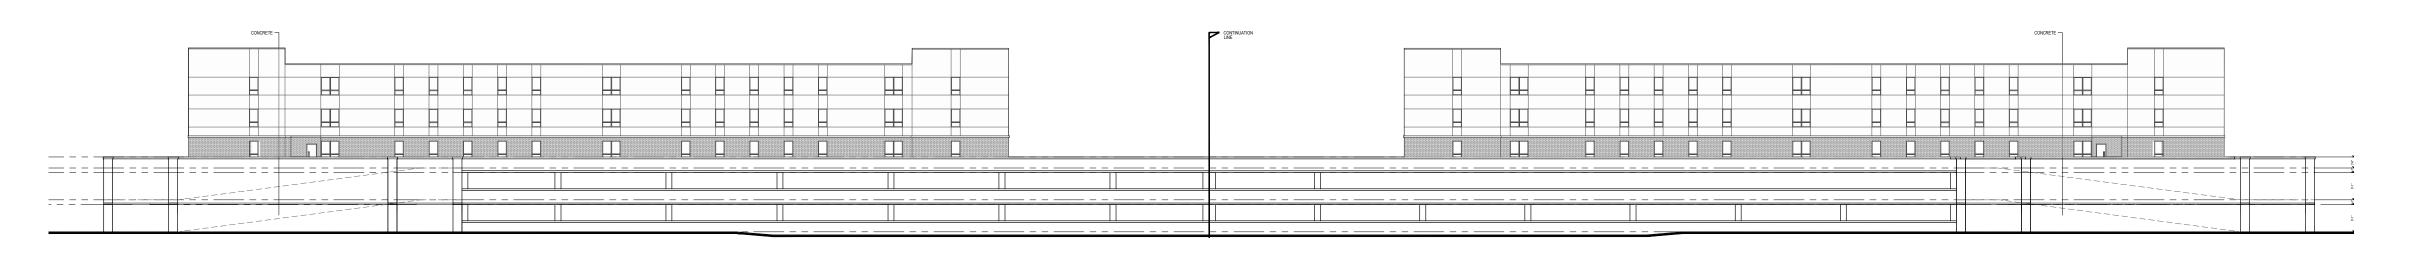


REAR ELEVATION (West) Esc: 1: 32"= 1' 0"




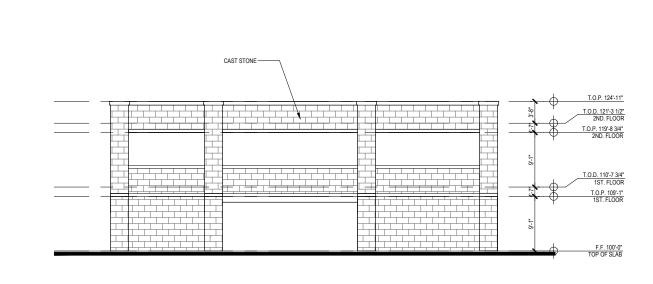

REAR ELEVATION (West-part I)

REAR ELEVATION (North)

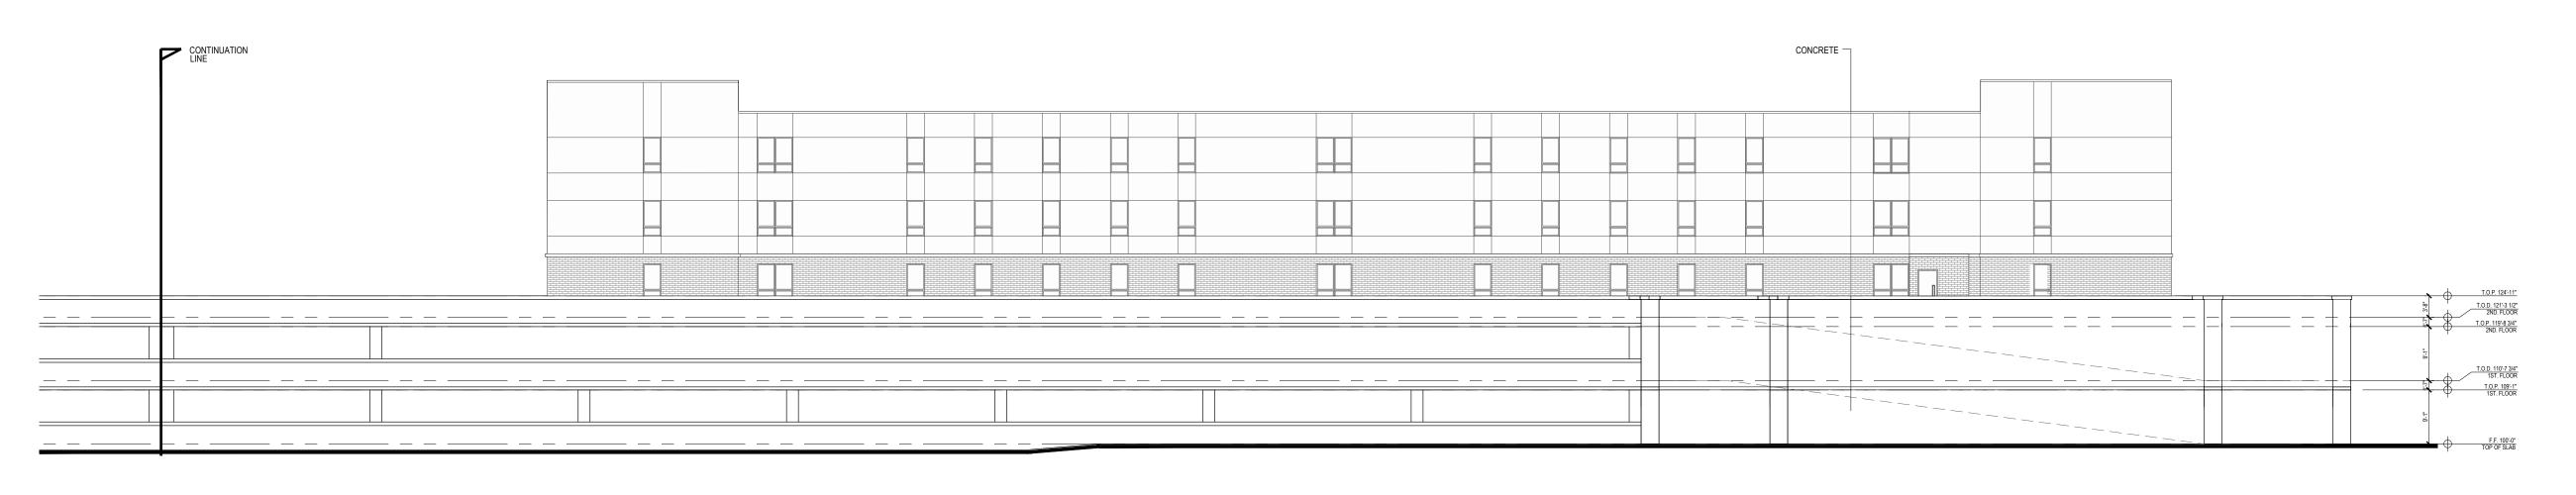

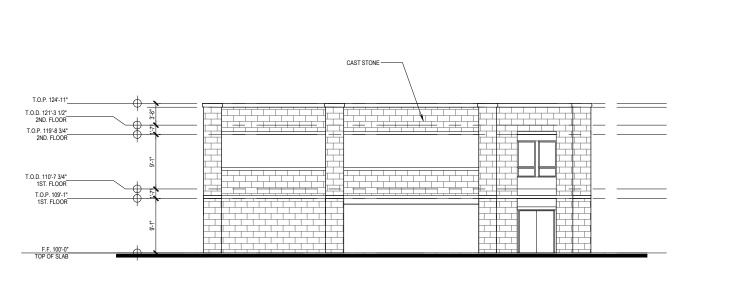

REAR ELEVATION (West-part II)

REAR ELEVATION (Souht)


BUILDING GARAGE ELEVATIONS

SCALE: 1/16" = 1'-0" (24"x36" SHEET)


GARAGE ELEVATIONS

A416


THE BOND

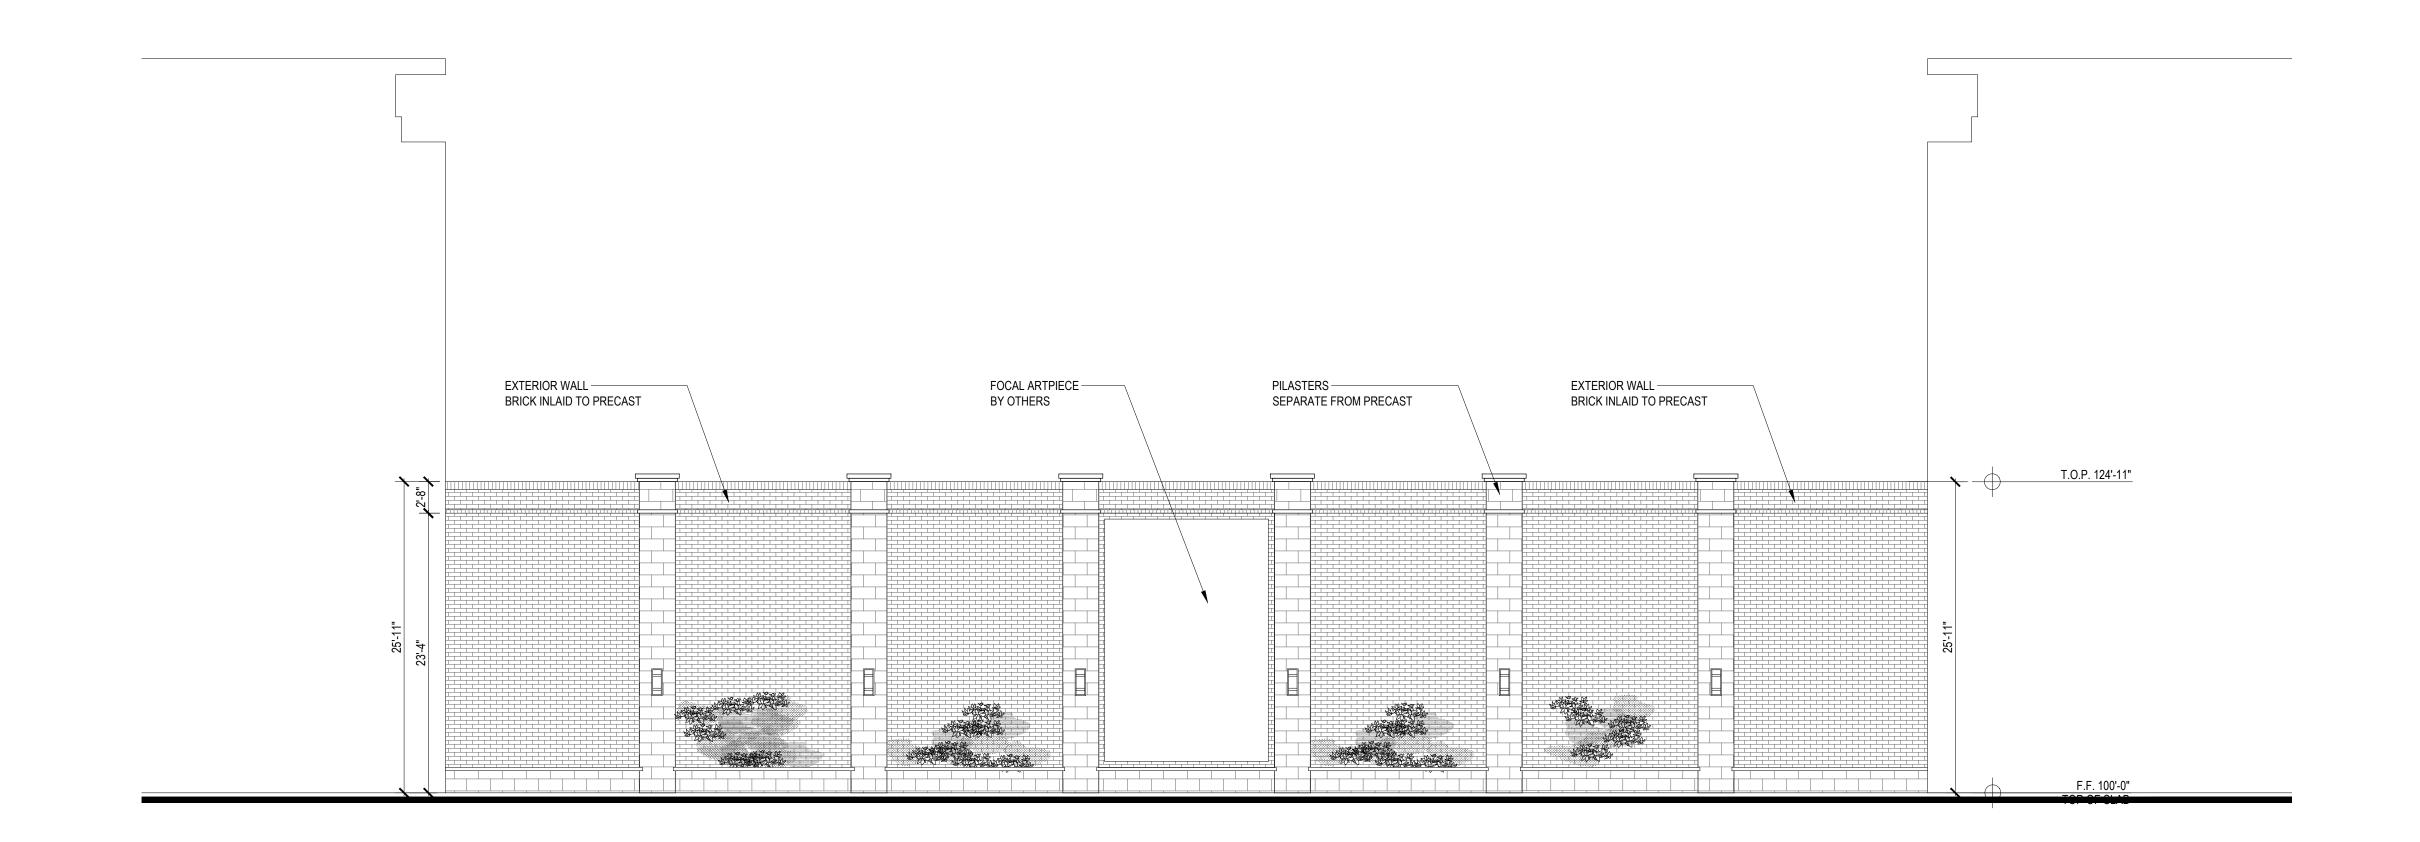


POOL FRONT ELEVATION

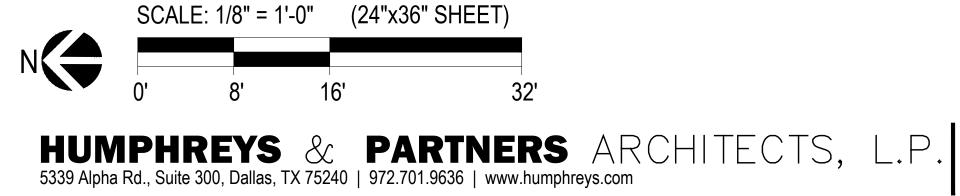



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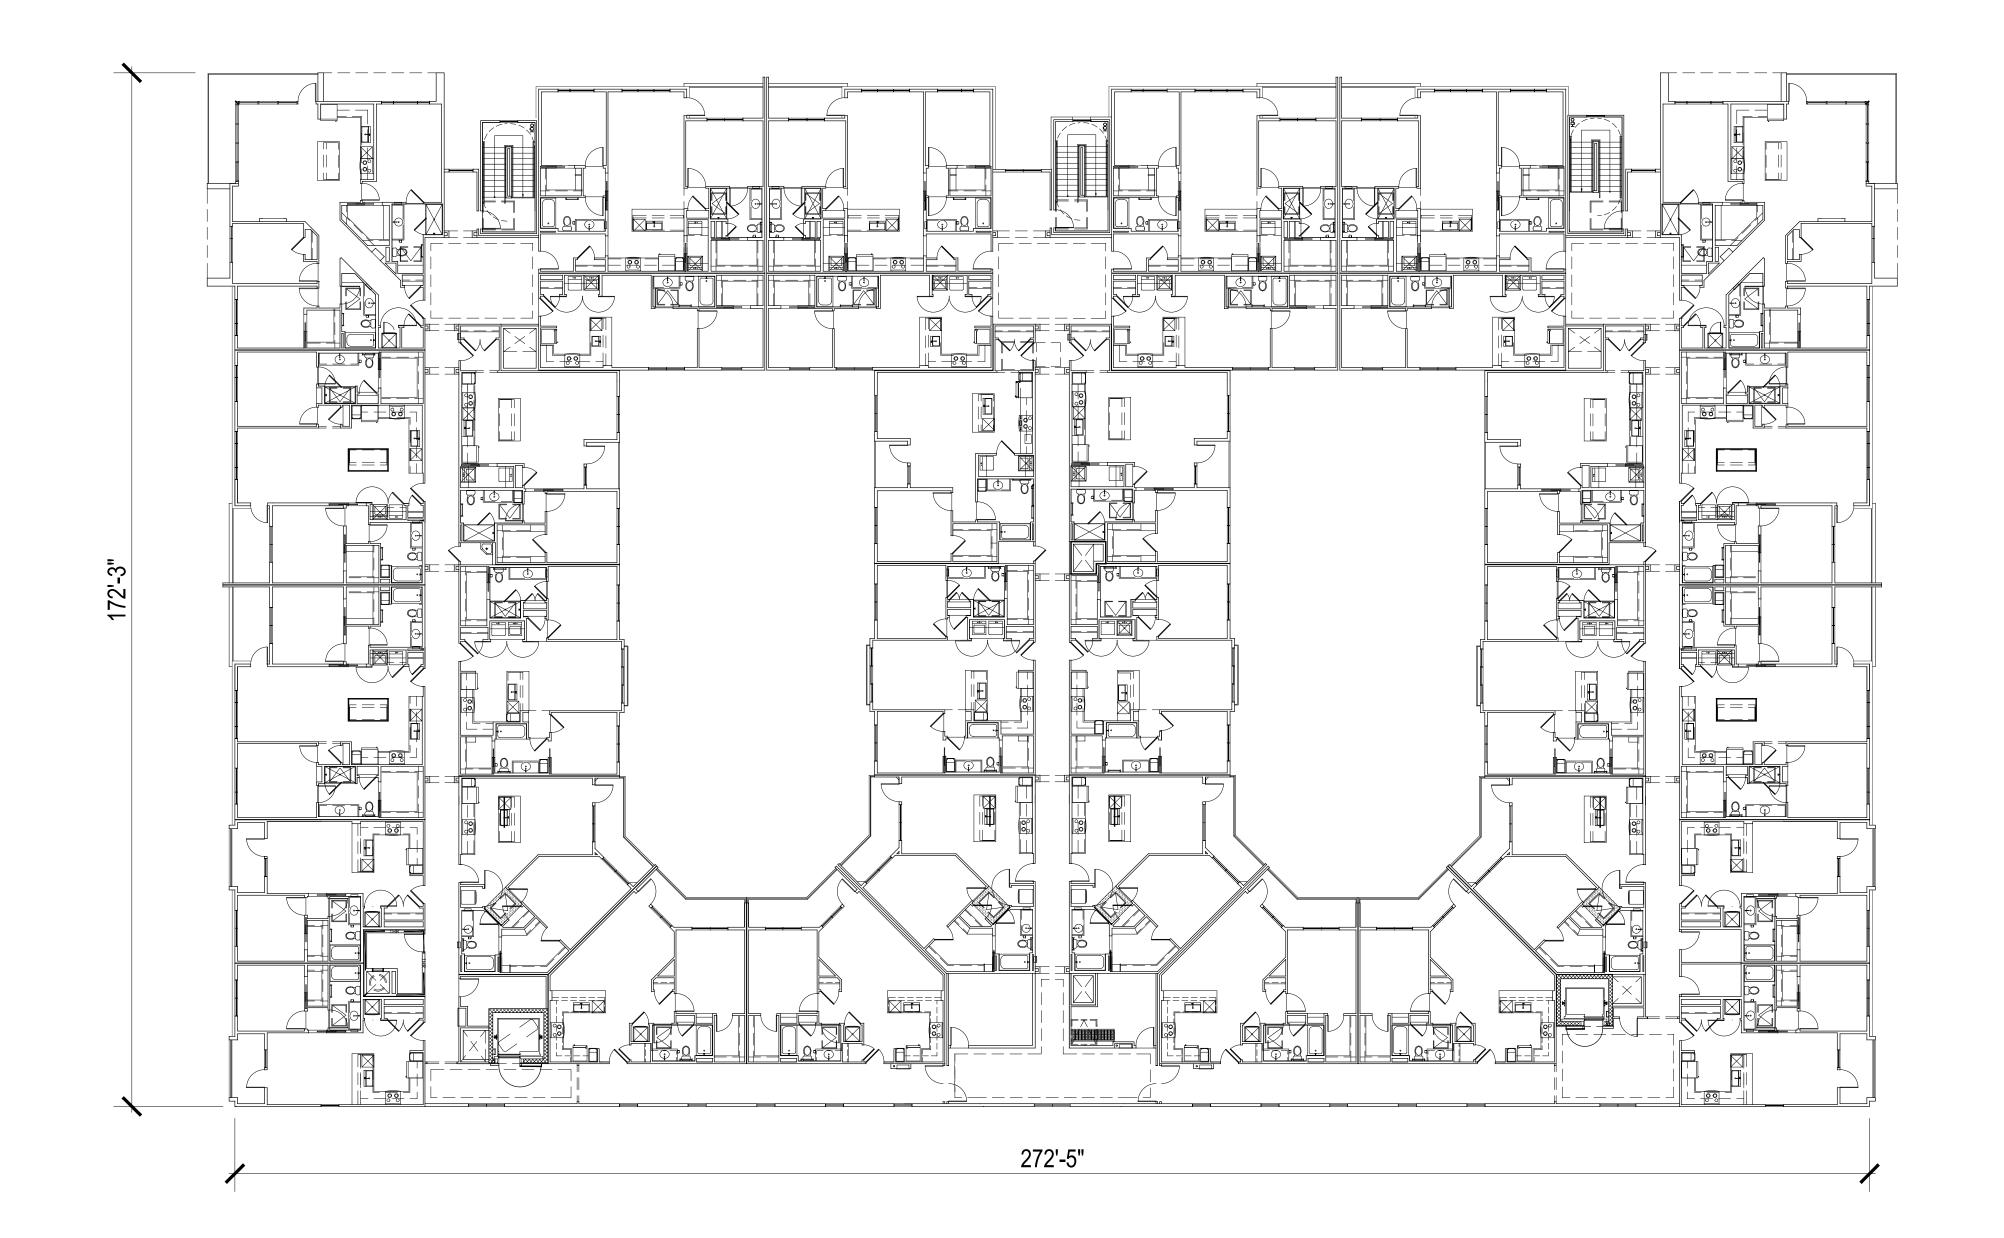


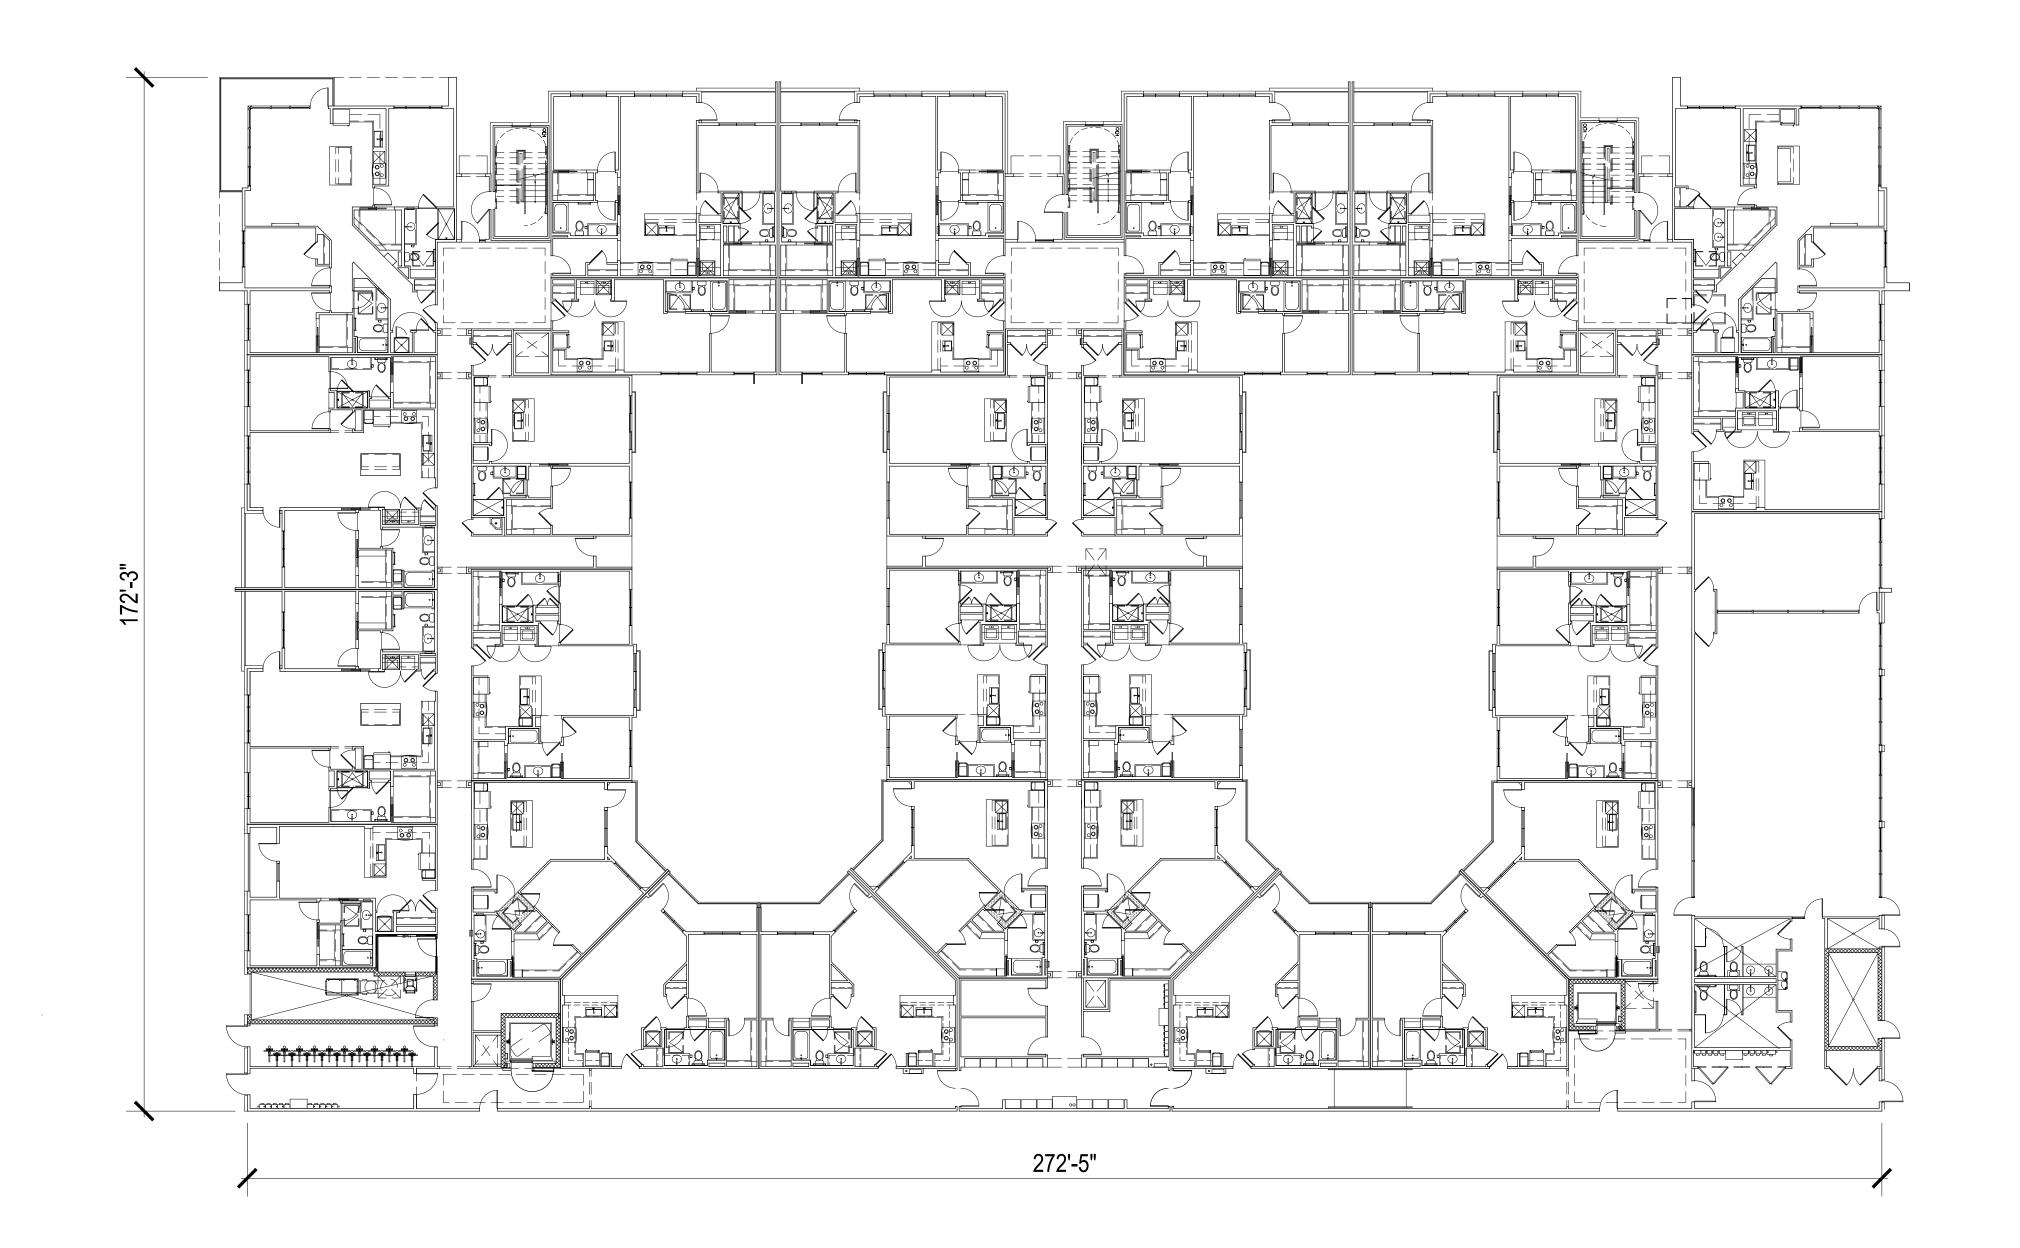

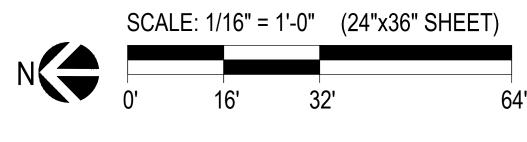




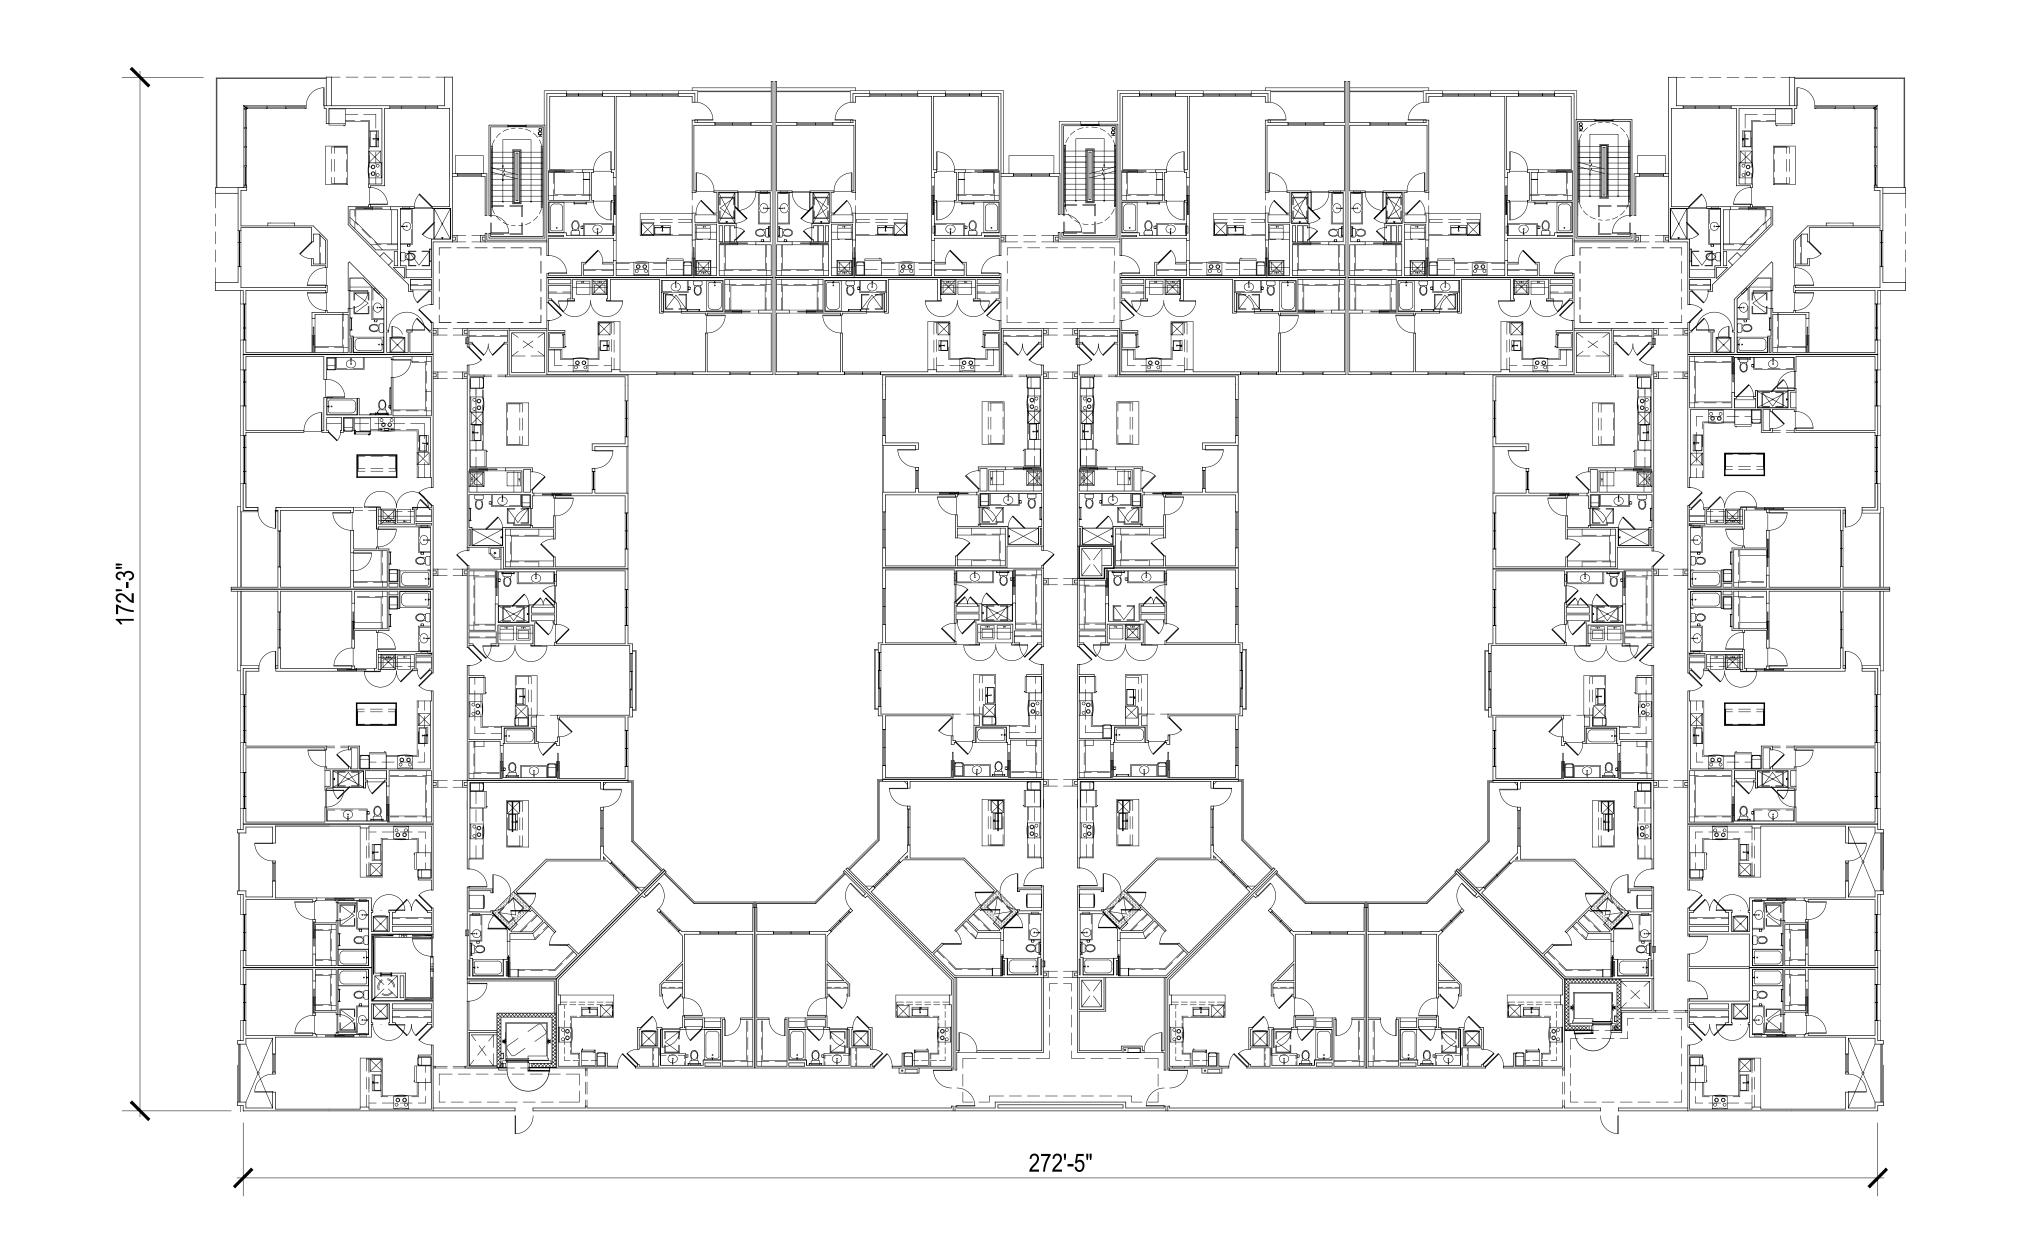


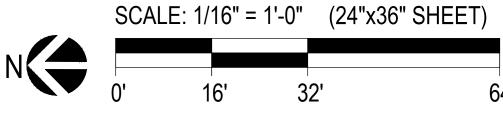

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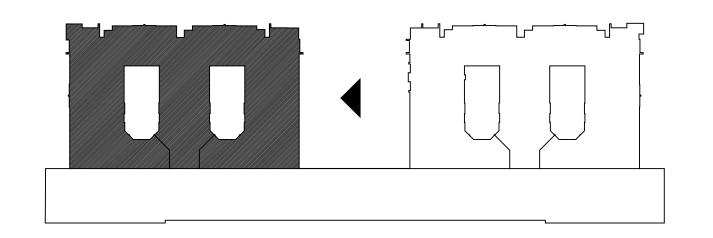


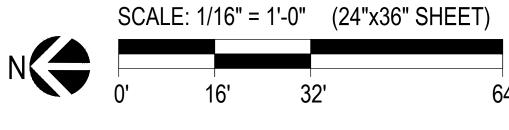

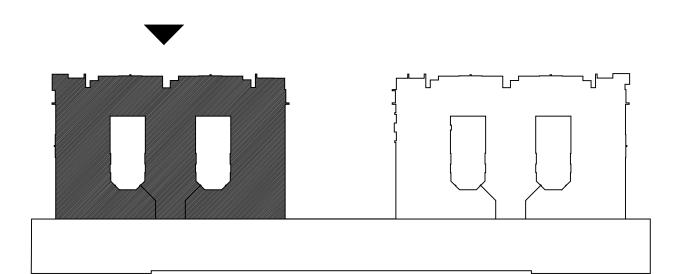

FRONT ELEVATION (East)


BUILDING TYPE II EAST (FRONT)			
BRICK	18%		
CAST STONE	9%		
EIFS	52%		
METAL PANEL (WOODGRAIN)	15%		
SPANDERAL GLASS	2%		
FABRIC AWNINGS	2%		
FLAT METAL(CANOPIES)	1%		
COMBINED BRICK AND STONE	28%		






SIDE ELEVATION (South/pool courtyard)

BUILDING TYPE	II SOUTH (SIDI
BRICK	24%
CAST STONE	10%
EIFS	51%
METAL PANEL (WOODGRAIN)	11%
SPANDERAL GLASS	2%
FABRIC AWNINGS	0.4%
FLAT METAL(CANOPIES)	1%
COMBINED BRICK AND STONE	34%

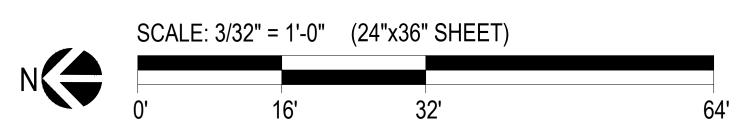



A424

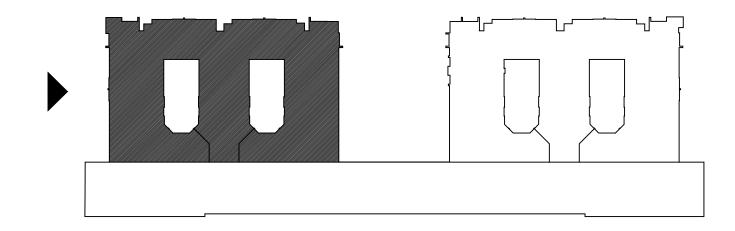




SIDE ELEVATION (North)


BUILDING TYPE II NORTH (SIDE)			
BRICK	21%		
CAST STONE	12%		
EIFS	51%		
METAL PANEL WOODGRAIN)	10%		
SPANDERAL GLASS	2%		
FABRIC AWNINGS	3%		
FLAT METAL(CANOPIES)	1%		
COMBINED BRICK AND STONE	33%		







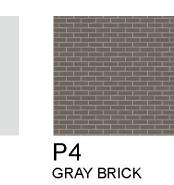

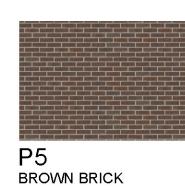



BUILDING I - EAST ELEV			
	SQFT.	%	
STUCCO (EIFS)	5390.5 SQ. FT.	56	
BRICK VENNER	2040.1 SQ. FT.	21	
SPLIT FACE CMU	761.7 SQ. FT.	8	
ALUMINUM PANEL	1464.3 SQ. FT.	15	
TOT. AREA	9656.72 SQ. FT.	100	




OVERALL EAST ELEVATION




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EAST ELEVATIONS-POOL COURTYARD


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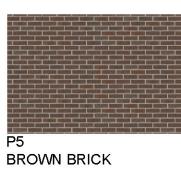




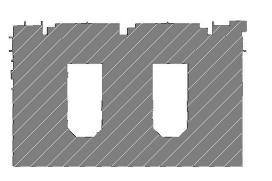

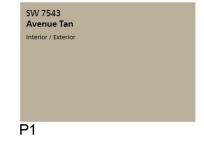



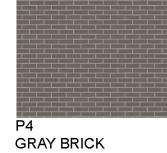







BUILDING 1-OLD FRONT ELEVATION (East)



BUILDING 1- FRONT ELEVATION (East)
BUILDING TYPE I ELEVATIONS

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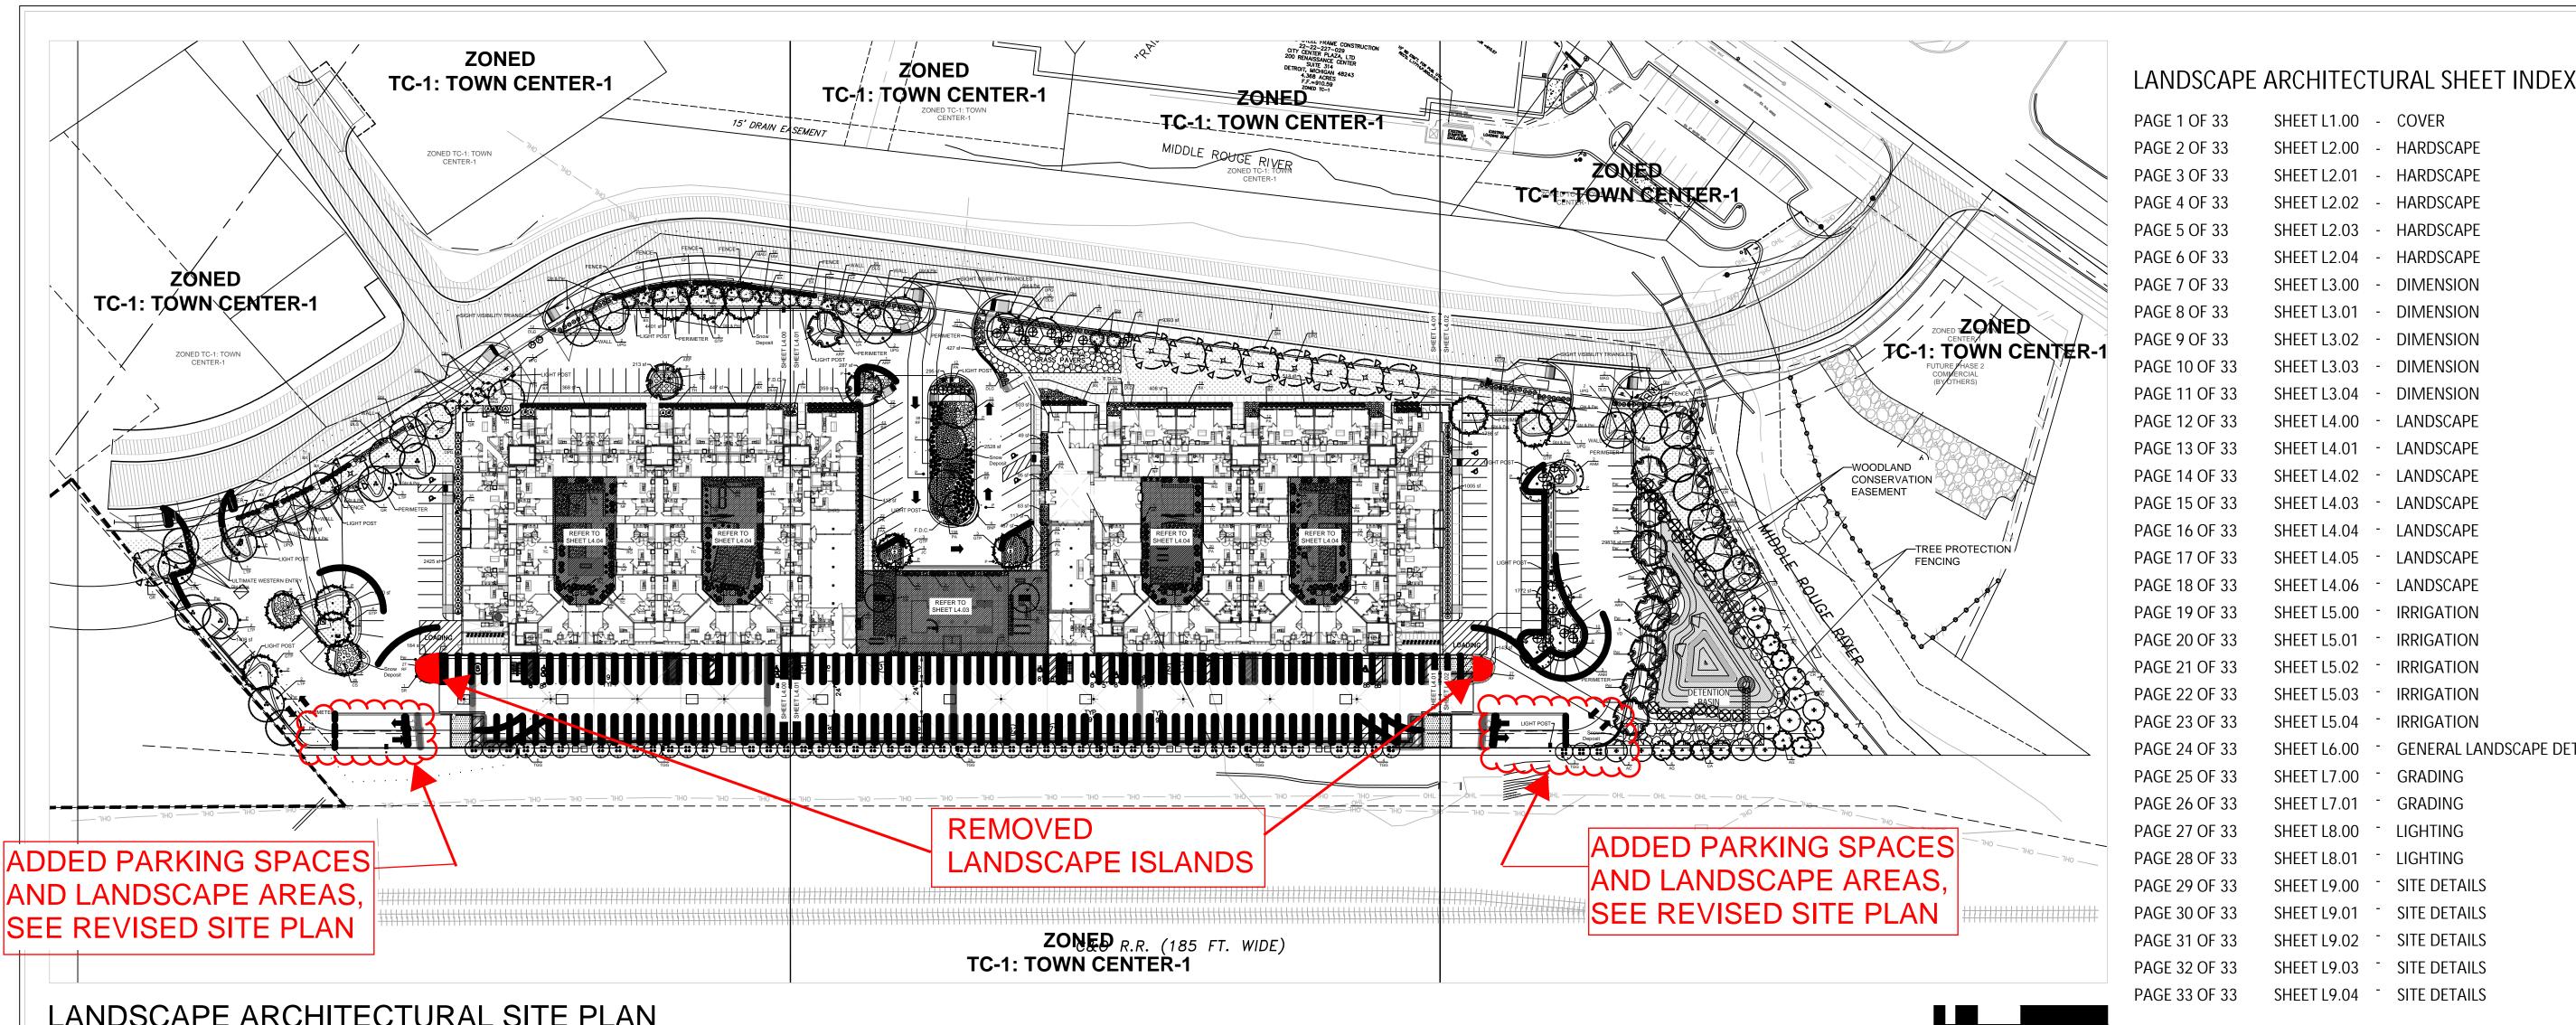
SCALE: 3/32" = 1'-0" (24"x36" SHEET)

0' 16' 32' 64'

HUMPHREYS & PARTNERS ARCHIT
5339 Alpha Rd., Suite 300, Dallas, TX 75240 | 972.701.9636 | www.humphreys.com

BUILDING TYPE I ELEVATIONS

A414-ELEVATION COMPARATION



LANDSCAPE ARCHITECTURAL SITE PLAN

PLANT PALETTE - OVERALL

Liriodendron tulipifera

Buxus x 'Green Velvet'

Taxus x media 'Hicksii

HICKS YEW (TH)

Juniperus communis

COMMON JUNIPER (JC)

KARL FORESTER GRASS (KF)

Rudbeckia fulgida 'Goldstrum'

BLACK-EYED SUSAN (RF)

Hemerocallis 'Violet Light'

Thuja 'Green Giant'

VIOLET LIGHT DAYLILY (DLG)

SHASTA DAISY ALASKA (CS)

GREEN GIANT ARBORVITAE (TGG)

Leucanthemum x superbum 'Alaska' 121 #2 CONT.

CONTINUOUS HEDGE AT LEAST 3'-0" TALL

NOTE: SCREENING SHRUBS TO BE MAINTAINED AS A

HAMELN FOUNTAIN GRASS (PA)

JÁPANESE TREE LILAC (SR)

GREEN VELVET BOXWOOD (BX)

Calamagrostis x acutiflora 'Karl Foerster' 06 #2 CONT.

Pennisetum alopecuroides 'Hameln' 436 #2 CONT.

121 #2 CONT.

TULIP TREE (LTP)

Syringa reticulata

GENERAL LANDSCAPING

ANTI ALLITE OVENALL									
REENBELT					UNIT LANDSCAPING		_		
NAME	QTY.	ROOT	CALIPER	UNIT PRICE/ TOTAL	NAME	QTY.	HEIGHT	ROOT	UNIT PRICE/ TOTAL
Malus 'Adirondack' ADIRONDACK CRABAPPLE (MAG	13)	B&B	2.5" CAL. MIN.	\$375.00/ \$4,875.00	Picea glauca WHITE SPRUCE (AG)	09	8'	B&B	\$400.00/ \$3,600.00
Ulmus x ' <i>Pioneer</i> ' PIONEER ELM (UPG)	15	B&B	3" CAL. MIN.	\$400.00/ \$6,000.00	Abies concolor WHITE FIR (AC)	13	8'	B&B	\$400.00/ \$5,200.00
Quercus rubra RED OAK (QR)	10	B&B	3" CAL. MIN.	\$400.00/ \$4,000.00	DETENTION PLANTING				φ3,200.00
Cornus florida FLOWERING DOGWOOD (CF)	11	B&B	3" CAL. MIN.	\$375.00/ \$4,125.00	NAME	QTY.	HEIGHT	ROOT	UNIT PRICE/ TOTAL
Quercus bicolor SWAMP WHITE OAK (SWO)	06	B&B	3" CAL. MIN.	\$400.00/ \$2,400.00	Cornus amomum SILKY DOGWOOD (CA)	17	36"		\$50.00/ \$850.00
Cornus alternifolia PAGODA DOGWOOD (CA)	04	B&B	3" CAL. MIN.	\$375.00/ \$1,500.00	Cornus rugosa ROUND-LEAVED DOGWOOD (CR)	17	36"		\$50.00/ \$850.00
RKING LOT AND PERIMETER TREI		DOOT	CALIDED	LINIT DDIOE	Viburnum dentatum ARROW-WOOD (VD)	17	36"		\$50.00/ \$850.00
NAME	QTY.	ROOT	CALIPER	UNIT PRICE/ TOTAL	EMERGENT WETLAND SEED MIX ((BY CAR	RDNO JFNEW)		2,135 SF

TOTAL

\$50.00/

\$7,400.00

\$50.00/

\$350.00

\$50.00/

\$1,850.00

\$15.00/

\$90.00

\$15.00/

\$6,540.00

\$15.00/

\$1,815.00

\$15.00/

\$2,790.00

\$50.00/

\$2,550.00

\$15.00/

\$1,815.00

X Vibramo do oto truo		
PARKING LOT AND PERIMETER TREES Viburnum dentatum ARROW-WOOD (VD)	17	36"
NAME QTY. ROOT CALIPER UNIT PRICE/ TOTAL EMERGENT WETLAND SE	ED MIX (BY CARD	NO JFNEV
Acer rubrum 05 B&B 3" CAL. MIN. \$400.00/ 39.8 LBS PER ACRE APPL \$2,000.00 2.2 LBS OF EMERGENT SE	ICATION RATE EED MIX	
Acer rubrum 'October Glory' 11 B&B 3" CAL. MIN. \$400.00/ OCTOBER GLORY RED MAPLE (ARP) 3"-6" OF TOPSOIL OR WET PLACED IN THIS AREA. US \$4,400.00	SE SEED MAT.	
Betula nigra 04 B&B N/A - 15' HEIGHT \$400.00/ RIVER BIRCH - MULTI STEM (BNP) \$1,600.00 \$1,600.00 2.3 LBS OF STORMWATER	ICATION RATE	IEW)
Gleditsia triacanthos 'Shademaster' 12 B&B 3" CAL. MIN. \$400.00/ 3"-6" OF TOPSOIL SHALL E SHADEMASTER HONEY LOCUST (GTP) \$4,800.00		IS AREA

11	B&B	3" CAL. MIN.	\$400.00/	GRASS		
		o o/	\$4,400.00	NAME	QUANTITY	UNIT PRICE/
01	B&B	2.5" CAL. MIN.	\$375.00/	¥		TOTAL
O I	Ьαь	B&B	\$375.00/ \$375.00	KENTUCKY BLUE GRASS	22,378 SF	\$8.00(per sf)/
		DQD	φ3/3.00	* * * * * *		\$179,024.00
					тот	AL: \$256,049.00
QTY.	HEIGHT	ROOT	UNIT PRICE/			

FROM THE PROPERTY LINE.

NOTE: NO TREE SHALL BE PLANTED CLOSER THAN 10 FEET FROM A HYDRANT OR

OTHER UTILITY STRUCTURE, AND 5 FEET FROM AN UNDERGROUND UTILITY LINE.

ALL TREES SHALL BE PLANTED AT LEAST 3 FEET BEHIND A CURB AND FEET AWAY



3,220 SF

Call MISS DIG before digging 1-800-482-7171

LANDSCAPE SUMMARY - MULTI-FAMILY

TC-1	FOUNDATION LA
	Building Perimeter Landscape Required
230'	Landscape Provided
10 Trees (230 / 25) 17 Trees	MULTI-FAMILY R
16 Trees (230' / 15')	Units Proposed
16 Trees	Trees Required
850'	Trees Provided
159'	WOODLAND REI
691'	Trees Required
23 Trees (691' / 30')	Trees Provided
24 Trees	Trees to be Paid Into I
35 Trees (691' / 20') 09 Trees	DETENTION PON High Water Length
	230' 10 Trees (230' / 25') 17 Trees 16 Trees (230' / 15') 16 Trees 850' 159' 691' 23 Trees (691' / 30') 24 Trees 35 Trees (691' / 20')

PARKING LOT LANDSCAPING ("P")

Vehicular Use Area (Exclusive of Deck)	68,138 SF
VUA up to 50,000 SF	3,750 SF (50,000 x 7.5%
VUA Over 50,000 SF	181 SF (18,138 x 1%)
Landscape Area Required	3,931 SF
Landscape Area Provided	4,376 SF
Trees Required	20 Trees (734' / 35')
Trees Provided	21 Trees
Trees Required	20 Trees (734' / 35')

PARKING LOT PERIMETER LENGTH ("Per") Parking Lot Perimeter Length Trees Required 29 Trees (1,010' / 35')

Trees Provided 30 Trees **MULTI-FAMILY UNIT TREES TOTAL ("*"** Trees Required 171 Trees

171 Trees Trees Provided

approximate locations.

- A. Transformer to be screened per detail on sheet L-3 of preliminary landscape submittal by Allen Design. B. Plantings shall be located to closer than 4' to property
- C. Plantings shall be no closer than 10' to hydrants and
- utility structures D. No Japanese Knotweed is present on the site. Phragmites australis is found on site, refer to L4.06 for removal instructions and refer to LWP1.00 for
- . No replacement trees are proposed to be planted on site and a payment of \$77,200 (193 tree credits x \$400) will be paid into the City of Novi Tree Fund.

FOUNDATION LANDSCAPING - INCLUDING DECK Building Perimeter 2,072 LF

16,576 SF (2,072' x 8')

andscape Provided 16,645 SF MULTI-FAMILY REQUIREMENTS 57 Units (Ground Floor) Jnits Proposed

171 Trees (57 x 3) Trees Required Trees Provided 171 Trees

WOODLAND REPLACEMENT 193 Trees Trees Required Trees Provided 0 Trees Trees to be Paid Into Fund 193 Trees

DETENTION POND

411 LF High Water Length 288 LF (411' x 70%) Plantings Required Plantings Provided 300 LF (73%)

WAIVERS GRANTED BY PLANNING COMMISSION ON 6/27/18:

1. Landscape waiver from Sec. 5.5.3.B.ii for the lack of a berm and screening as the applicant proposed a line of arborvitaes along the property line to soften the view toward the railroad tracks and industrial site beyond in lieu of required landscape screening 2. Landscape waiver from Sec. 5.5.3.B.ii for a reduction in the

required greenbelt width between the right-of-way and parking areas along Flint/Bond Street (20 ft. width required, a range of 10 ft. to 20 ft. provided). A 2.5 foot brick wall screening the parking and additional landscaping in the narrower areas help to compensate for the lack of space in the areas with just a 10 foot 3. Landscape waiver from Sec. 5.5.3.F.ii.b(1) for a reduction in the total number multifamily unit trees provided (147 trees required,

127 provided) as the reduction is only 14% from the total requirements and the site is otherwise well-landscaped 4. Landscape waiver from Sec. 5.5.3.F.ii.B(2) for the reduction in the number of interior roadway perimeter trees provided (1 tree short) due to conflict with fire access lane (grass pavers) 5. Landscape waiver from Sec. 5.5.3.D. for the deficiency in the foundation landscaping coverage around the parking deck due

to limited space available along the southwest side, along the railroad. Large arborvitaes are proposed in that area to help screen the view of the railroad and the industrial site 6. Landscape waiver from Sec. 5.5.3.C.(3) Chart footnote for not proposing the required parking lot perimeter trees for the temporary gravel parking proposed to be constructed for use by visitors to Novi Cemetery in Phase 1 (11 trees required, 0 proposed) as the landscape requirements will be met at the time

of Phase 3 construction within a certain time mutually agreed

ADDITIONAL LANDSCAPE WAIVERS APPROVED BY THE PLANNING COMMISSION ON 12/9/2020: Revision of the landscape waiver from Sec 5.5.3.F.ii.b(1) for a deficiency in the number of total number multifamily unit trees provided (171 required, 129 provided) as the number of ground floor

units has increased but the building footprint has not changed and

between the applicant and the Cit;

the site is otherwise well-landscaped

OPEN SPACE CALCULATIONS

SHEET L1.00 - COVER

SHEET L2.01

SHEET L3.00

SHEET L4.00

SHEET L4.02

SHEET L5.02

SHEET L2.00 - HARDSCAPE

- HARDSCAPE

HARDSCAPE

HARDSCAPE

HARDSCAPE

DIMENSION

DIMENSION

DIMENSION

DIMENSION

DIMENSION

LANDSCAPE

LANDSCAPE

LANDSCAPE

LANDSCAPE

LANDSCAPE

LANDSCAPE

IRRIGATION

IRRIGATION

IRRIGATION

IRRIGATION

IRRIGATION

GRADING

GRADING

SITE DETAILS

SITE DETAILS

SITE DETAILS

SITE DETAILS

SHEET L9.04 - SITE DETAILS

GENERAL LANDSCAPE DETAILS

LANDSCAPE

OPEN SPACE REQUIREMENTS: TOTAL PARCEL X 15% = 6.87 AC X .15 = 1.03 AC

OPEN SPACE PROVIDED: EAST PARK AREA (AS SHOWN) 7,671 SF SOUTH PARK AREA (AS SHOWN) 9,583 SF

8,956 SF POOL AREA (AS SHOWN) ADDITIONAL OPEN SPACE:

BUILDING 1 BALCONIES 7,690 SF CLUB HOUSE (AS SHOWN) 7,127 SF COURTYARDS (AS SHOWN) 6,752 SF BUILDING 2

7,297 SF **BALCONIES** FITNESS ROOM (AS SHOWN) 3,162 SF COURTYARDS (AS SHOWN) 6752 SF 64,990 SF = 1.49 AC |

10 MILE ROAD

MAP

LOCATION

NOT TO SCALE

DESIGNED BY: DRAWN BY

PLOT DATE:

07/02/2019

LAOR:

SPENCER J. OKESON S.J.O. & I.K. DANIEL R. ERLANDSON 06/25/2021

ISSUE FOR PRICING/BIDDING:

ISSUE FOR PERMIT APPLICATION

ISSUE FOR CONSTRUCTION: ISSUE DATE

	REVISION SCHEDULE						
NO:	DATE:	DESCRIPTION:					
B	08/14/2020	ADDENDUM B					
\bigcirc	09/25/2020	ADDENDUM C					

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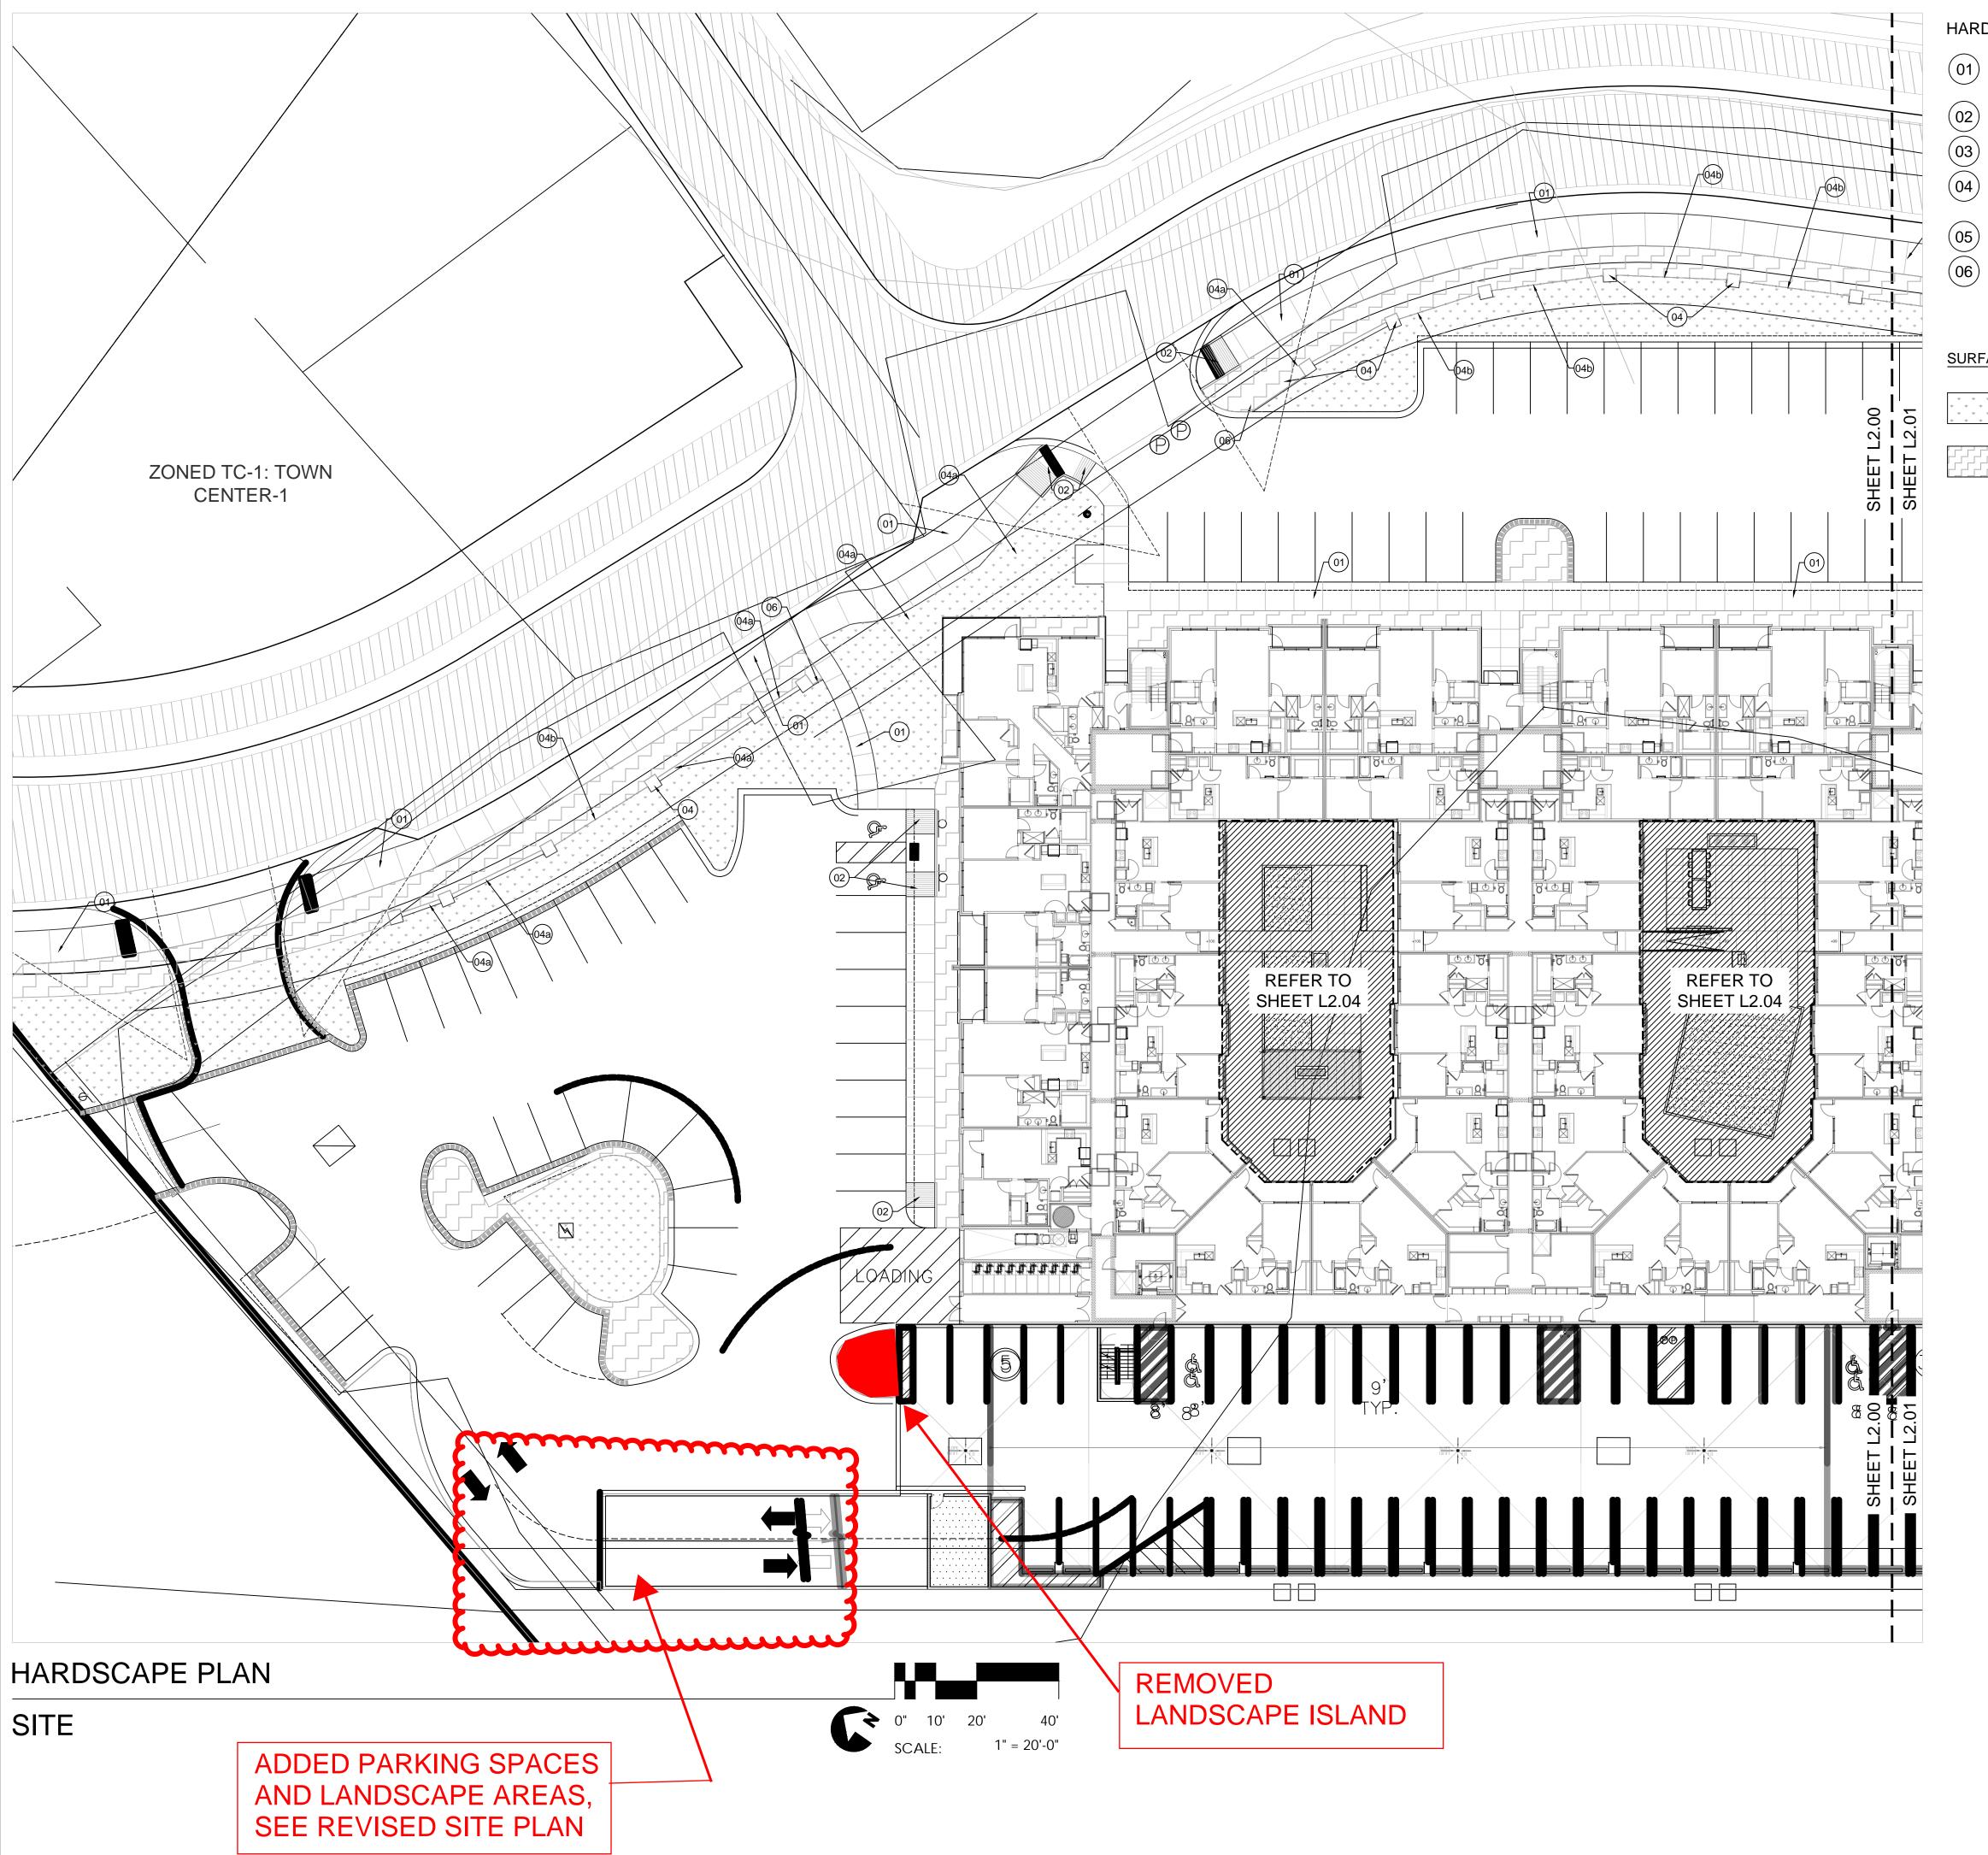


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W: www.hplastudio.com CLIENT DTN MANAGEMENT 2502 LAKE LANSING RD LANSING, MI 48912

SHEET TITLE COVER SHEET

SHEET NUMBER



HARDSCAPE LEGEND - SITE

- O1 CONCRETE SIDEWALK (REFER TO DETAIL 01/L9.00) COLOR: STANDARD GRAY | FINISH: LIGHT BROOM SCORE SIZE: SEE PLAN
- ACCESSIBLE CURB RAMP (REFER TO CIVIL DRAWINGS)
- COLORED CONCRETE (REFER TO DETAIL 01/L9.00) COLOR: SANDSTONE | FINISH: LIGHT BROOM | SCORE SIZE: SEE PLAN
- SITE SCREEN WALL (REFER DETAIL 22/L9.04) -04a: MASONRY WALL SEGMENT 245 L.F. -04b: FENCE WALL SEGMENT 170 L.F.
 - MONUMENT SIGN (REFER TO DETAIL 23/L9.04)
- PLASTIC LANDSCAPE EDGING (BY: SURELOCEDGING.COM) 880 L.F. PRODUCT: ELITE-EDGE | PRODUCT NUMBER: #PE6A

NOTE: FOR ALL OUTDOOR FURNISHINGS, REFER TO INTERIOR ARCHITECTURE DRAWINGS

IRFACE MATERIALS	
DESCRIPTION	QUANTITY
LAWN GRASS HYBRID (SEED)	22,810 S.F.

SHREDDED HARDWOOD MULCH IN ALL LANDSCAPE 24,175 S.F. AREAS

6" DEPTH PLANT MIX IN ALL PLANTING BEDS 4" DEPTH TOPSOIL IN ALL NEW LAWN AREAS (INCLUDES 3" DEPTH TOPSOIL AT COURTYARD AREAS)

DESIGNED BY: SPENCER J. OKESON DRAWN BY: DANIEL R. ERLANDSON

PLOT DATE:

ISSUE FOR PRICING/BIDDING:

ISSUE FOR PERMIT APPLICATION:

ISSUE FOR CONSTRUCTION: ISSUE DATE

REVISION SCHEDULE

DATE: DESCRIPTION: ADDENDUM B 08/14/2020 ADDENDUM C

S.J.O. & I.K.

06/25/2021

09/25/2020

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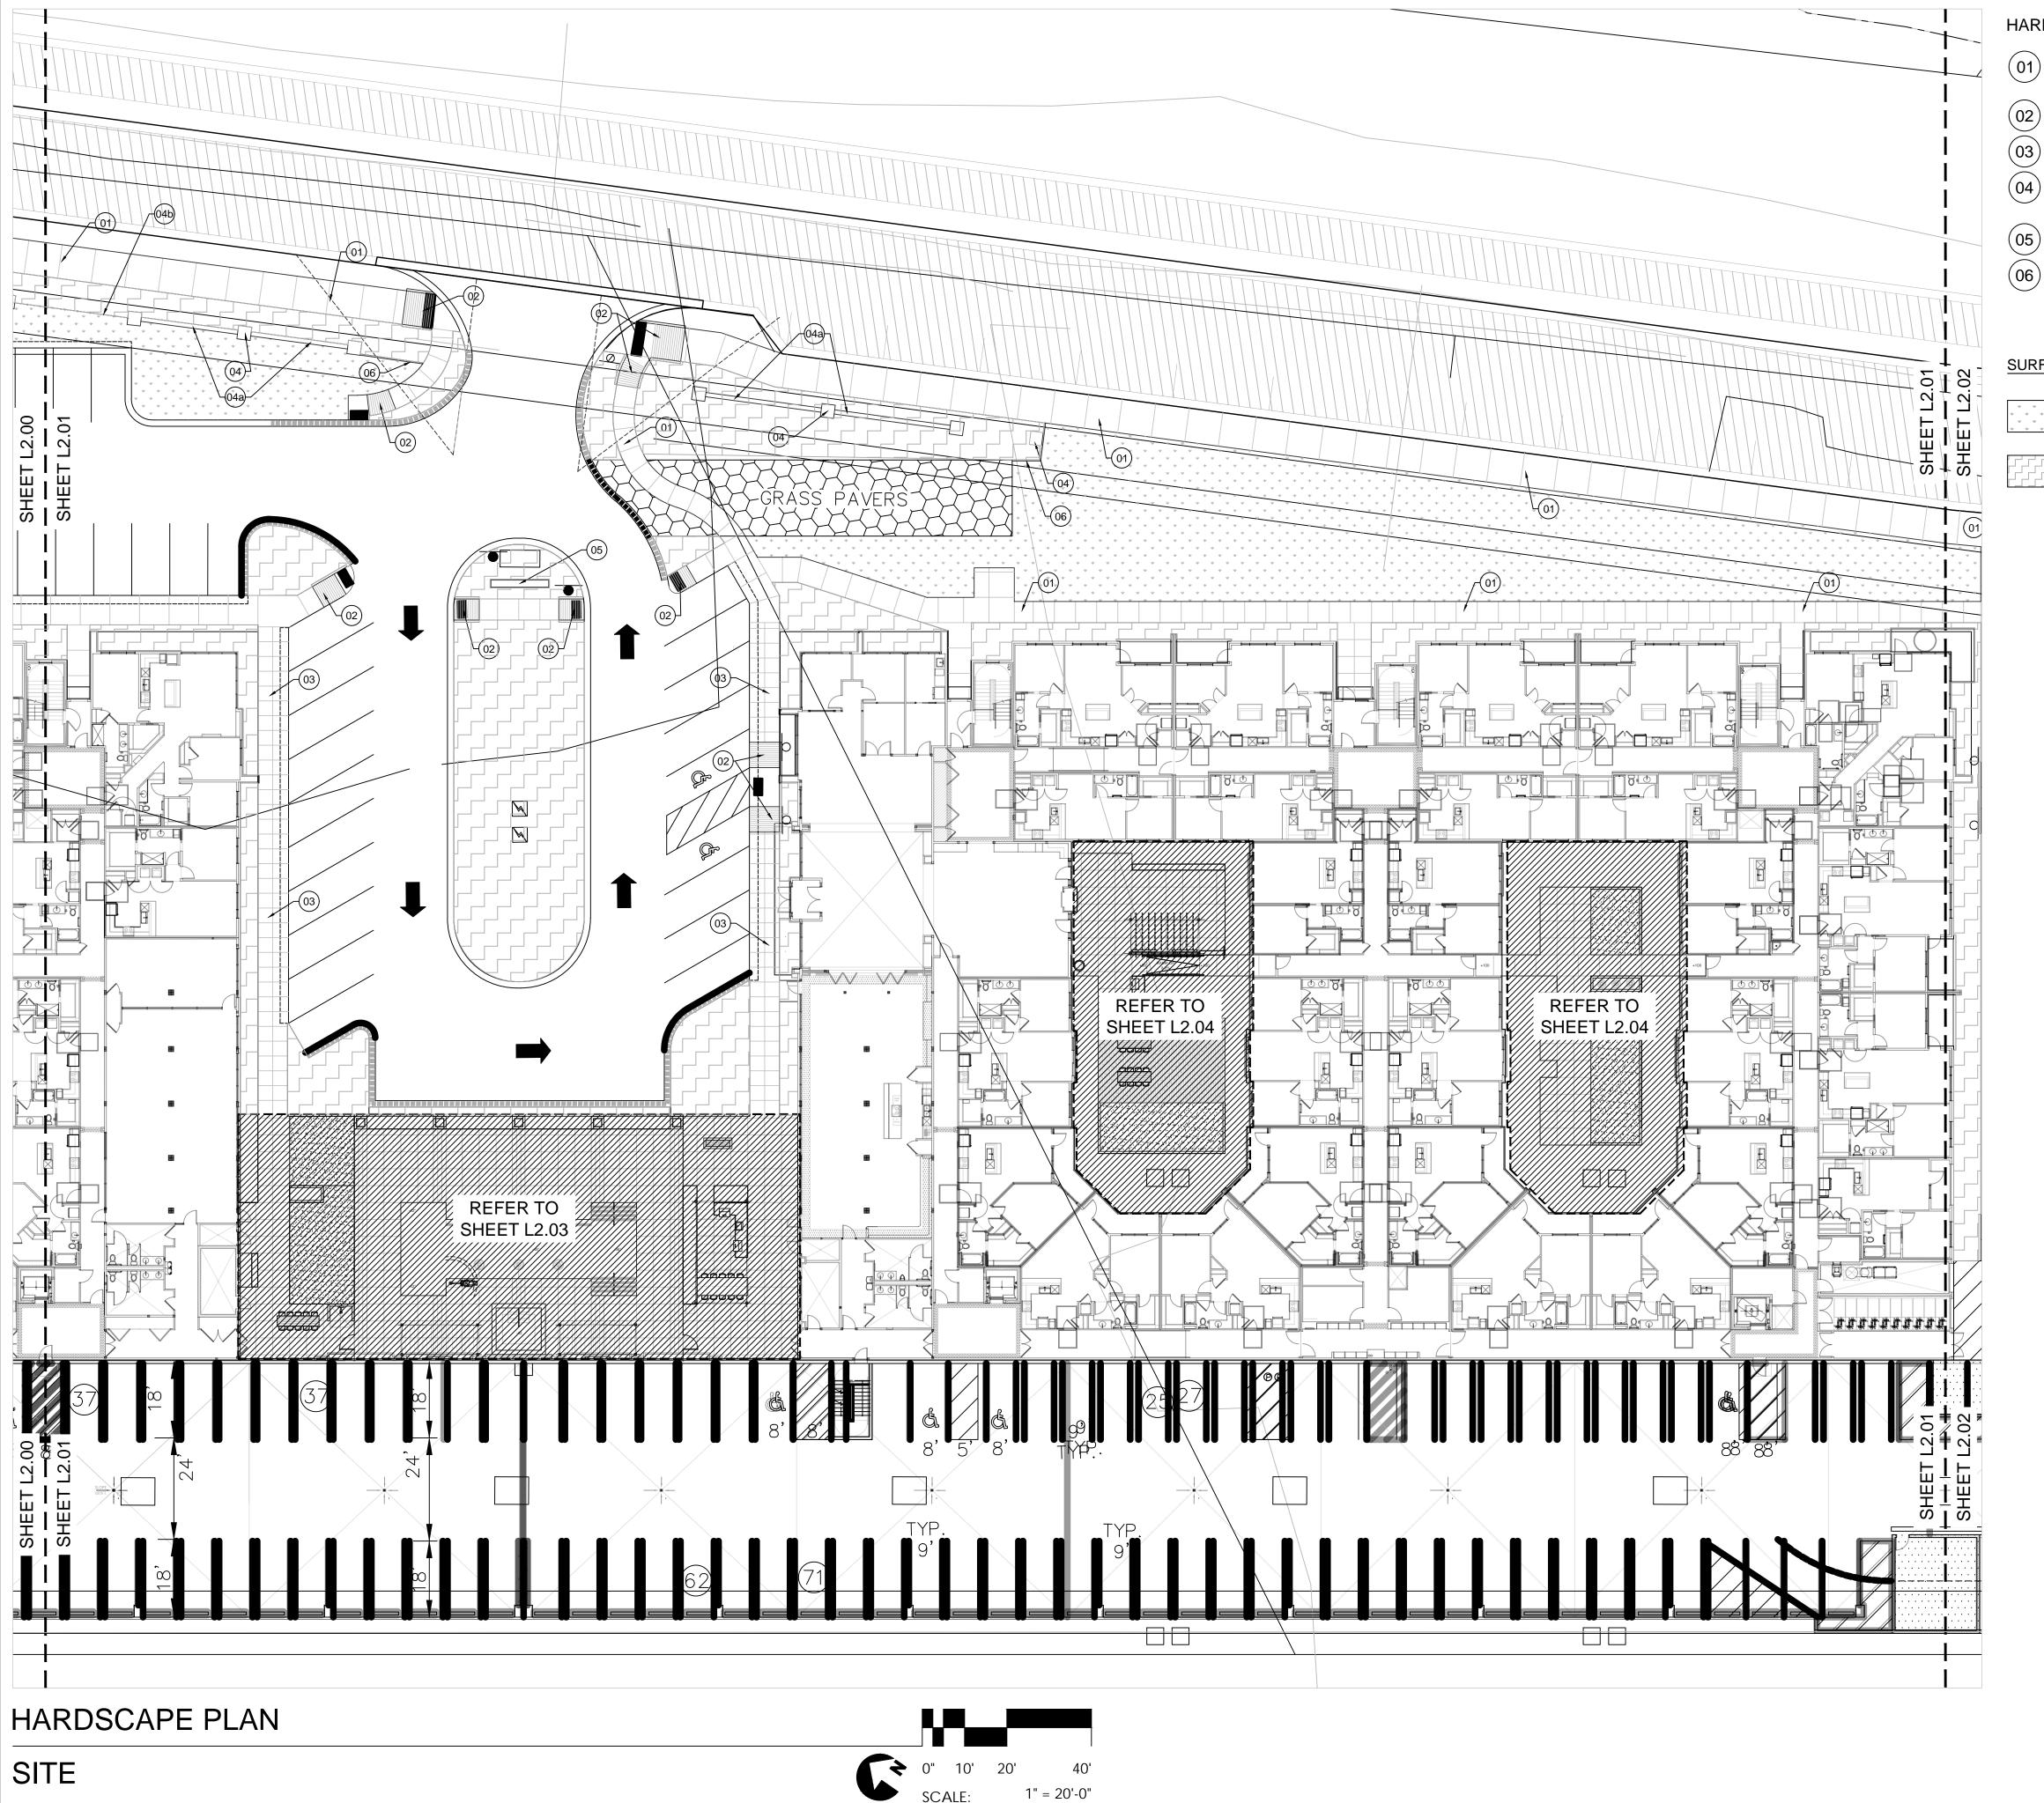
CLIENT DTN MANAGEMENT 2502 LAKE LANSING RD

LANSING, MI 48912

SHEET TITLE

HARDSCAPE PLAN

SHEET NUMBER



HARDSCAPE LEGEND - SITE

O1 CONCRETE SIDEWALK (REFER TO DETAIL 01/L9.00)
COLOR: STANDARD GRAY | FINISH: LIGHT BROOM
SCORE SIZE: SEE PLAN

ACCESSIBLE CURB RAMP (REFER TO CIVIL DRAWINGS)

COLORED CONCRETE (REFER TO DETAIL 01/L9.00) 1,620 S.F. COLOR: SANDSTONE | FINISH: LIGHT BROOM | SCORE SIZE: SEE PLAN

O4 SITE SCREEN WALL (REFER DETAIL 22/L9.04)
-04a: MASONRY WALL SEGMENT 245 L.F.
-04b: FENCE WALL SEGMENT 170 L.F.

5) MONUMENT SIGN (REFER TO DETAIL 23/L9.04)

PLASTIC LANDSCAPE EDGING (BY: SURELOCEDGING.COM) 880 L.F. PRODUCT: ELITE-EDGE | PRODUCT NUMBER: #PE6A

NOTE: FOR ALL OUTDOOR FURNISHINGS, REFER TO INTERIOR ARCHITECTURE DRAWINGS

SURFACE MATERIALS

DESCRIPTION QUANTITY

LAWN GRASS HYBRID (SEED) 22,810 S.F.

SHREDDED HARDWOOD MULCH IN ALL LANDSCAPE 24,175 S.F. AREAS NOTES:

6" DEPTH PLANT MIX IN ALL PLANTING BEDS
4" DEPTH TOPSOIL IN ALL NEW LAWN AREAS (INCLUDES 3" DEPTH
TOPSOIL AT COURTYARD AREAS)

DESIGNED BY: DRAWN BY:

PLOT DATE:

NO:

SPENCER J. OKESON S.J.O. & I.K. DANIEL R. ERLANDSON 06/25/2021

ISSUE FOR PRICING/BIDDING:

ISSUE FOR PERMIT APPLICATION: 01/22/2021

ISSUE FOR CONSTRUCTION:

ISSUE DATE

DEVISION SCHEDI II E

REVISION SCHEDULE

 DATE:
 DESCRIPTION:

 08/14/2020
 ADDENDUM B

 09/25/2020
 ADDENDUM C

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SUITE C,
LANSING, MI 48912

SHEET TITLE


HARDSCAPE PLAN

SHEET NUMBER

1201

SCALE: AS INDICATED
CITY JOB #: JSP18-0010

REVISED PER CITY OF NOVI ELEC. STAMPII

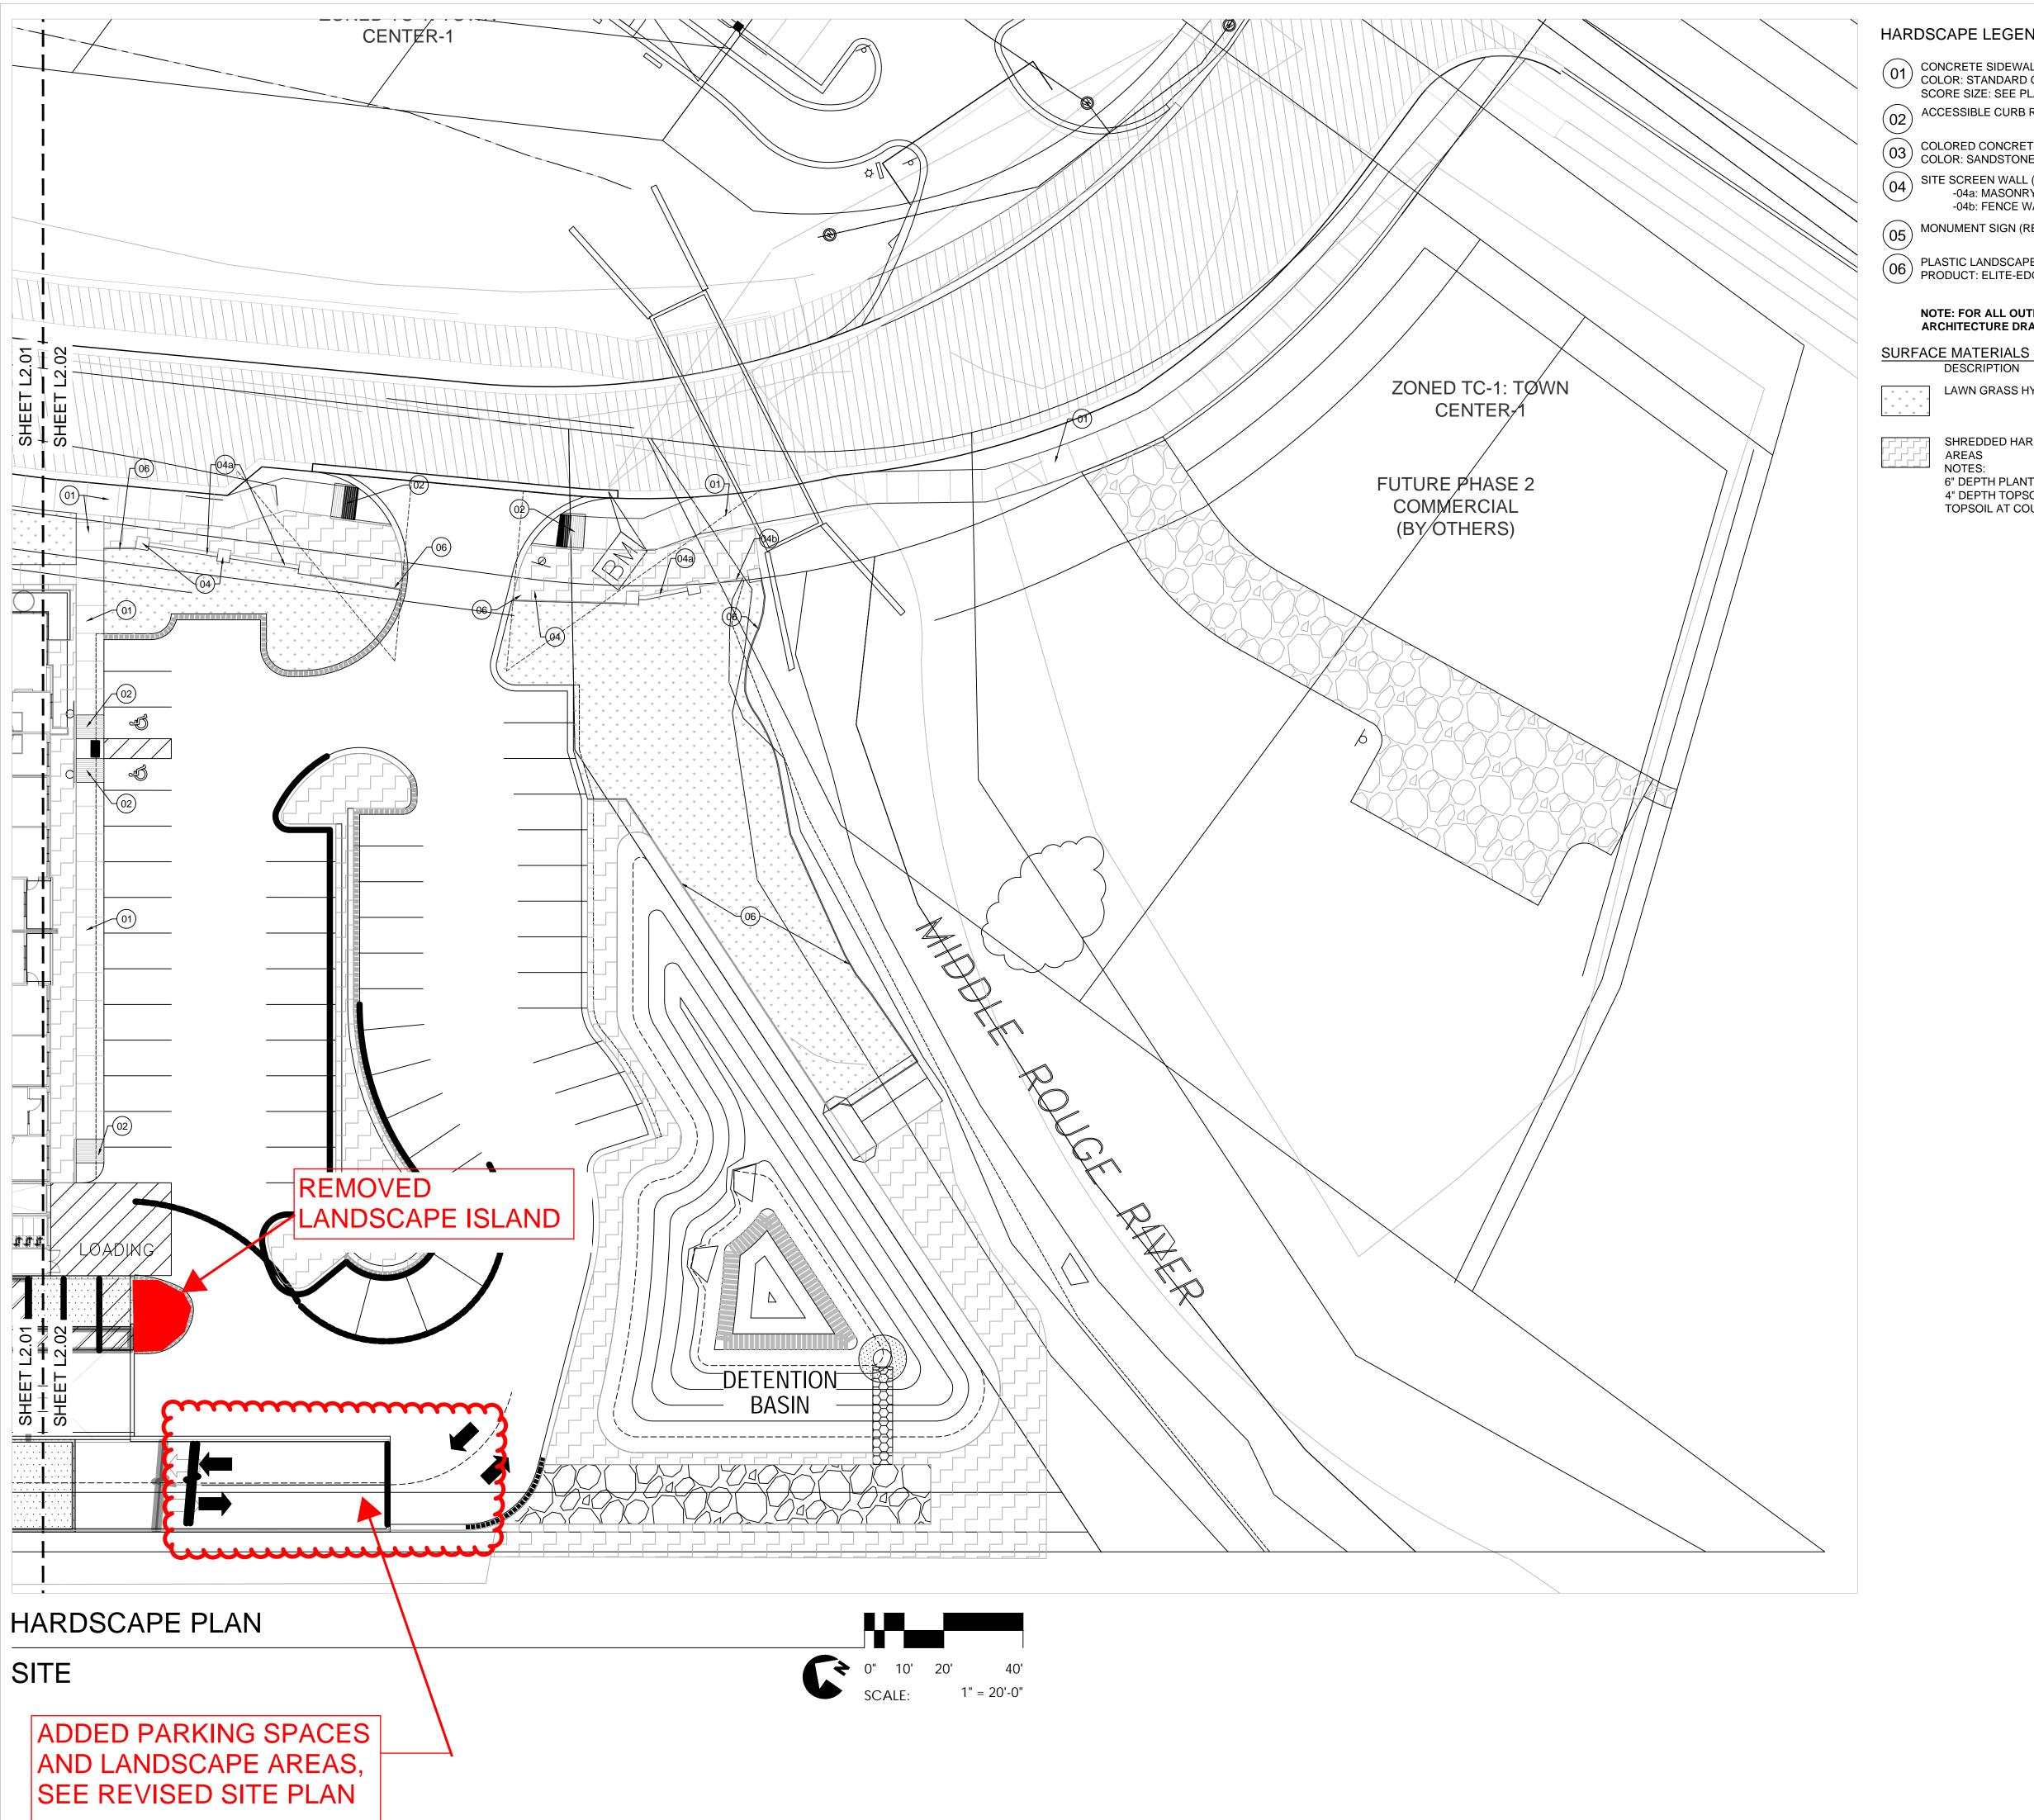

HARDSCAPE LEGEND - SITE

- O1) CONCRETE SIDEWALK (REFER TO DETAIL 01/L9.00) COLOR: STANDARD GRAY | FINISH: LIGHT BROOM SCORE SIZE: SEE PLAN
- ACCESSIBLE CURB RAMP (REFER TO CIVIL DRAWINGS)
- COLORED CONCRETE (REFER TO DETAIL 01/L9.00) 1,620 S.F. COLOR: SANDSTONE | FINISH: LIGHT BROOM | SCORE SIZE: SEE PLAN O4) SITE SCREEN WALL (REFER DETAIL 22/L9.04) -04a: MASONRY WALL SEGMENT 245 L.F.
 - MONUMENT SIGN (REFER TO DETAIL 23/L9.04)

-04b: FENCE WALL SEGMENT

PLASTIC LANDSCAPE EDGING (BY: SURELOCEDGING.COM) 880 L.F. PRODUCT: ELITE-EDGE | PRODUCT NUMBER: #PE6A

NOTE: FOR ALL OUTDOOR FURNISHINGS, REFER TO INTERIOR ARCHITECTURE DRAWINGS

QUANTITY DESCRIPTION LAWN GRASS HYBRID (SEED) 22,810 S.F.

SHREDDED HARDWOOD MULCH IN ALL LANDSCAPE 24,175 S.F. AREAS

6" DEPTH PLANT MIX IN ALL PLANTING BEDS 4" DEPTH TOPSOIL IN ALL NEW LAWN AREAS (INCLUDES 3" DEPTH TOPSOIL AT COURTYARD AREAS)

DESIGNED BY: DRAWN BY:

PLOT DATE:

NO:

170 L.F.

SPENCER J. OKESON S.J.O. & I.K. DANIEL R. ERLANDSON 06/25/2021

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DATE: DESCRIPTION: 08/14/2020 ADDENDUM B 09/25/2020 ADDENDUM C

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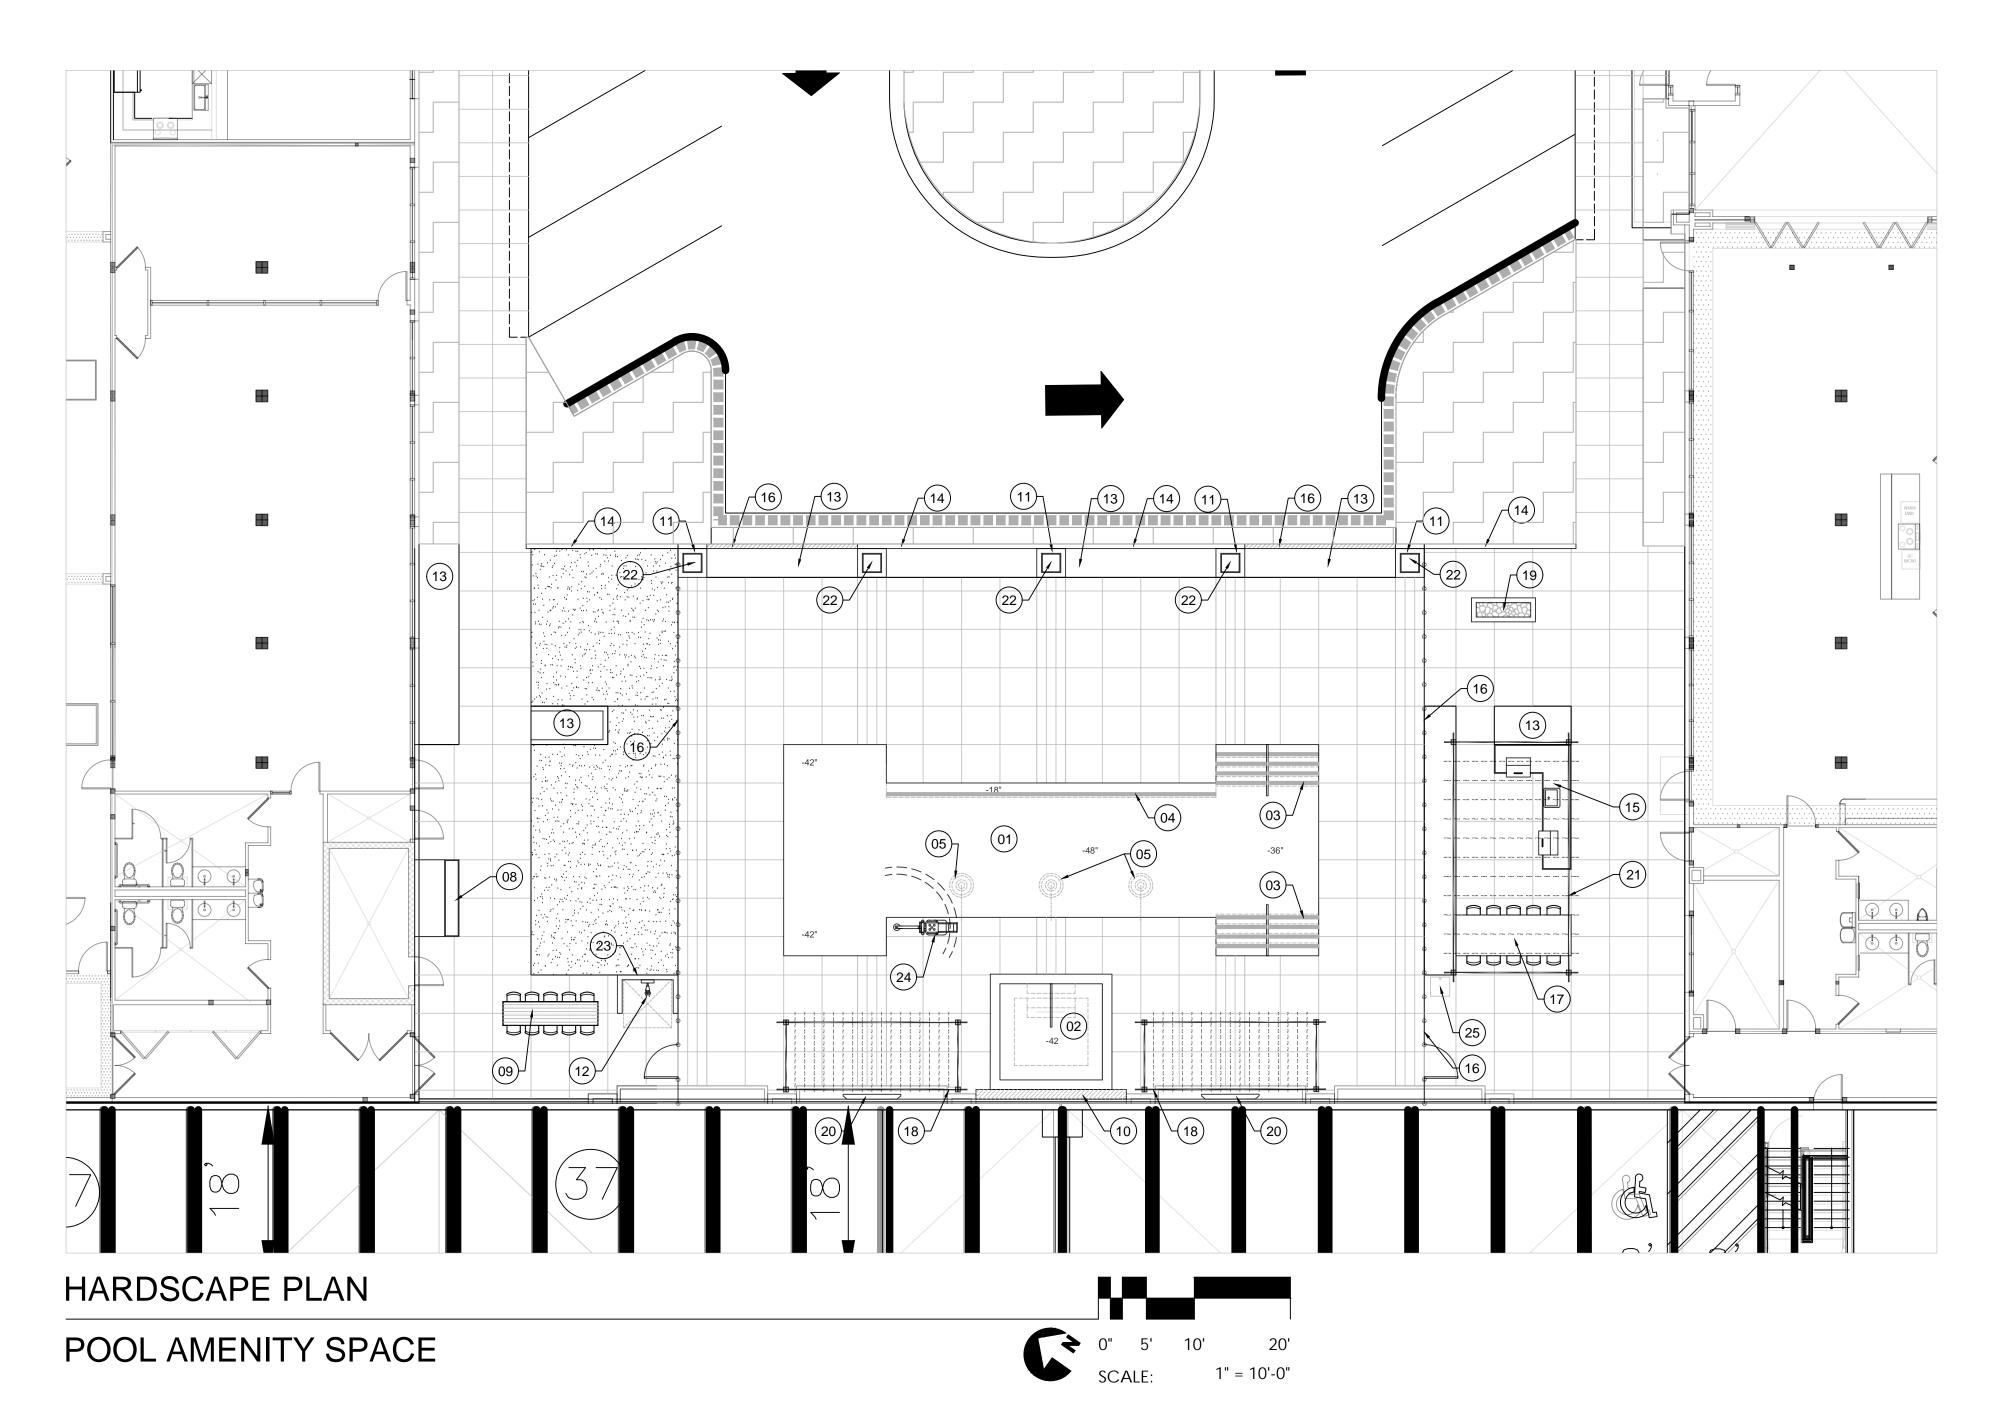
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SHEET TITLE

HARDSCAPE PLAN

SHEET NUMBER



SURFACE MATERIALS

DESCRIPTION

COLORED CONCRETE (BY: DAVIS)

COLORED CONCRETE (BY: DAVIS)

LAWN GRASS HYBRID (SOD)

COLOR: SANDSTONE | FINISH: LIGHT BROOM

COLOR: SANDSTONE | FINISH: LIGHT BROOM

SCORE SIZE: 1' x 4' SAW-CUT (REFER TO DETAIL 01/L9.00)

SCORE SIZE: 4' x 4' SAW-CUT (REFER TO DETAIL 01/L9.00)

3" DECOMPOSED GRANITE (BY LOCAL SUPPLIER) COLOR: TBD | NOTE: INSTALL TO A MIN. 3" DEPTH

ARI	DSCAPE LEGEND - POOL AMENITY SPACE	
01)	SWIMMING POOL (REFER TO POOL SHOP DRAWINGS) (1) INTERIOR FINISH: EXPOSED AGGREGATE POOL FINISH (BY: DIAMOND BRITE) COLOR: COOL BLUE	945 S.F.
	 (2) TILE LINE: 2" x 2" MOSAIC COLORBODY (BY: DALTILE) COLOR: 50% SEA SPEC (D372), 50% OCEAN BLUE (ABRASI' (3) COPING: 12" x 24" BULLNOSED PAVER (BY: HANOVER) COLOR: NATURAL FINISH: GROUND FINISH 	VE)
	 (4) IN-POOL LIGHTING: PENTAIRE GLOBERITE LED (5) CAULKING OVER ³/₈" TO ¹/₂" CLOSED CELL EXP JT - CONT. (6) MIN. WATER DEPTH 3'-6" 	
02)	 18" RAISED HEATED SPA (REFER TO POOL SHOP DRAWINGS) (1) INTERIOR FINISH: EXPOSED AGGREGATE POOL FINISH (BY: DIAMOND BRITE) COLOR: COOL BLUE (2) TILE LINE: 2" x 2" MOSAIC COLORBODY (BY: DALTILE) 	110 S.F.
	 (2) TILE LINE: 2 X 2 MOSAIC COLORBODT (BT. DALTILE) COLOR: 50% SEA SPEC (D372), 50% OCEAN BLUE (ABRASI' (3) COPING: 24" x 24" BULLNOSED PAVER (BY: HANOVER) COLOR: NATURAL FINISH: GROUND FINISH (4) IN-POOL LIGHTING: PENTAIRE GLOBERITE LED (5) CLEANING: SKIMMERS W/ DEDICATED LINE FOR CLEANER (6) MIN. WATER DEPTH 3'-0" 	ŕ
03)	POOL STEPS/HANDRAIL (REFER TO POOL SHOP DRAWINGS)	
04	IN-POOL BENCH (REFER TO POOL SHOP DRAWINGS)	35 L.F.
05)	DECK JETS (BY: JANDY.COM) PRODUCT #: JDJ2004 REFER TO POOL SHOP DRAWINGS	QTY: 03
06	2" x 2" TILE (BY: DALTILE) TYPE: MOSAIC COLORBODY COLOR: 50% SEA SPEC (D372), 50% OCEAN BLUE (ABRASIVE)	145 S.F.
07	NOT IN USE	
08)	CMU SEAT WALL (REFER TO DETAIL 02/L9.00)	8 L.F.
09)	PREFAB COMMUNITY TABLE (INTERIOR DESIGNER TO COORDINATE PRODUCT INFO & COLORS W/ L.A. FOR APPROVAL FOCAL ARTWORK ON GARAGE WALL (BY OTHERS)	QTY: 01 _)
11)	RAISED CMU PLINTH (REFER TO DETAIL 07/L9.00)	QTY: 05
12	WALL MOUNTED POOL SHOWER (REF. TO POOL SHOP DWGS) NOTE: INSTALL FLOOR DRAIN TO SANITARY SEWER	QTY: 01
13	LANDSCAPE AREA (REFER TO LANDSCAPE PLANS)	
14)	5' WOOD SLAT FENCE (REFER TO DETAIL 08/L9.00)	80 L.F.
15	BBQ COUNTER (REFER TO DETAIL 09/L9.01)	
16	48" WELDED WIRE MESH POOL FENCE/GATE (REFER TO DETAIL 10/L9.01)	135 L.F.
17	PREFAB COMMUNITY TABLE (INTERIOR DESIGNER TO COORDINATE PRODUCT INFO & COLORS W/ L.A. FOR APPROVAL	QTY: 01 -)
18	CUSTOM SHADE STRUCTURE (BY OTHERS - FF&E)	QTY: 02
19)	FIRE TROUGH (REFER TO DETAIL 11/L9.01)	
20)	OUTDOOR RATED T.V. (BY OWNER)	QTY: 02
21)	SHADE STRUCTURE (BY OTHERS - FF&E)	OTV 05
22)	LIGHT BOX (REFER TO LIGHTING PLANS)	QTY: 05
23)	CMU SHOWER ENCLOSURE (REFER TO DETAIL 12/L9.01) ADA POOL LIFT (BY: SPECTRUM PRODUCTS)	QTY: 01
24)	MODEL: MOTION TREK ADA BARIATRIC POOL LIFT SLEEVES TO BE PROVIDED AT TWO LOCATIONS SHOWN ON PLAN. SINGLE LIFT TO BE TRANSPORTED AS NEEDED FOR ACCESS TO POOL AND SPA	QIT.UI
25)	PILA FOOR WASH (BY: CALAZZO.COM) (FREE STANDING / SINGLE SUPPLY)	QTY: 01
	NOTE: FOR ALL OUTDOOR FURNISHINGS, REFER TO INTERIOR ARCHITECTURE DRAWINGS	

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SPENCER J. OKESON

DANIEL R. ERLANDSON

DESCRIPTION:

ADDENDUM B

ADDENDUM C

S.J.O. & I.K.

06/25/2021

DESIGNED BY: DRAWN BY:

PLOT DATE:

01/22/2021

ISSUE DATE

NO: DATE:

ISSUE FOR PRICING/BIDDING:

ISSUE FOR CONSTRUCTION:

08/14/2020

09/25/2020

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SHEET TITLE

HARDSCAPE PLAN

SHEET NUMBER


SCALE: AS INDICATED CITY JOB #: JSP18-0010

QUANTITY

515 S.F.

2,100 S.F.

400 S.F.

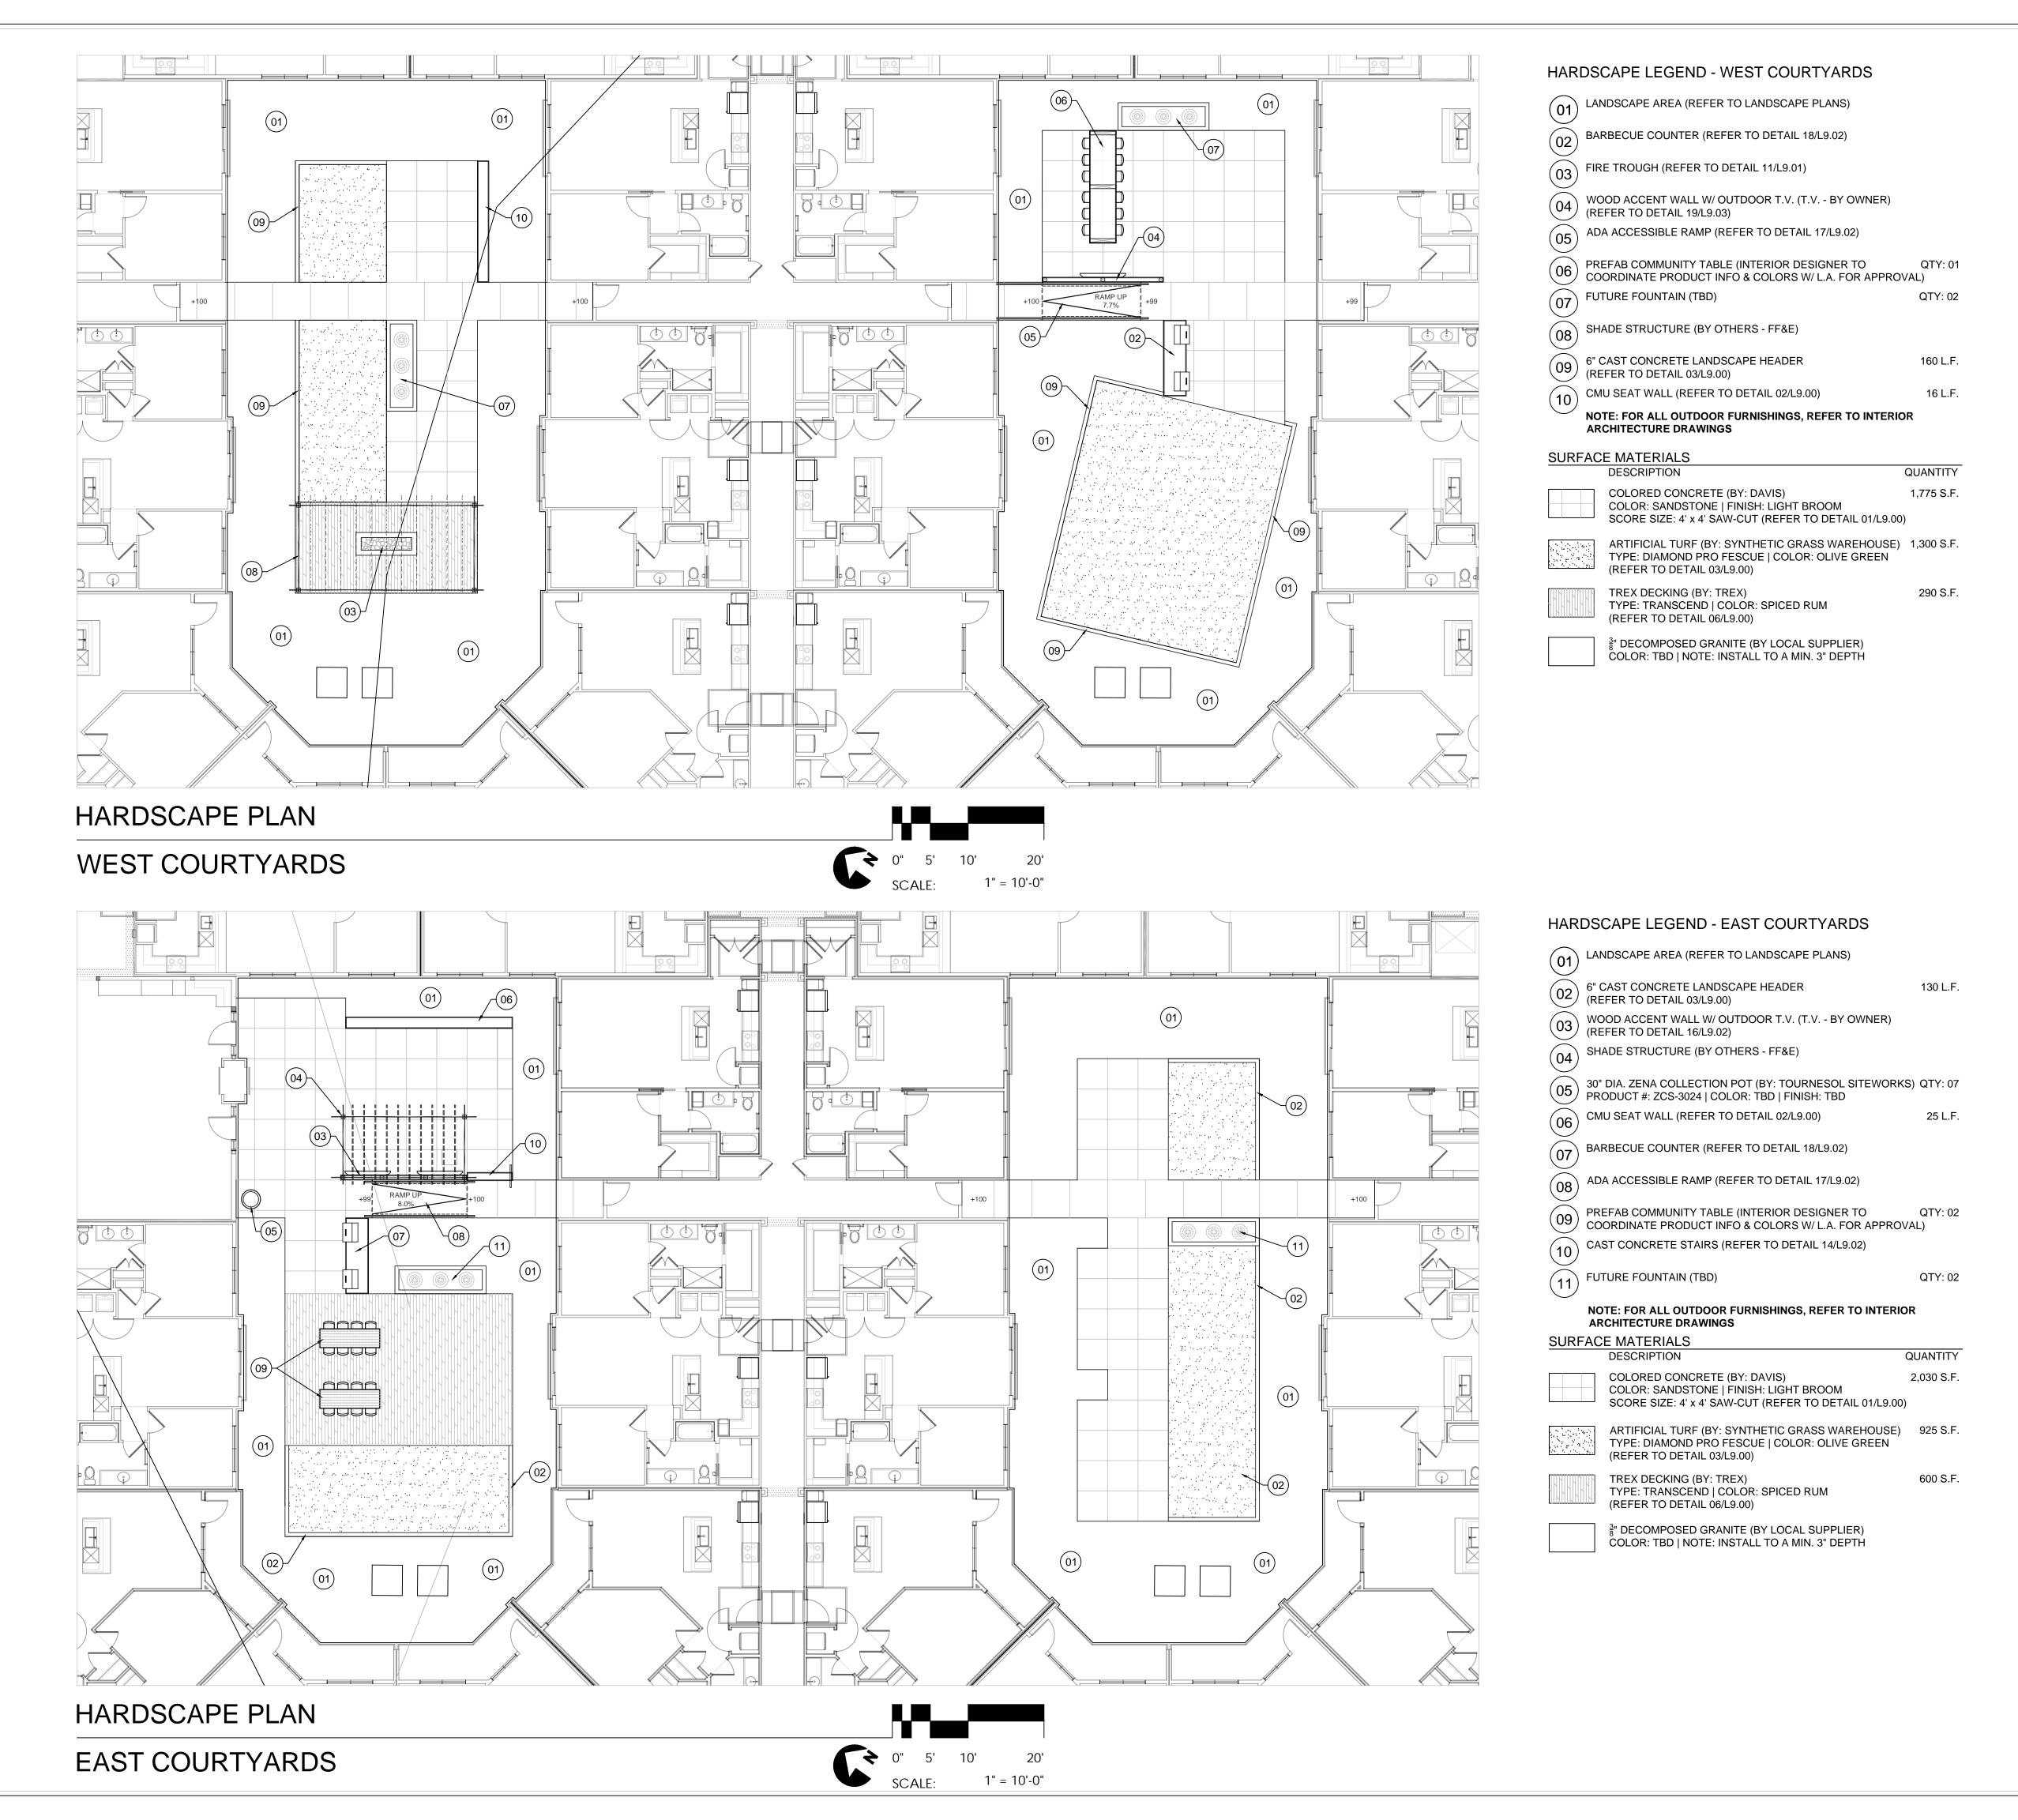

DESIGNED BY: SPENCER J. OKESON DRAWN BY: S.J.O. & I.K. DANIEL R. ERLANDSON

06/25/2021

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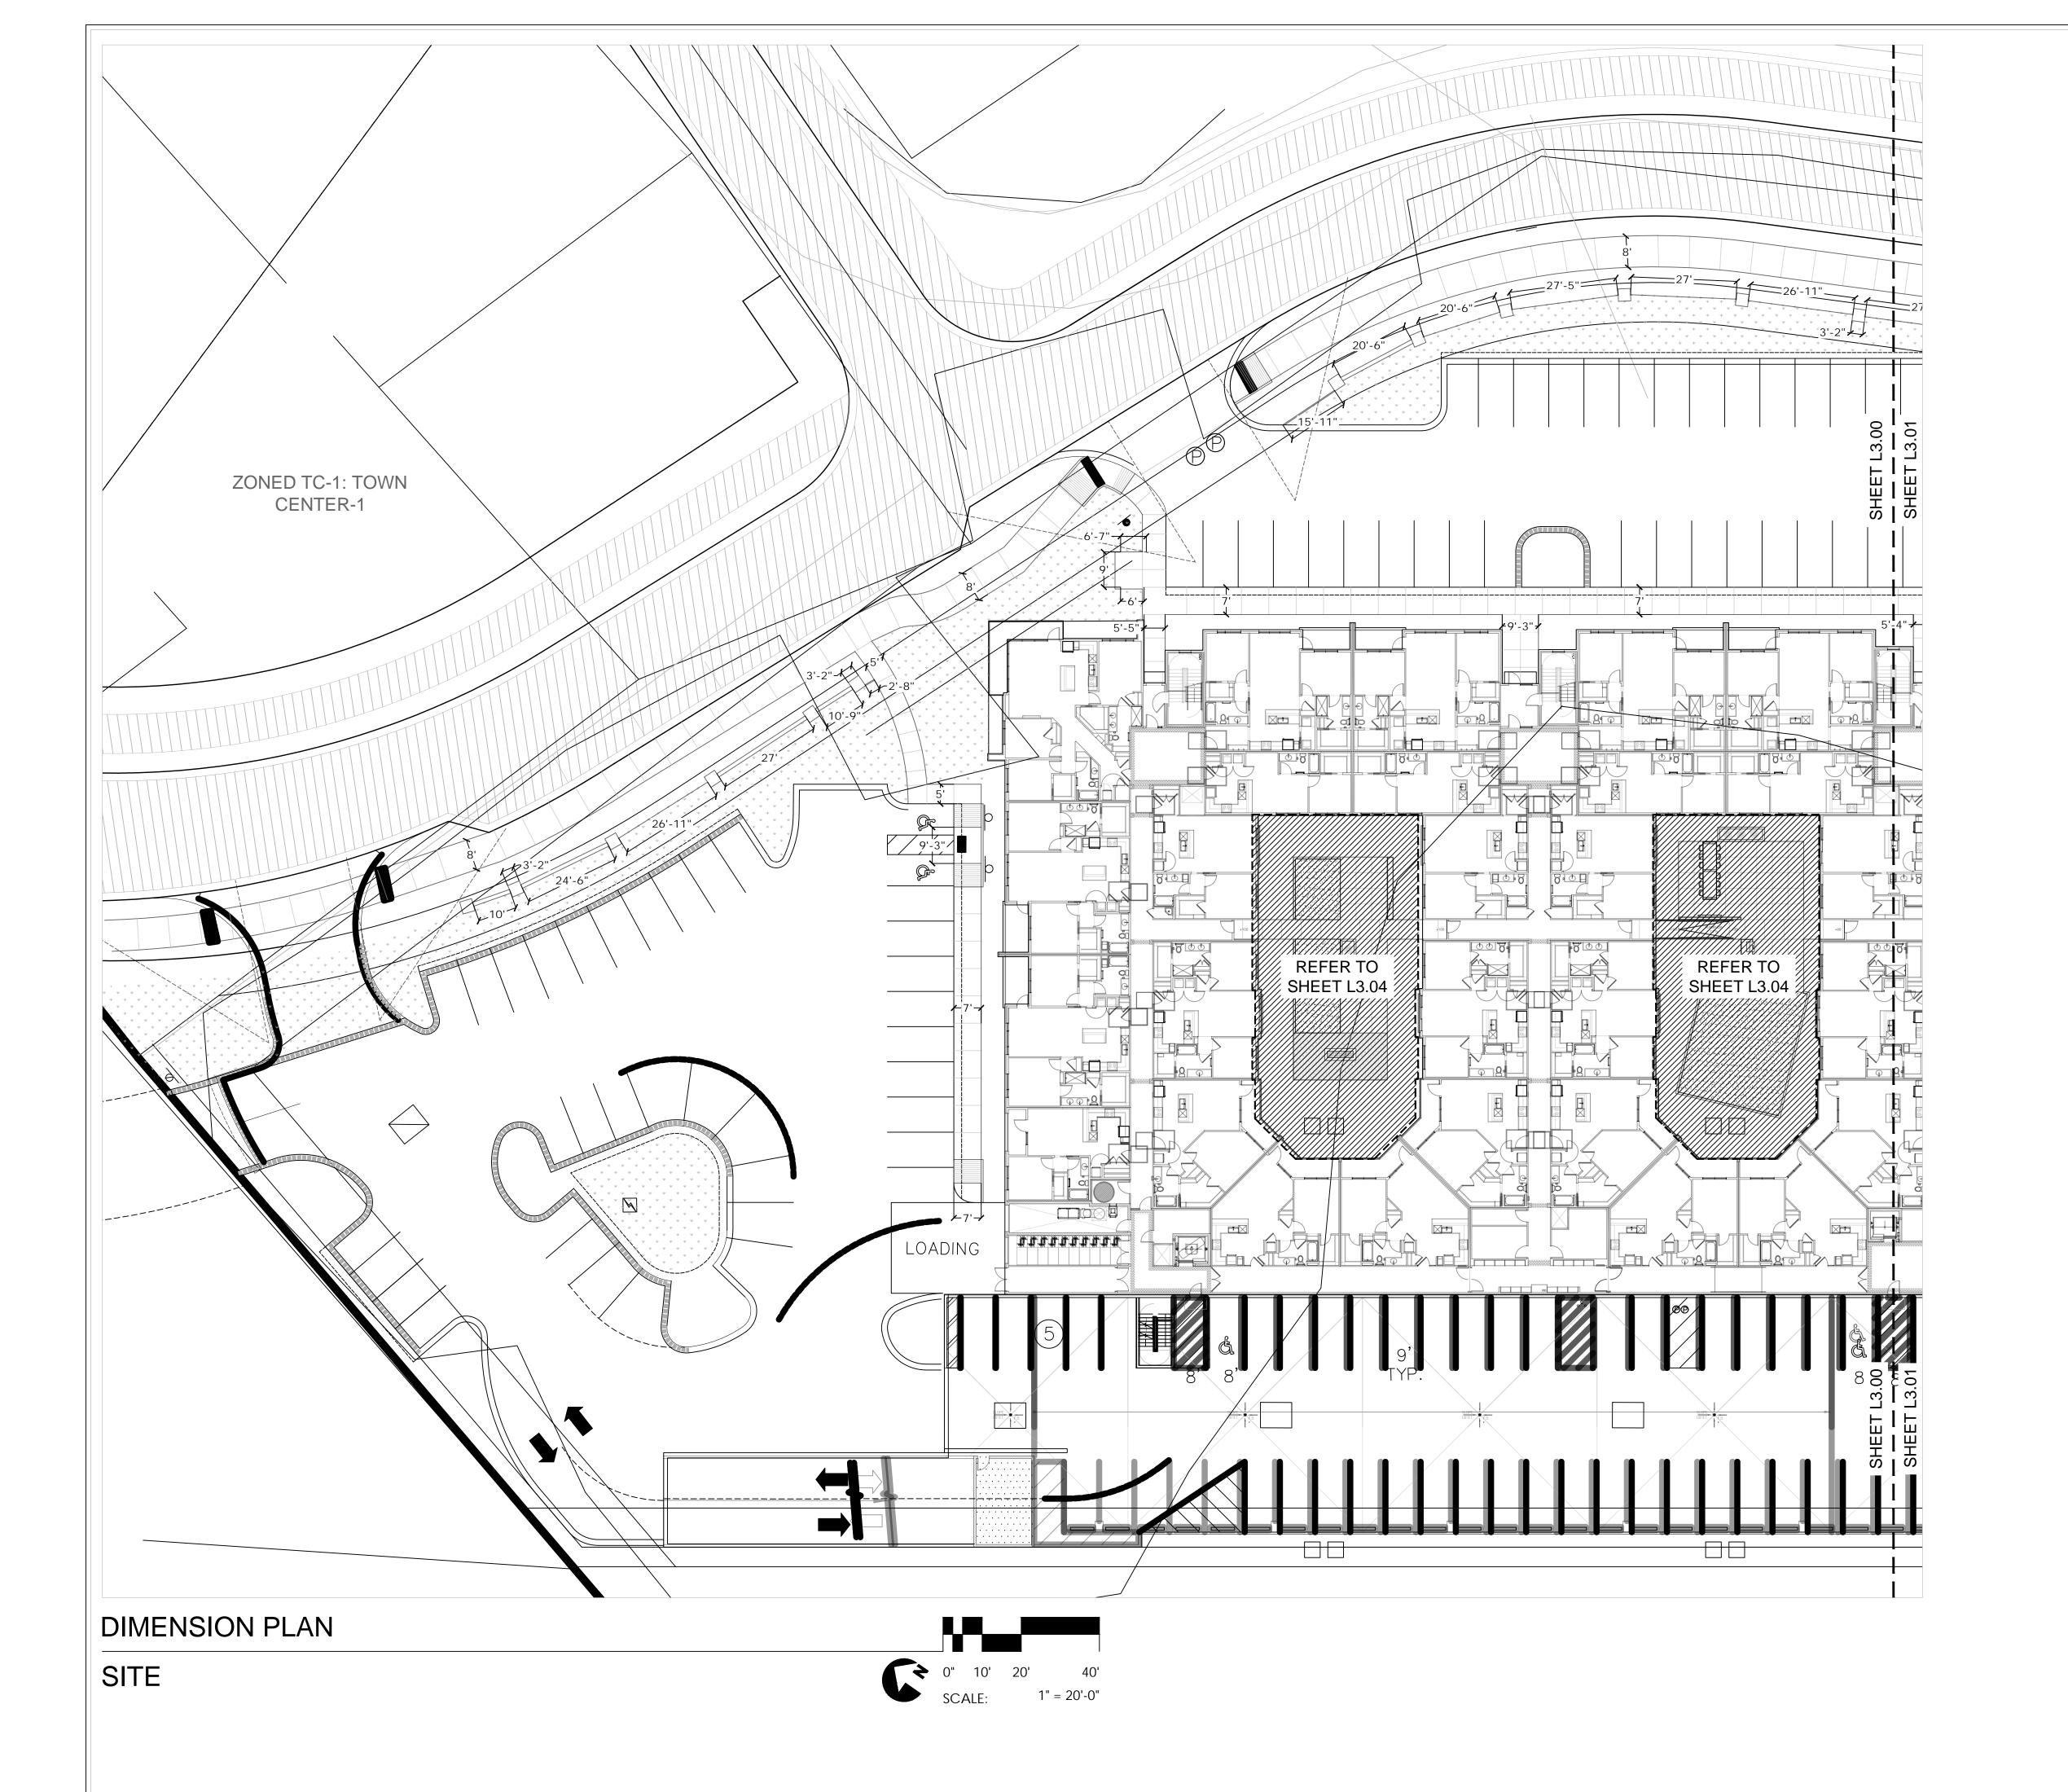
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HARDSCAPE PLAN

SHEET NUMBER



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NO:	DATE:	DESCRIPTION:
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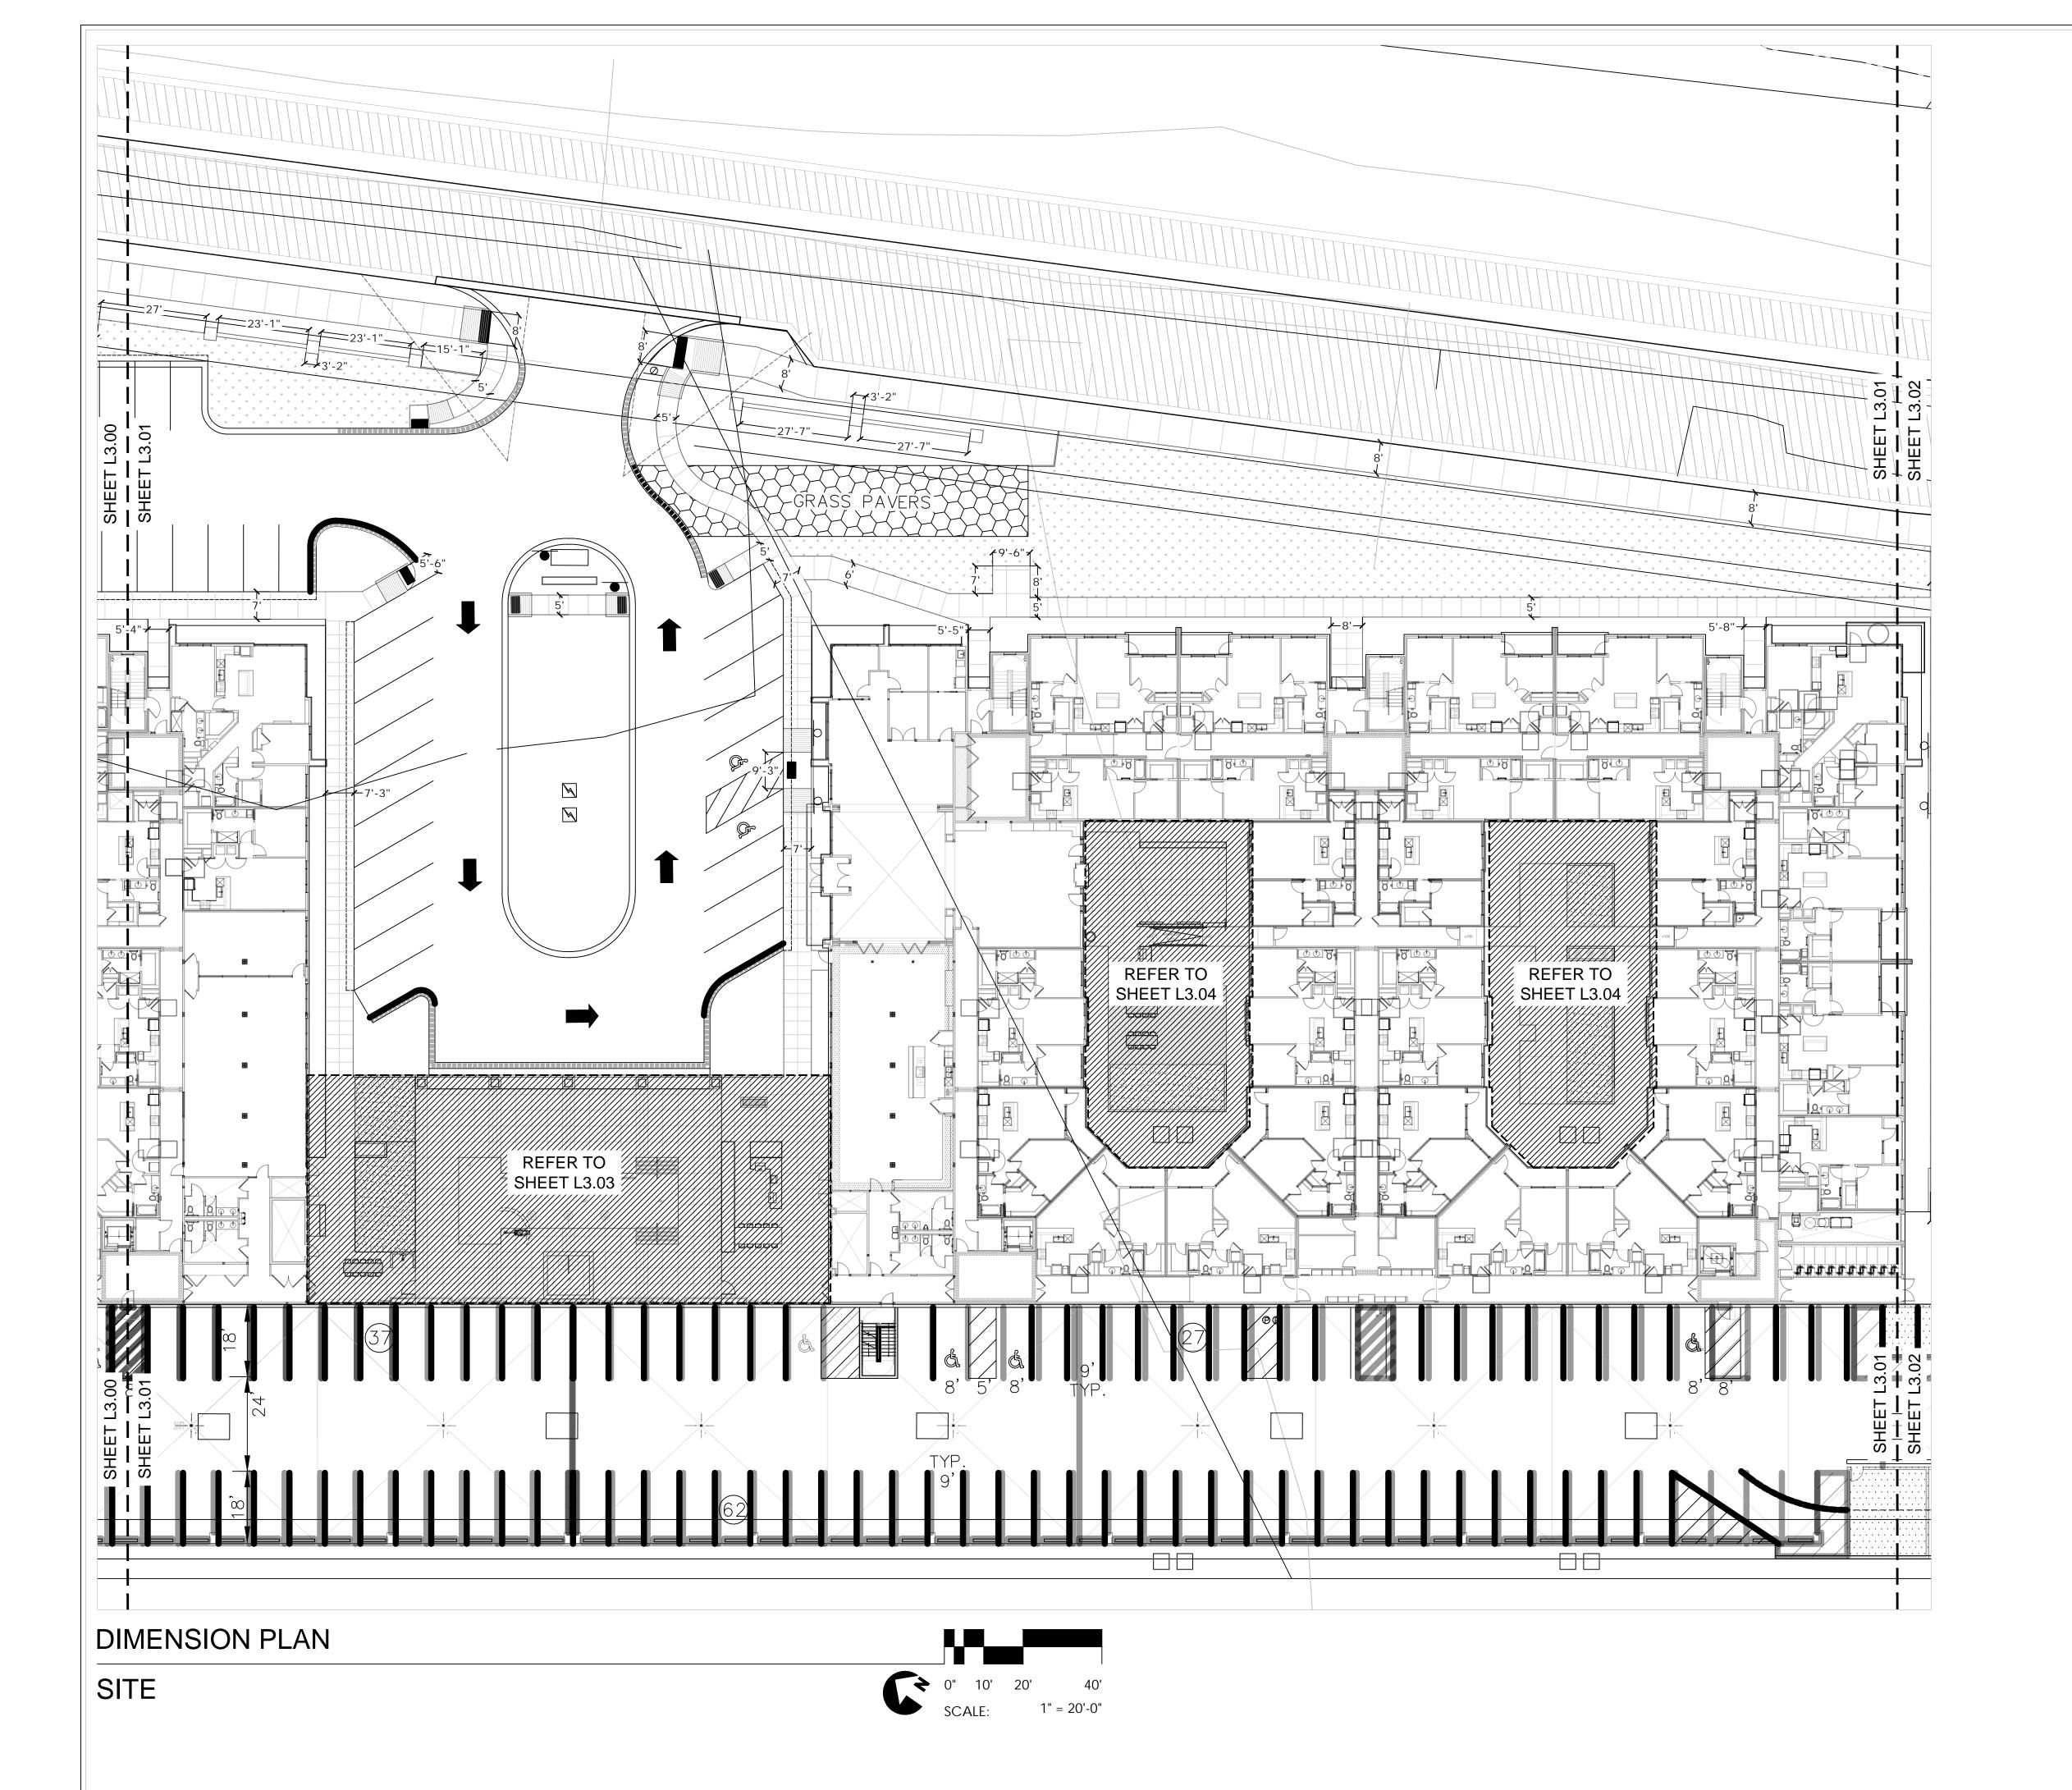
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<u>(C)</u>	09/25/2020	ADDENDUM C


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CLIENT
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SHEET TITLE

DIMENSION PLAN

SHEET NUMBER

L3.01

SCALE: AS INDICATED CITY JOB #: JSP18-0010

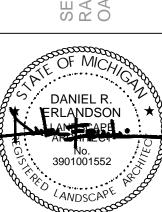VISED PER CITY OF NOVI ELEC. STAMPING - 2021-

PLOT DATE:

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CLIENT
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2502 LAKE LANSING RD
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SHEET TITLE


DIMENSION PLAN

SHEET NUMBER

SCALE: AS INDICATED CITY JOB #: JSP18-0010

EVISED PER CITY OF NOVI ELEC. STAMPING

2021-JUNE

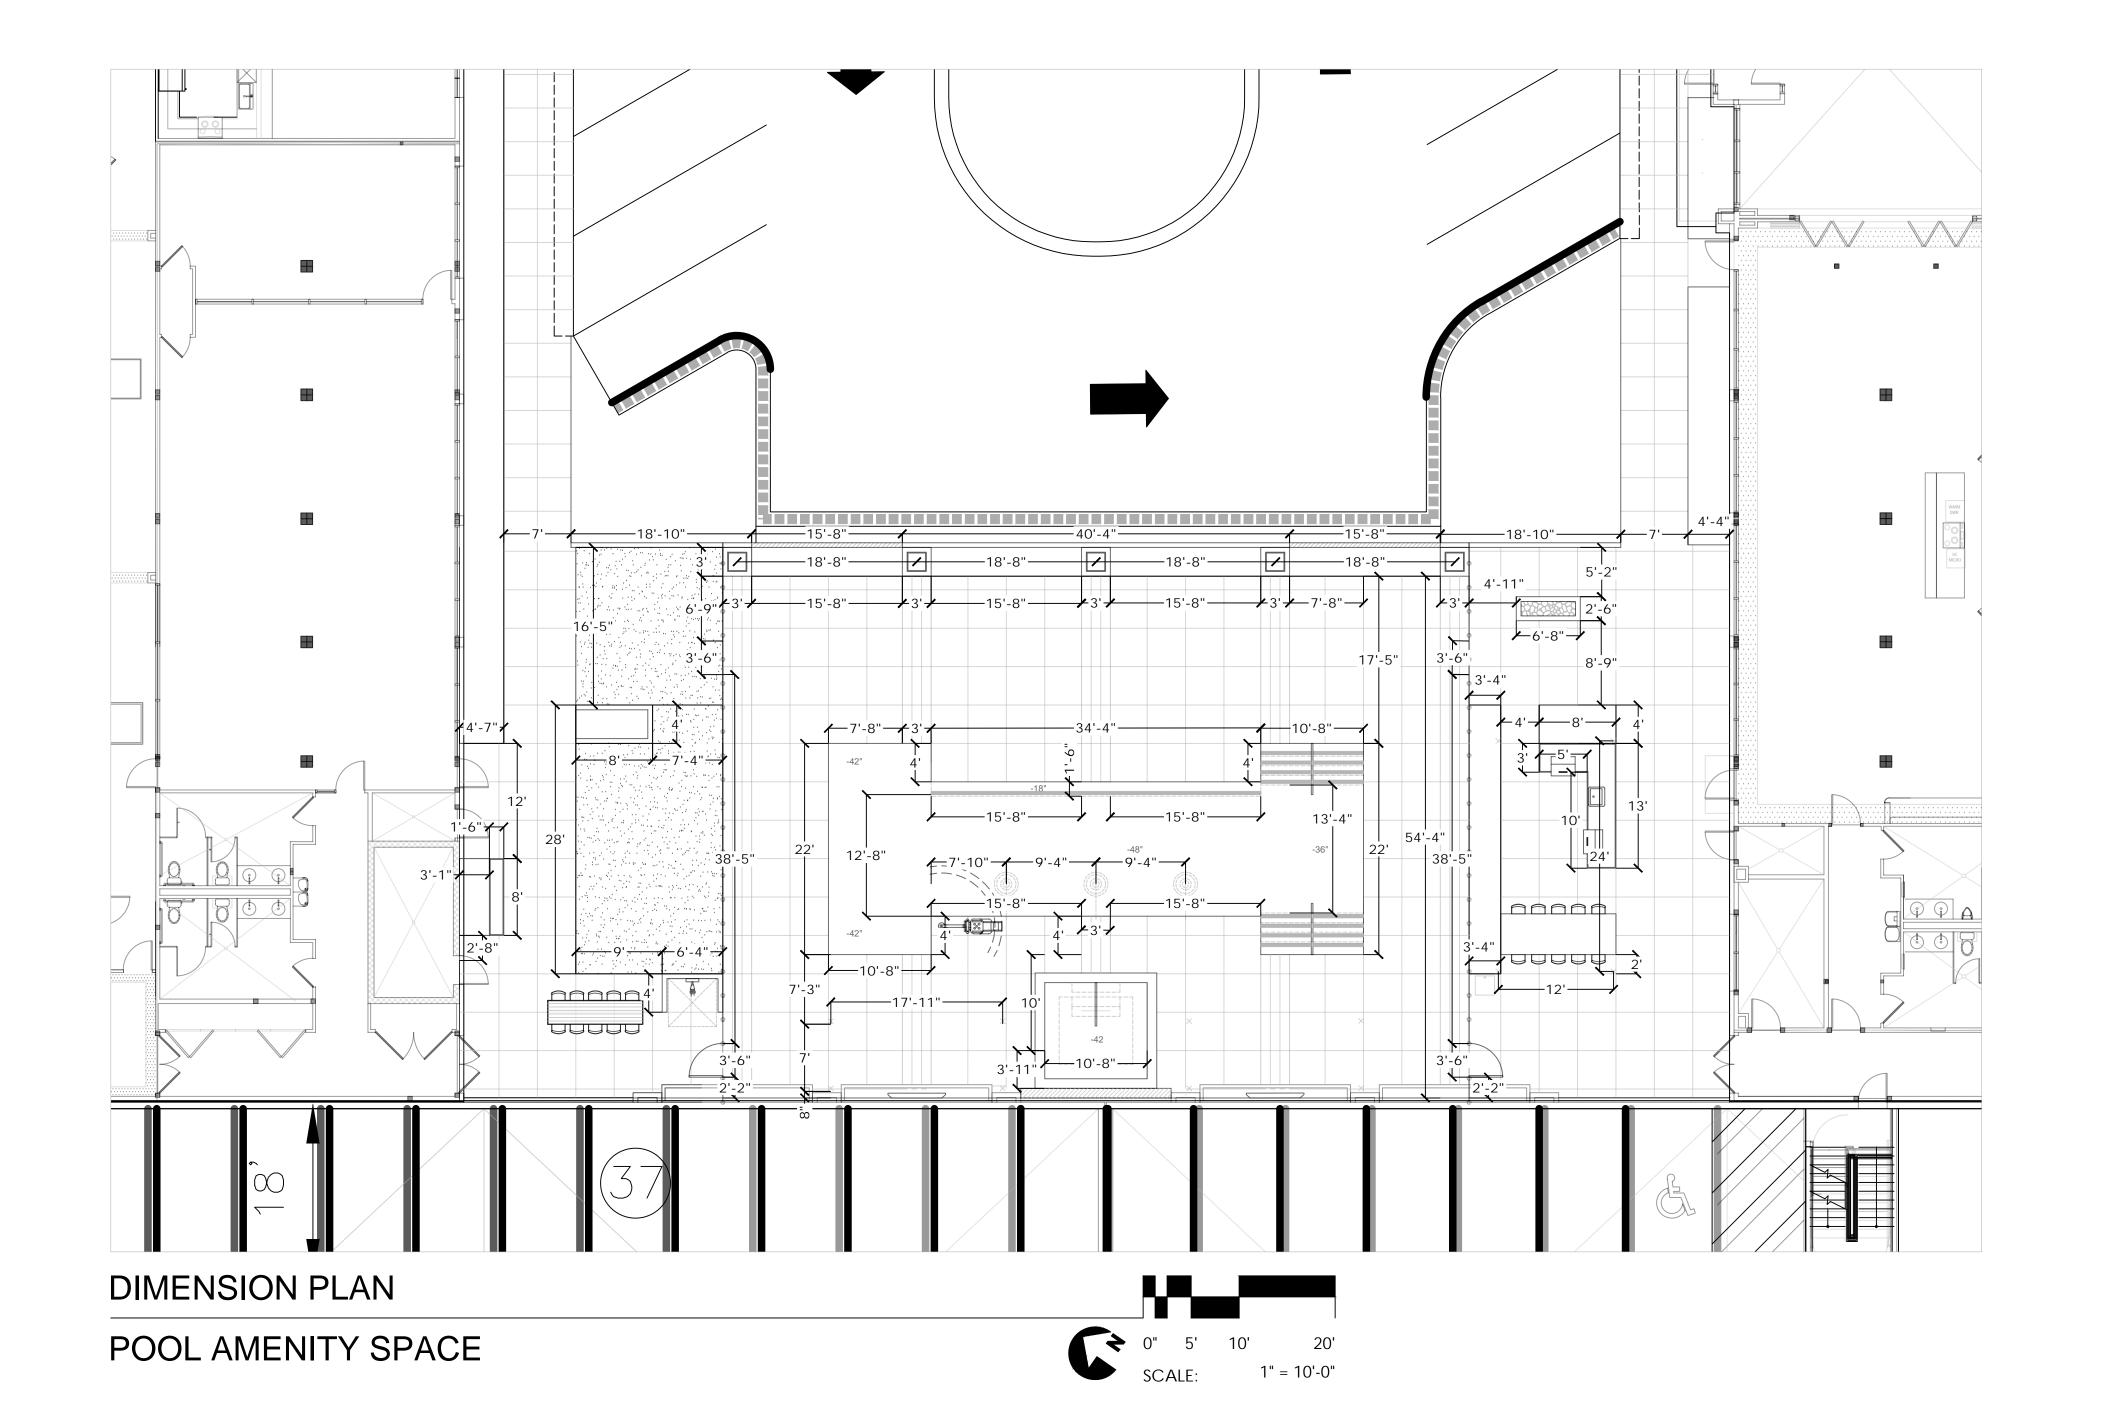

PLOT DATE:

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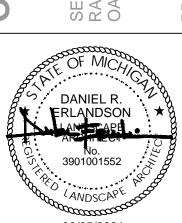
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SHEET TITLE

DIMENSION PLAN

SHEET NUMBER

SHEET INUIVIDER

L3.03

1" = 10'-0"

DESIGNED BY: DRAWN BY:

PLOT DATE:

SPENCER J. OKESON S.J.O. & I.K. DANIEL R. ERLANDSON 06/25/2021

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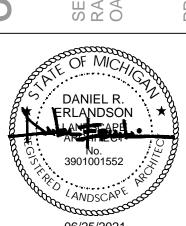
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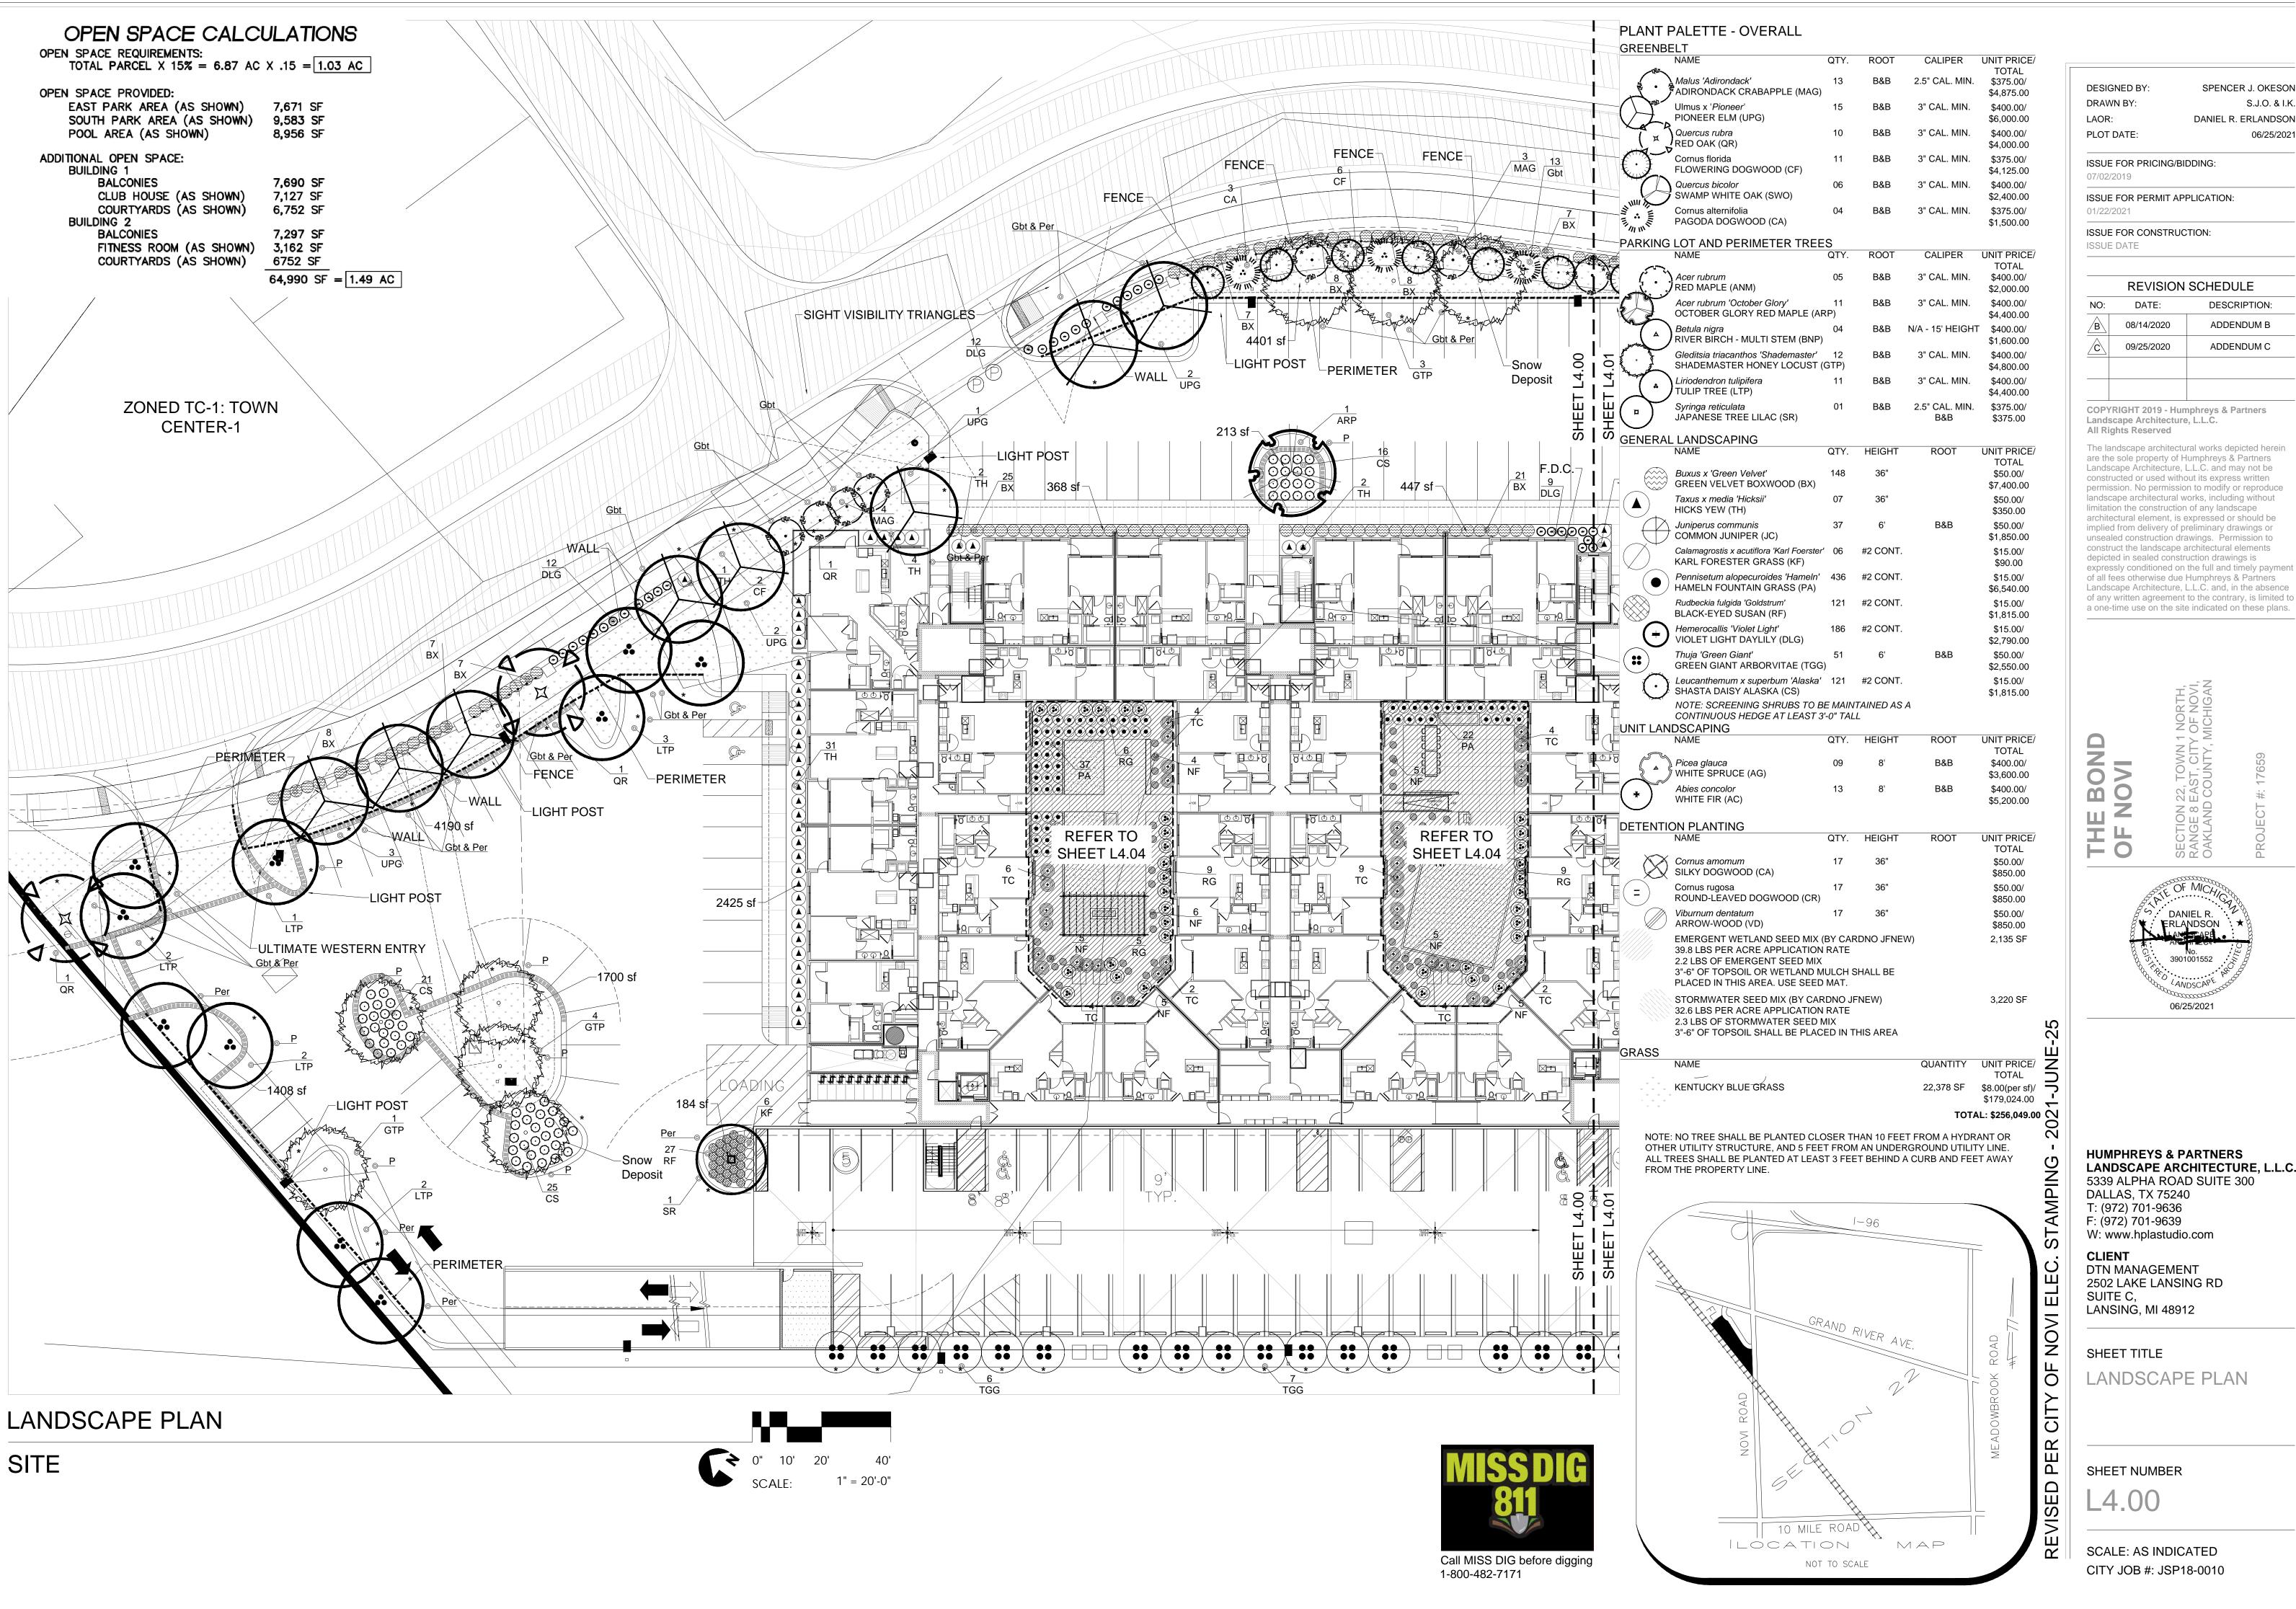
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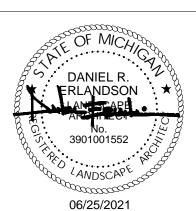
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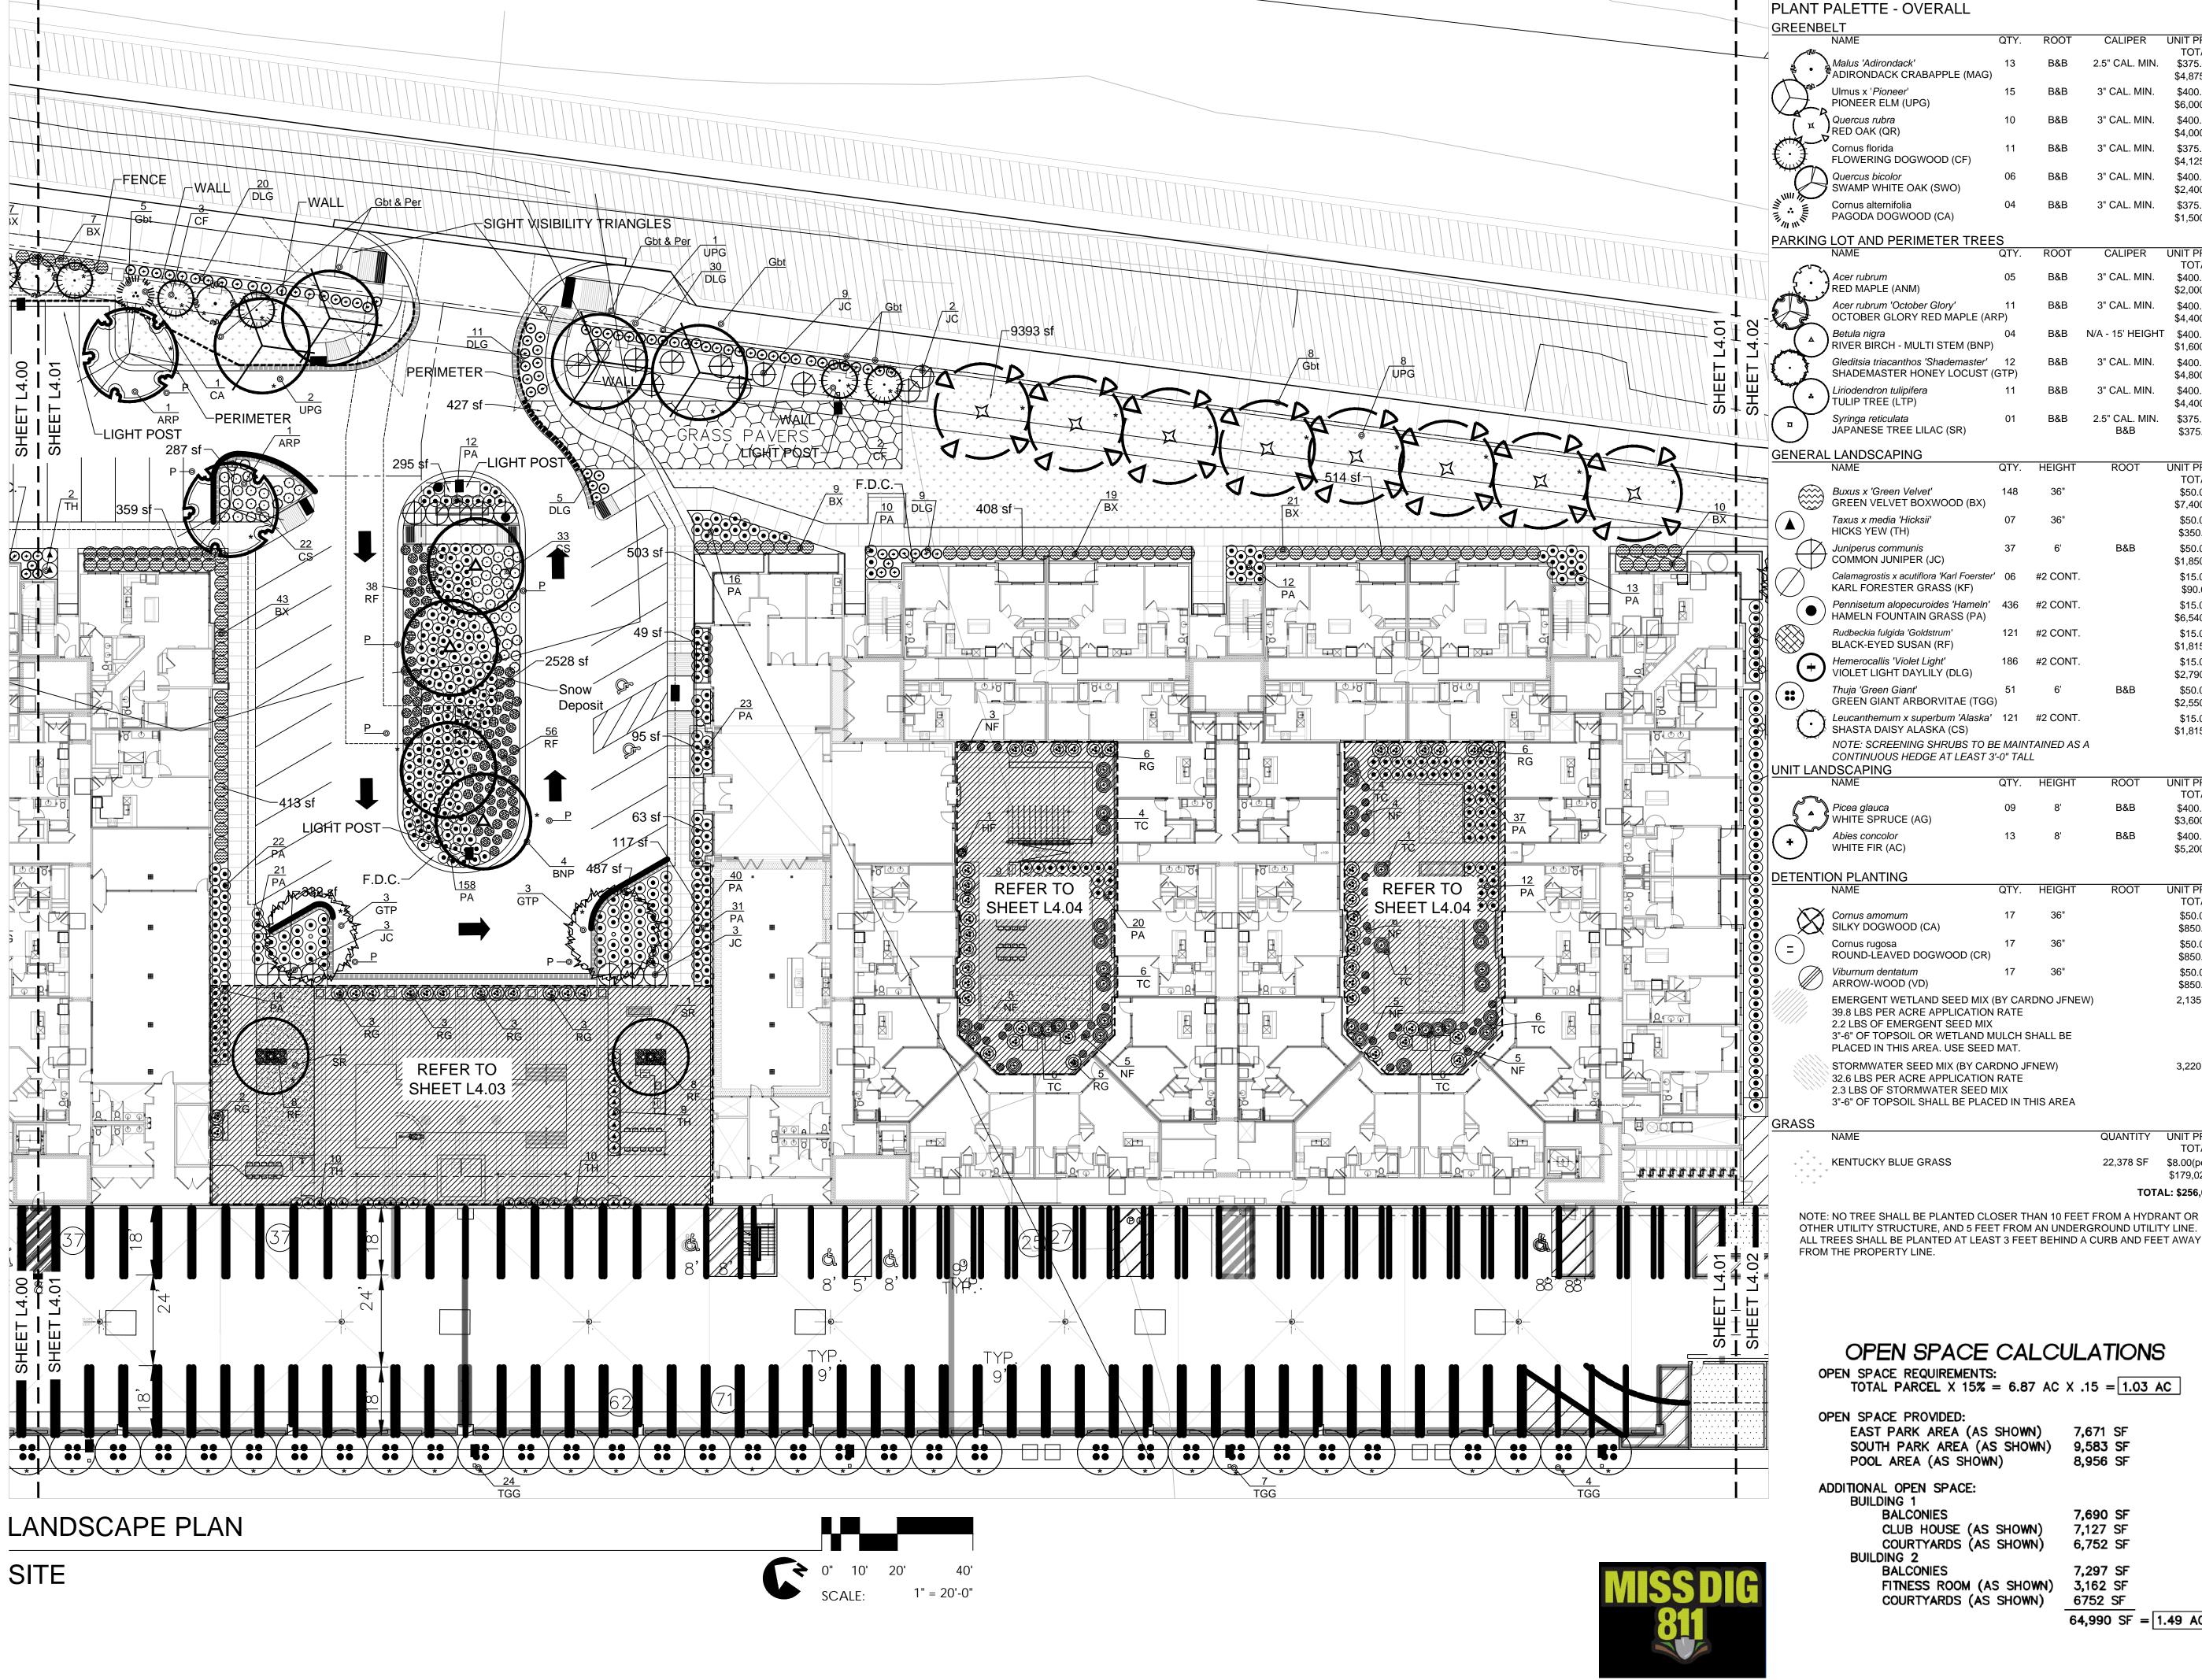


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CLIENT DTN MANAGEMENT 2502 LAKE LANSING RD SUITE C, LANSING, MI 48912

LANDSCAPE PLAN

SHEET NUMBER



PLANT PALETTE - OVERALL

CALIPER UNIT PRICE/ ROOT TOTAL B&B 2.5" CAL. MIN. Malus 'Adirondack' \$375.00/ 🛱 ADIRONDACK CRABAPPLE (MAG) \$4,875.00 Ulmus x 'Pioneer' B&B 3" CAL. MIN. \$400.00/ PIONEER ELM (UPG) \$6,000.00 B&B 3" CAL. MIN. \$400.00/ Quercus rubra RED OAK (QR) \$4,000.00 Cornus florida B&B 3" CAL. MIN. \$375.00/ FLOWERING DOGWOOD (CF) \$4,125.00 Quercus bicolor B&B 3" CAL. MIN. \$400.00/ SWAMP WHITE OAK (SWO) \$2,400.00 Cornus alternifolia B&B 3" CAL. MIN. \$375.00/ PAGODA DOGWOOD (CA) \$1,500.00 PARKING LOT AND PERIMETER TREES

CALIPER UNIT PRICE/ TOTAL Acer rubrum B&B 3" CAL. MIN. \$400.00/ RED MAPLE (ANM) \$2,000.00 Acer rubrum 'October Glory' B&B 3" CAL. MIN. \$400.00/ OCTOBER GLORY RED MAPLE (ARP) \$4,400.00 B&B N/A - 15' HEIGHT \$400.00/ Betula nigra \$1,600.00 3" CAL. MIN. \$400.00/ Gleditsia triacanthos 'Shademaster' 12 B&B SHADEMASTER HONEY LOCUST (GTP) \$4,800.00 Liriodendron tulipifera B&B 3" CAL. MIN. \$400.00/ TULIP TREE (LTP) \$4,400.00 Syringa reticulata B&B 2.5" CAL. MIN. \$375.00/ JAPANESE TREE LILAC (SR) \$375.00 GENERAL LANDSCAPING

QTY. HEIGHT ROOT UNIT PRICE/ TOTAL Buxus x 'Green Velvet'
GREEN VELVET BOXWOOD (BX) \$50.00/ \$7,400.00 \$50.00/ Taxus x media 'Hicksii' HICKS YEW (TH) \$350.00 \$50.00/ \ Juniperus communis COMMON JUNIPER (JC) \$1,850.00 Calamagrostis x acutiflora 'Karl Foerster' 06 #2 CONT. \$15.00/ KARL FORESTER GRASS (KF) \$90.00 Pennisetum alopecuroides 'Hameln' 436 #2 CONT. \$15.00/ HAMELN FOUNTAIN GRASS (PA) \$6,540.00 Rudbeckia fulgida 'Goldstrum' 121 #2 CONT. \$15.00/ BLACK-EYED SUSAN (RF) \$1,815.00 Hemerocallis 'Violet Light' 186 #2 CONT. \$15.00/ VIOLET LIGHT DAYLILY (DLG) \$2,790.00 Thuja 'Green Giant' \$50.00/ GREEN GIANT ARBORVITAE (TGG) \$2,550.00 Leucanthemum x superbum 'Alaska' 121 #2 CONT. \$15.00/ SHASTA DAISY ALASKA (CS) \$1,815.00 NOTE: SCREENING SHRUBS TO BE MAINTAINED AS A

₹.	JUNIT LANDSCAPING				
$\stackrel{\checkmark}{\nearrow}$	NAME	QTY.	HEIGHT	ROOT	UNIT PRICE TOTAL
$\frac{3}{3}$	Picea glauca WHITE SPRUCE (AG)	09	8'	B&B	\$400.00/ \$3,600.00
3	Abies concolor WHITE FIR (AC)	13	8'	B&B	\$400.00/ \$5,200.00
3	DETENTION PLANTING				
$\frac{3}{2}$	NAME	QTY.	HEIGHT	ROOT	UNIT PRICE TOTAL
\forall	Cornus amomum SILKY DOGWOOD (CA)	17	36"		\$50.00/ \$850.00
$\frac{1}{2}$	Cornus rugosa	17	36"		\$50.00/

	JIN I LANTINO				
	NAME	QTY.	HEIGHT	ROOT	UNIT PRICE TOTAL
	Cornus amomum SILKY DOGWOOD (CA)	17	36"		\$50.00/ \$850.00
=	Cornus rugosa ROUND-LEAVED DOGWOOD (CR)	17	36"		\$50.00/ \$850.00
	Viburnum dentatum ARROW-WOOD (VD)	17	36"		\$50.00/ \$850.00
	EMERGENT WETLAND SEED MIX (39.8 LBS PER ACRE APPLICATION 2.2 LBS OF EMERGENT SEED MIX 3"-6" OF TOPSOIL OR WETLAND M PLACED IN THIS AREA. USE SEED	RATE	,		2,135 SF
	STORMWATER SEED MIX (BY CAR 32.6 LBS PER ACRE APPLICATION 2.3 LBS OF STORMWATER SEED N 3"-6" OF TOPSOIL SHALL BE PLAC	RATE MIX	,		3,220 SF

KENTUCKY BLUE GRASS \$8.00(per sf)/ \$179,024.00 TOTAL: \$256,049.00 🚫

OPEN SPACE CALCULATIONS

OPEN SPACE REQUIREMENTS: TOTAL PARCEL X 15% = 6.87 AC X .15 = 1.03 AC

OPEN SPACE PROVIDED: EAST PARK AREA (AS SHOWN) 7,671 SF SOUTH PARK AREA (AS SHOWN) 9,583 SF POOL AREA (AS SHOWN) 8,956 SF

ADDITIONAL OPEN SPACE: **BUILDING 1** BALCONIES

Call MISS DIG before digging

1-800-482-7171

7,690 SF CLUB HOUSE (AS SHOWN) 7,127 SF COURTYARDS (AS SHOWN) 6,752 SF BUILDING 2 **BALCONIES** 7,297 SF FITNESS ROOM (AS SHOWN) 3,162 SF COURTYARDS (AS SHOWN)

6752 SF 64,990 SF = 1.49 AC DESIGNED BY: SPENCER J. OKESON DRAWN BY: S.J.O. & I.K. LAOR: DANIEL R. ERLANDSON PLOT DATE: 06/25/2021

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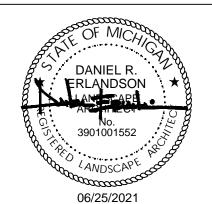
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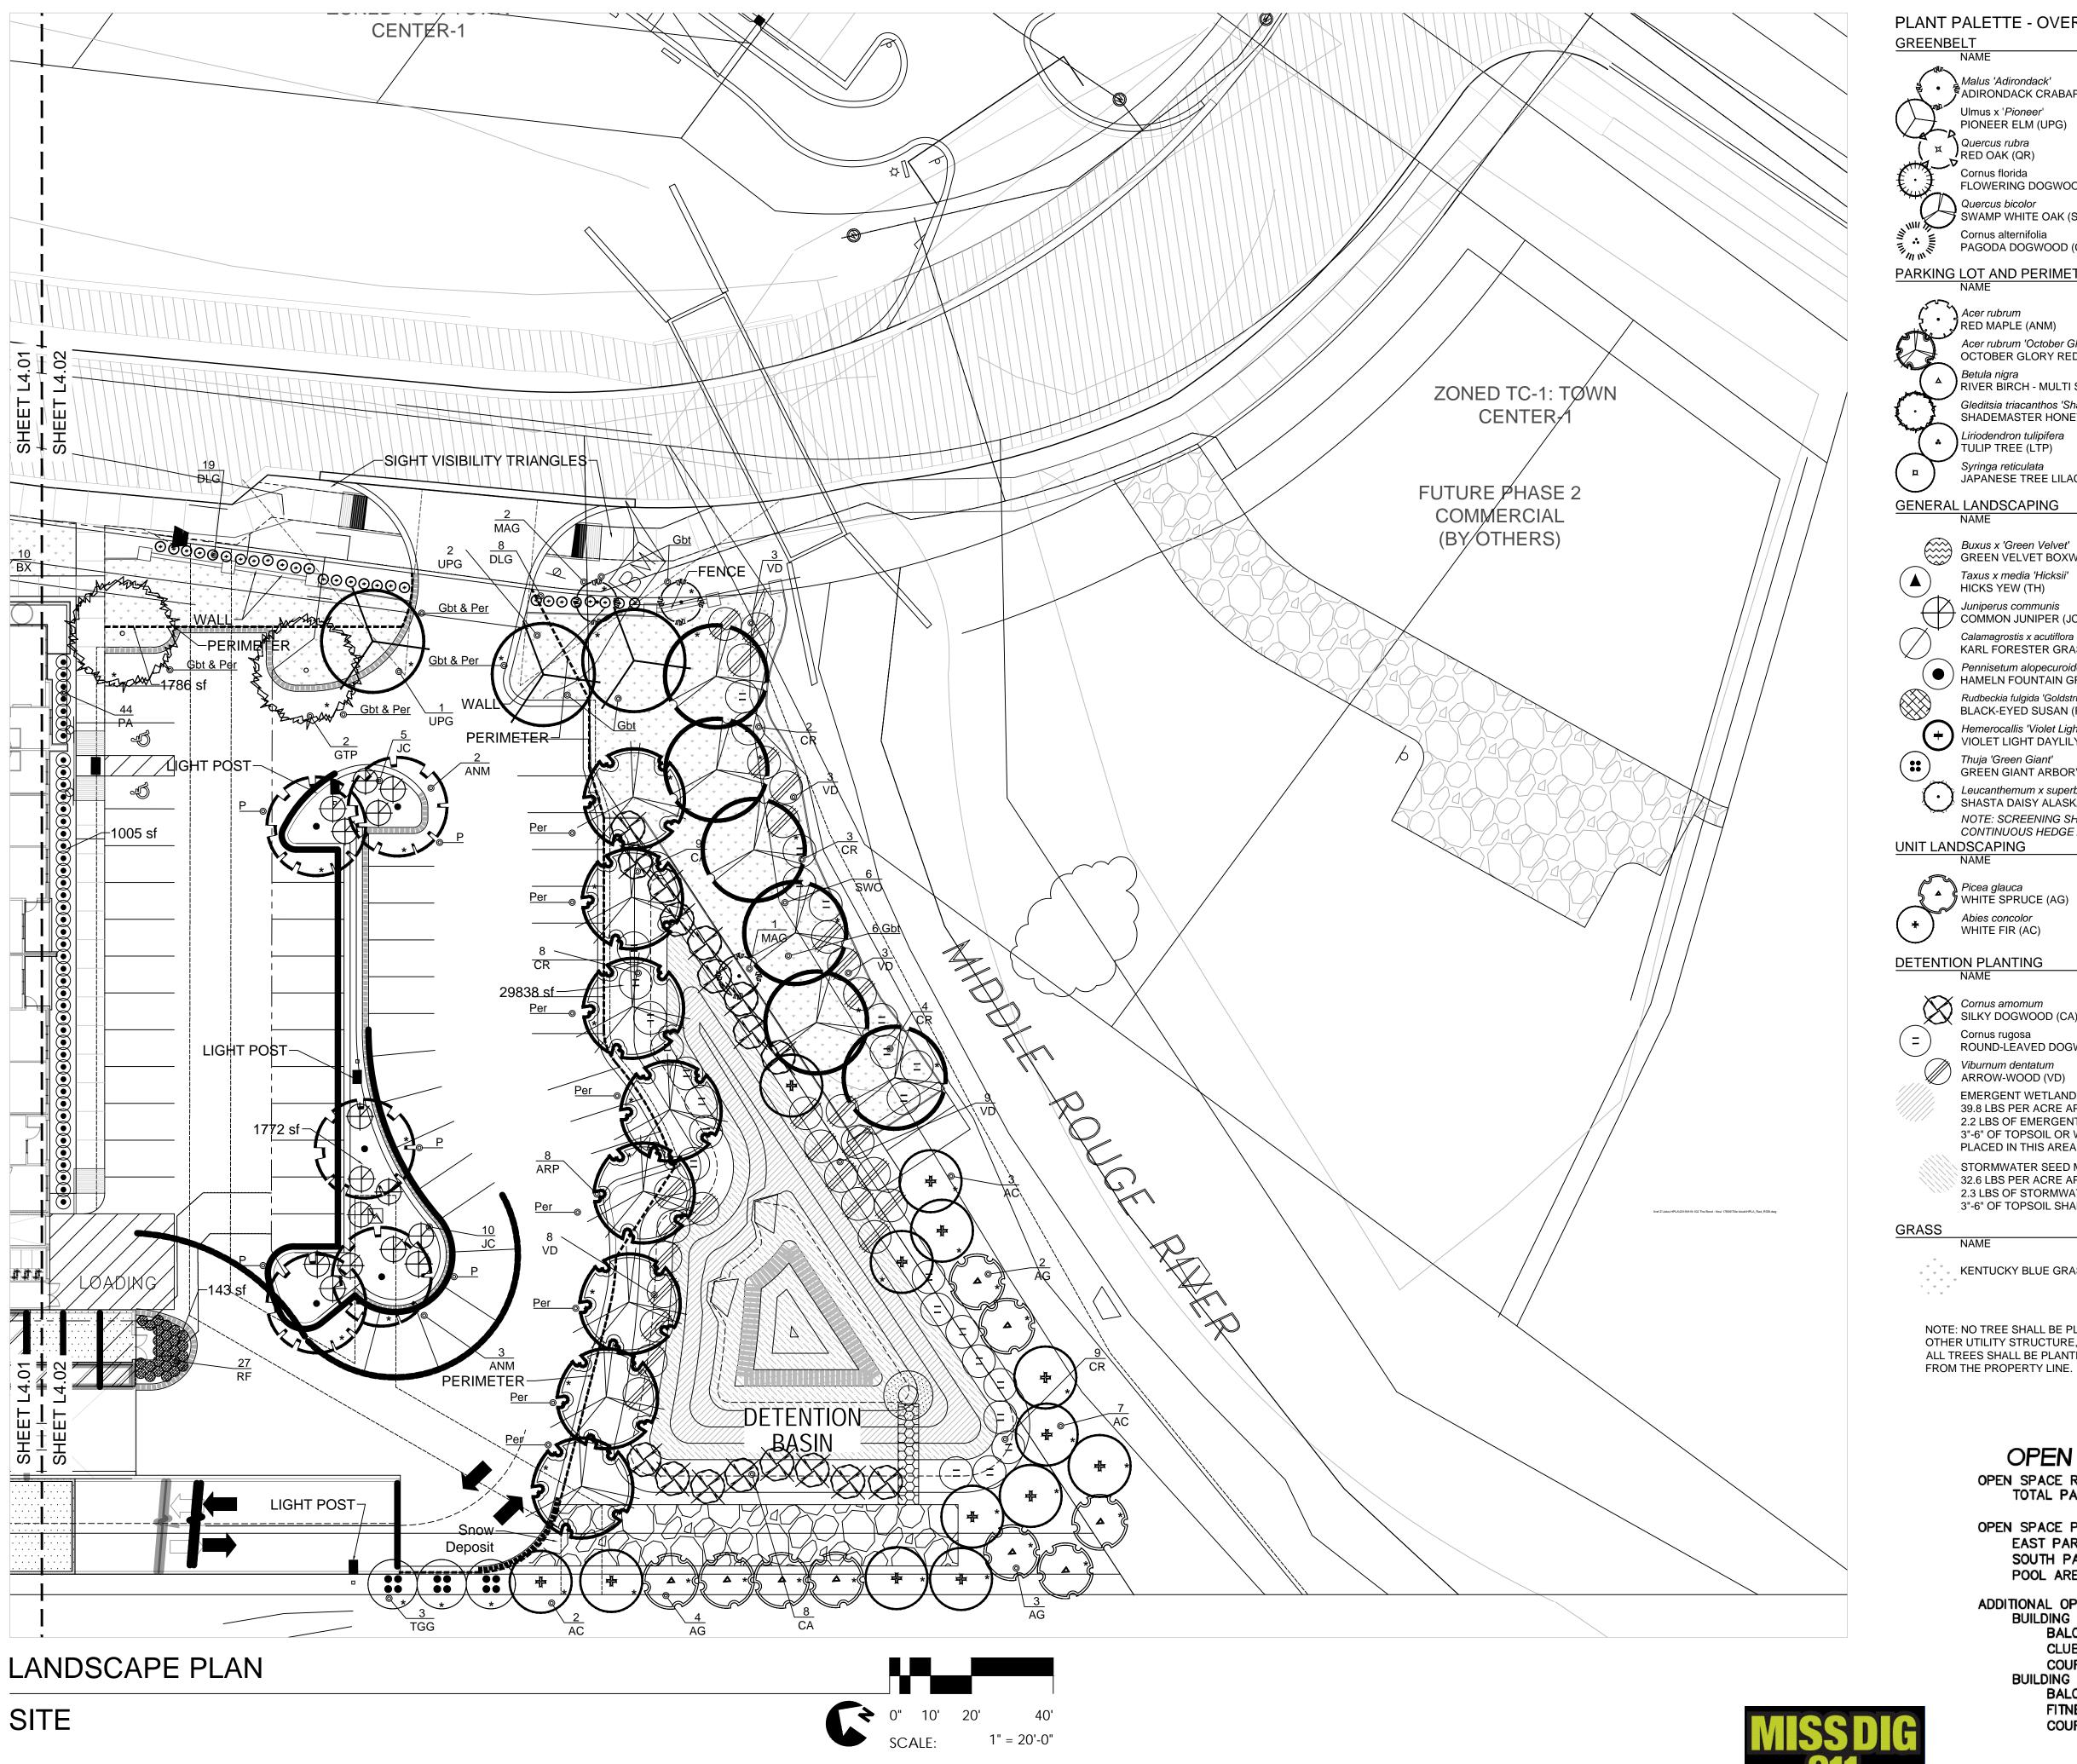
CLIENT DTN MANAGEMENT 2502 LAKE LANSING RD SUITE C, LANSING, MI 48912

SHEET TITLE

Q

LANDSCAPE PLAN

SHEET NUMBER



PLANT PALETTE - OVERALL

GREENBELT

NAME	QTY.	ROOT	CALIPER	UNIT PRICE/
Malus 'Adirondack' ADIRONDACK CRABAPPLE (MAG	13	B&B	2.5" CAL. MIN.	TOTAL \$375.00/ \$4,875.00
Ulmus x 'Pioneer' PIONEER ELM (UPG)	15	B&B	3" CAL. MIN.	\$400.00/ \$6,000.00
Quercus rubra RED OAK (QR)	10	B&B	3" CAL. MIN.	\$400.00/ \$4,000.00
Cornus florida FLOWERING DOGWOOD (CF)	11	B&B	3" CAL. MIN.	\$375.00/ \$4,125.00
Quercus bicolor SWAMP WHITE OAK (SWO)	06	B&B	3" CAL. MIN.	\$400.00/ \$2,400.00
Cornus alternifolia PAGODA DOGWOOD (CA)	04	B&B	3" CAL. MIN.	\$375.00/ \$1,500.00
DARKING LOT AND DEDIMETED TOE				

PARKING LOT AND PERIMETER TREES

						TOTA
	ζ· .)	Acer rubrum RED MAPLE (ANM)	05	B&B	3" CAL. MIN.	\$400.0 \$2,000.
%		Acer rubrum 'October Glory' OCTOBER GLORY RED MAPLE (AR	11 P)	B&B	3" CAL. MIN.	\$400.0 \$4,400.
~~1 Ma	$\left(\begin{array}{c} A \end{array}\right)$	Betula nigra RIVER BIRCH - MULTI STEM (BNP)	04	B&B	N/A - 15' HEIGHT	\$400.0 \$1,600.
	. 1	Gleditsia triacanthos 'Shademaster' SHADEMASTER HONEY LOCUST (0	12 GTP)	B&B	3" CAL. MIN.	\$400.0 \$4,800.
<u> </u>	(Liriodendron tulipifera TULIP TREE (LTP)	11	B&B	3" CAL. MIN.	\$400.0 \$4,400.
(n	Syringa reticulata JAPANESE TREE LILAC (SR)	01	B&B	2.5" CAL. MIN. B&B	\$375.0 \$375.0

GENERAL LANDSCAPING

	NAME	QTY.	HEIGHT	ROOT	UNIT PRI
	Buxus x 'Green Velvet' GREEN VELVET BOXWOOD (BX)	148	36"		TOTAL \$50.00/ \$7,400.0
	Taxus x media 'Hicksii' HICKS YEW (TH)	07	36"		\$50.00/ \$350.00
	Juniperus communis COMMON JUNIPER (JC)	37	6'	B&B	\$50.00 <i>/</i> \$1,850.0
	Calamagrostis x acutiflora 'Karl Foerster' KARL FORESTER GRASS (KF)	06	#2 CONT.		\$15.00/ \$90.00
	Pennisetum alopecuroides 'Hameln' HAMELN FOUNTAIN GRASS (PA)	436	#2 CONT.		\$15.00/ \$6,540.0
	Rudbeckia fulgida 'Goldstrum' BLACK-EYED SUSAN (RF)	121	#2 CONT.		\$15.00 <i>/</i> \$1,815.0
+	Hemerocallis 'Violet Light' VIOLET LIGHT DAYLILY (DLG)	186	#2 CONT.		\$15.00/ \$2,790.0
	Thuja 'Green Giant' GREEN GIANT ARBORVITAE (TGG)	51	6'	B&B	\$50.00/ \$2,550.0
	Leucanthemum x superbum 'Alaska' SHASTA DAISY ALASKA (CS)	121	#2 CONT.		\$15.00 <i>/</i> \$1,815.0
,,,	NOTE: SCREENING SHRUBS TO BE	E MAIN	TAINED AS A		

NOTE: SCREENING SHRUBS TO BE MAINTAINED AS A CONTINUOUS HEDGE AT LEAST 3'-0" TALL

UNIT LANDSCAPING				
NAME	QTY.	HEIGHT	ROOT	UNIT PRIC
				TOTAL
Picea glauca WHITE SPRUCE (AG)	09	8'	B&B	\$400.00 \$3,600.0
Abies concolor WHITE FIR (AC)	13	8'	B&B	\$400.00 \$5,200.0

DETENTION	ON PLANTING				
	NAME	QTY.	HEIGHT	ROOT	UNIT PRIC
	Cornus amomum SILKY DOGWOOD (CA)	17	36"		\$50.00/ \$850.00
=	Cornus rugosa ROUND-LEAVED DOGWOOD (CR)	17	36"		\$50.00/ \$850.00
	Viburnum dentatum ARROW-WOOD (VD)	17	36"		\$50.00/ \$850.00
	EMERGENT WETLAND SEED MIX (39.8 LBS PER ACRE APPLICATION 2.2 LBS OF EMERGENT SEED MIX 3"-6" OF TOPSOIL OR WETLAND M PLACED IN THIS AREA. USE SEED	RATE ULCH S	,		2,135 SI

32.6 LBS PER ACRE APPLICATION RATE 2.3 LBS OF STORMWATER SEED MIX 3"-6" OF TOPSOIL SHALL BE PLACED IN THIS AREA

STORMWATER SEED MIX (BY CARDNO JFNEW)

NAME	QUANTITY	UNIT PRIC
Ψ		TOTAL
** KENTUCKY BLUE GRASS	22,378 SF	\$8.00(per s
* * * *		\$179,024.0

NOTE: NO TREE SHALL BE PLANTED CLOSER THAN 10 FEET FROM A HYDRANT OR OTHER UTILITY STRUCTURE, AND 5 FEET FROM AN UNDERGROUND UTILITY LINE. ALL TREES SHALL BE PLANTED AT LEAST 3 FEET BEHIND A CURB AND FEET AWAY

OPEN SPACE CALCULATIONS

OPEN SPACE REQUIREMENTS: TOTAL PARCEL X 15% = 6.87 AC X .15 = 1.03 AC

OPEN SPACE PROVIDED: EAST PARK AREA (AS SHOWN)
SOUTH PARK AREA (AS SHOWN) 7,671 SF 9,583 SF POOL AREA (AS SHOWN) 8,956 SF

ADDITIONAL OPEN SPACE: **BUILDING 1** BALCONIES

CLUB HOUSE (AS SHOWN)
COURTYARDS (AS SHOWN) BUILDING 2 **BALCONIES** FITNESS ROOM (AS SHOWN)
COURTYARDS (AS SHOWN)

6752 SF 64,990 SF = 1.49 AC ☐ REVISE

7,690 SF

7,127 SF

6,752 SF

7,297 SF

3,162 SF

3,220 SF

TOTAL: \$256,049.00

2021

NOV

DESIGNED BY: SPENCER J. OKESON DRAWN BY: S.J.O. & I.K. DANIEL R. ERLANDSON LAOR: PLOT DATE: 06/25/2021 ISSUE FOR PRICING/BIDDING:

ISSUE FOR PERMIT APPLICATION:

ISSUE DATE

CALIPER UNIT PRICE/

ISSUE FOR CONSTRUCTION:

REVISION SCHEDULE

	KEVISION	SCHEDULE
10:	DATE:	DESCRIPTION:
B	08/14/2020	ADDENDUM B
\bigcirc	09/25/2020	ADDENDUM C


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CLIENT DTN MANAGEMENT 2502 LAKE LANSING RD SUITE C, LANSING, MI 48912

SHEET TITLE


LANDSCAPE PLAN

SHEET NUMBER

SCALE: AS INDICATED CITY JOB #: JSP18-0010

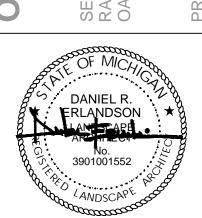Call MISS DIG before digging

1-800-482-7171

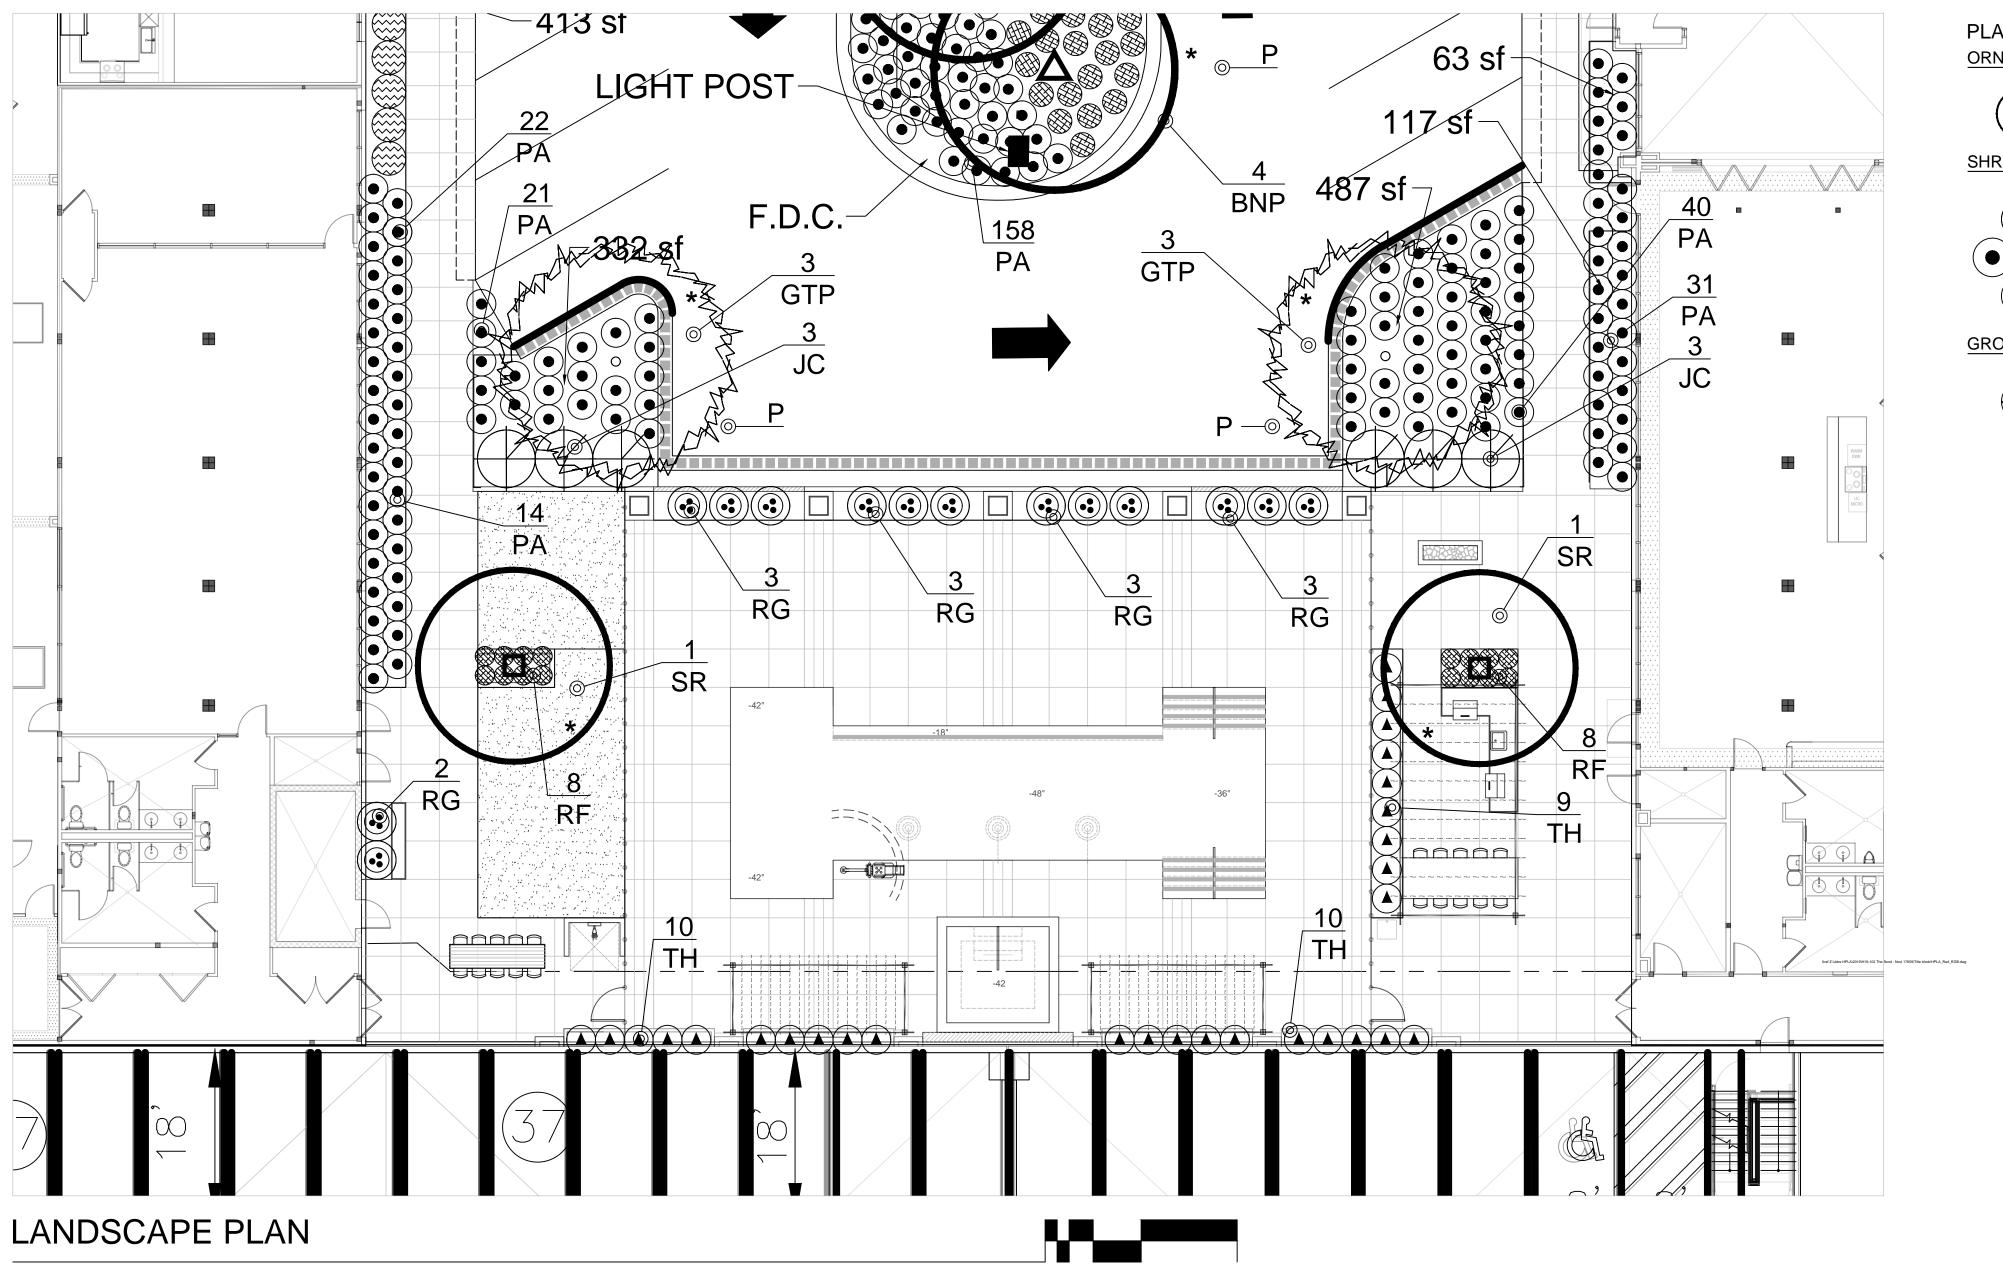

1" = 10'-0"

POOL AMENITY SPACE

PLANT PALETTE - POOL COURTYARD

ORNAME	NTAL TREES				
	NAME	QTY.	SIZE	CALIPER	UNIT PRICE/
п	Syringa reticulata JAPANESE TREE LILAC (SR)	02	36" BOX	2.5" CAL. MIN. B&B	TOTAL \$375.00/ \$800.00
SHRUBS					
	NAME	QTY.	SIZE	HEIGHT	UNIT PRICE/ TOTAL
	Taxus canadensis CANADA YEW (RG)	14	#5 CONT.	MIN. 30" HT.	\$50.00/ \$700.00
	Pennisetum alopecuroides 'Hameln' HAMELN FOUNTAIN GRASS (PA)	14	#2 CONT.		\$15.00/ \$210.00
	Taxus x media 'Hicksii' HICKS YEW (TH)	29	36"		\$50.00/ \$1,450.00
GROUND	COVERS				
	NAME	QTY.	SIZE	HEIGHT	UNIT PRICE/ TOTAL
	Rudbeckia fulgida 'Goldstrum'	16	#2 CONT.		\$15.00/

NOTE: NO TREE SHALL BE PLANTED CLOSER THAN 10 FEET FROM A HYDRANT OR OTHER UTILITY STRUCTURE, AND 5 FEET FROM AN UNDERGROUND UTILITY LINE. ALL TREES SHALL BE PLANTED AT LEAST 3 FEET BEHIND A CURB AND FEET AWAY FROM THE PROPERTY LINE.

SHEET NUMBER

DESIGNED BY:

DRAWN BY:

PLOT DATE:

ISSUE DATE

NO:

ISSUE FOR PRICING/BIDDING:

ISSUE FOR CONSTRUCTION:

DATE:

08/14/2020

09/25/2020

Landscape Architecture, L.L.C.

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CLIENT

SUITE C,

SHEET TITLE

W: www.hplastudio.com

DTN MANAGEMENT 2502 LAKE LANSING RD

LANDSCAPE PLAN

LANSING, MI 48912

LANDSCAPE ARCHITECTURE, L.L.C. 5339 ALPHA ROAD SUITE 300

SPENCER J. OKESON

DANIEL R. ERLANDSON

DESCRIPTION:

ADDENDUM B

ADDENDUM C

S.J.O. & I.K.

06/25/2021


SCALE: AS INDICATED CITY JOB #: JSP18-0010


REVISED

2021-JUNE-25

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PLANT PALETTE - WEST COURTYARDS SHRUBS

NAME	QTY.	SIZE	HEIGHT	UNIT PRIC
				TOTAL
llex glabra	37	#5 CONT.	MIN. 30" HT.	\$50.00/
INKBERRY (RG)				\$1,850.0
Taxus canadensis	35	#5 CONT.	MIN. 30" HT.	\$15.00/
CANADA YEW (TC)				\$525.00
	Ilex glabra INKBERRY (RG) Taxus canadensis	Ilex glabra 37 INKBERRY (RG) Taxus canadensis 35	Ilex glabra 37 #5 CONT. INKBERRY (RG) Taxus canadensis 35 #5 CONT.	Ilex glabra 37 #5 CONT. MIN. 30" HT. INKBERRY (RG) Taxus canadensis 35 #5 CONT. MIN. 30" HT.

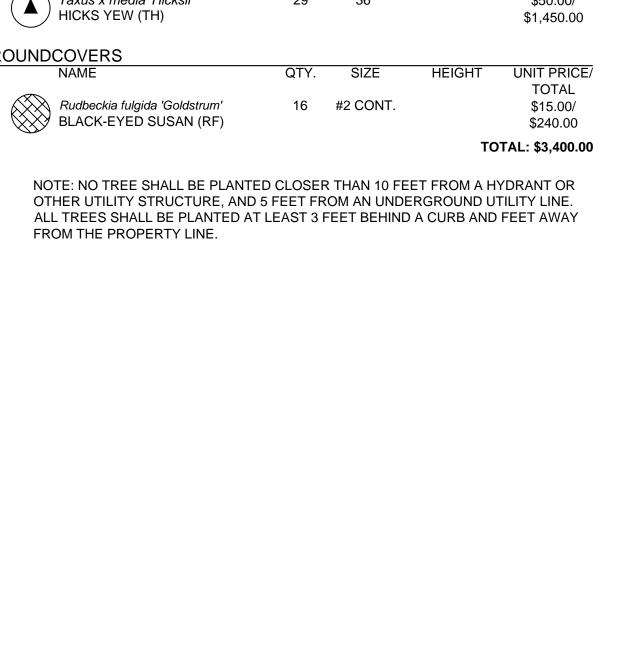ACCENTS

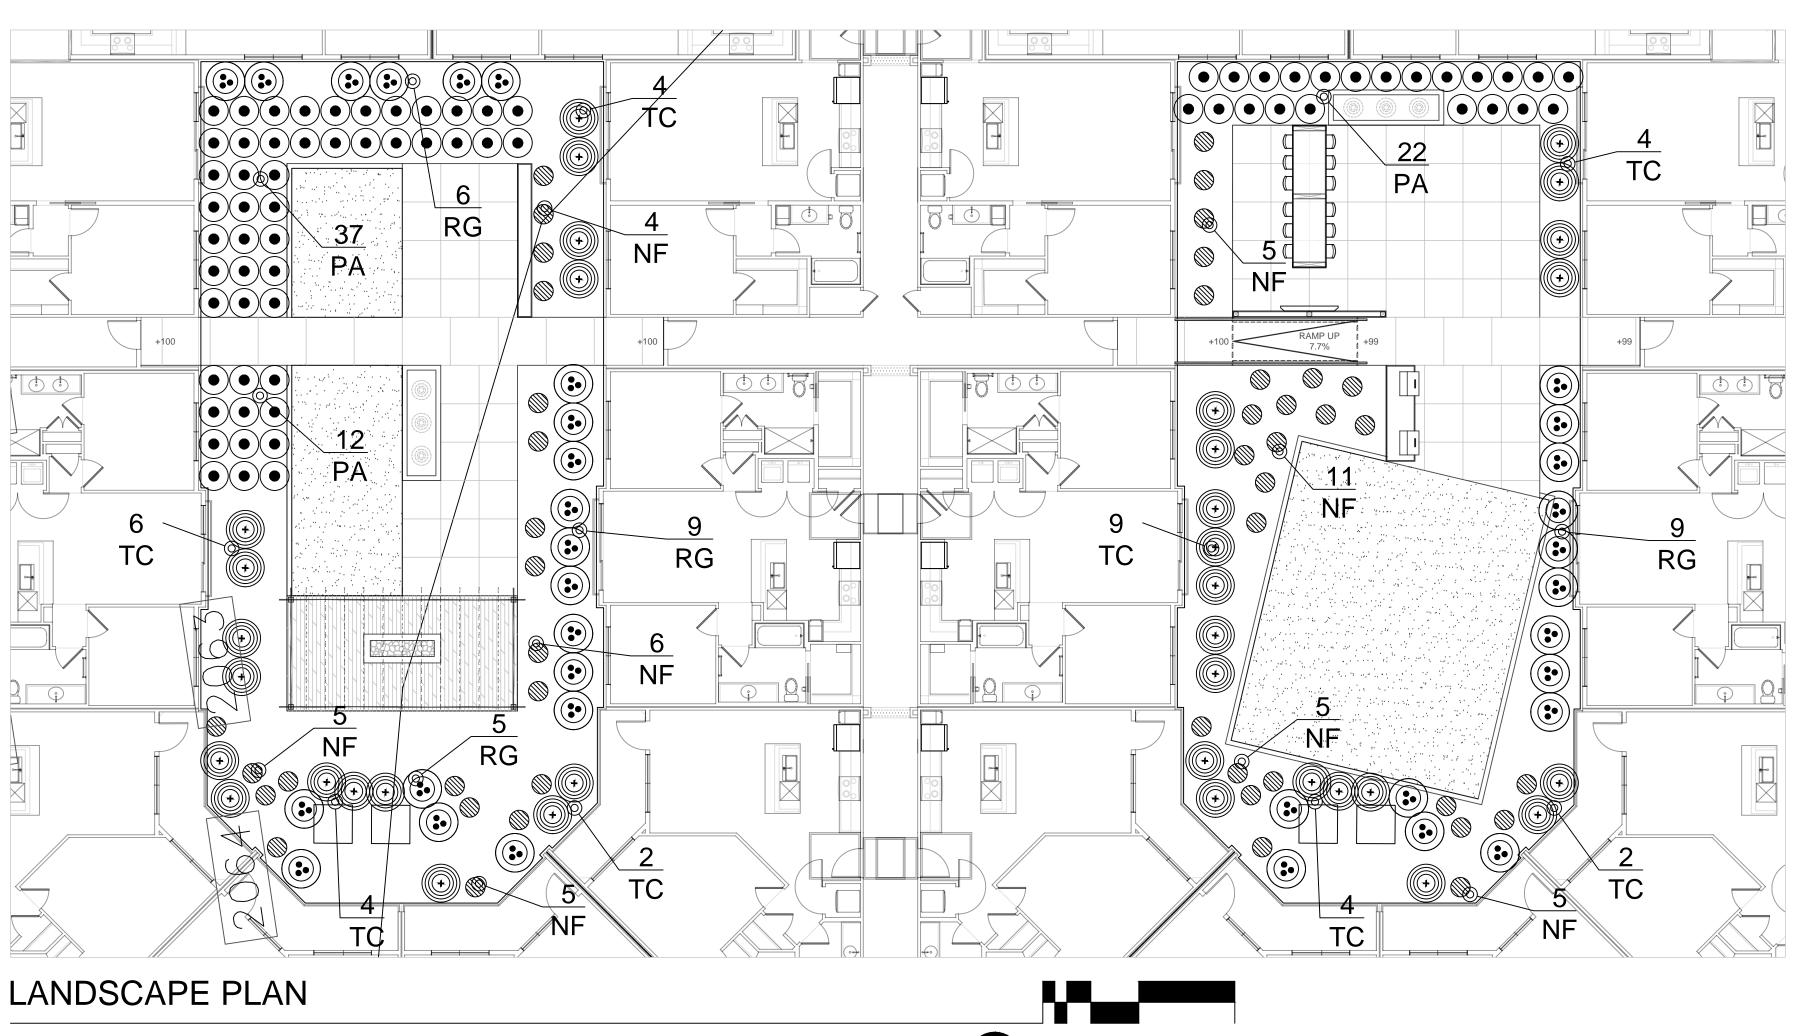UNIT PRICE/ TOTAL Nepeta x faassenii 'Walker's Low' 46 #3 CONT.
WALKER'S LOW CATMINT (NF) \$15.00/ \$690.00 Pennisetum alopecuroides 'Hameln' 71 #2 CONT. \$15.00/ HAMELN FOUNTAIN GRASS (PA) \$1,065.00

TOTAL: \$4,130.00

NOTE: NO TREE SHALL BE PLANTED CLOSER THAN 10 FEET FROM A HYDRANT OR OTHER UTILITY STRUCTURE, AND 5 FEET FROM AN UNDERGROUND UTILITY LINE. ALL TREES SHALL BE PLANTED AT LEAST 3 FEET BEHIND A CURB AND FEET AWAY FROM THE PROPERTY LINE.

PLANT PALETTE - EAST COURTYARDS

<u> </u>					
_	NAME	QTY.	SIZE	HEIGHT	UNIT PRICE/ TOTAL
	llex glabra INKBERRY (RG)	40	#5 CONT.	MIN. 30" HT.	\$50.00/ \$2,000.00
(+)	Taxus canadensis CANADA YEW (TC)	34	#5 CONT.	MIN. 30" HT.	\$15.00/ \$510.00
CCENT	S				
	NAME	QTY.	SIZE	HEIGHT	UNIT PRICE/ TOTAL
	Hosta 'Francee' FRANCEE HOSTA (HF)	01	#3 CONT.		\$15.00/ \$15.00
	Pennisetum alopecuroides 'Hameln' HAMELN FOUNTAIN GRASS (PA)	69	#2 CONT.		\$15.00/

Iris versicolor
BLUE FLAG IRIS (NF) 33 #3 CONT. \$15.00/ \$495.00 TOTAL: \$4,055.00

NOTE: NO TREE SHALL BE PLANTED CLOSER THAN 10 FEET FROM A HYDRANT OR OTHER UTILITY STRUCTURE, AND 5 FEET FROM AN UNDERGROUND UTILITY LINE. ALL TREES SHALL BE PLANTED AT LEAST 3 FEET BEHIND A CURB AND FEET AWAY FROM THE PROPERTY LINE.



DESIGNED BY: DRAWN BY: LAOR:

PLOT DATE:

ISSUE DATE

S.J.O. & I.K. DANIEL R. ERLANDSON 06/25/2021

SPENCER J. OKESON

ISSUE FOR PRICING/BIDDING:

ISSUE FOR PERMIT APPLICATION:

ISSUE FOR CONSTRUCTION:

REVISION SCHEDULE DATE:

NO: DESCRIPTION: ADDENDUM B 08/14/2020 ADDENDUM C 09/25/2020


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2021-JUNE-25

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06/25/2021

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CLIENT DTN MANAGEMENT 2502 LAKE LANSING RD SUITE C, LANSING, MI 48912

SHEET TITLE

LANDSCAPE PLAN

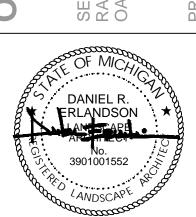SHEET NUMBER

SCALE: AS INDICATED CITY JOB #: JSP18-0010

LANDSCAPE PLAN EAST COURTYARDS

WEST COURTYARDS

NF

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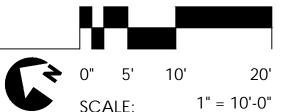
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TC

RG

TC

20 PA



1" = 10'-0"

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PA

+100

TC

9

RG

TC

TC

DECIDUOUS TREE PLANTING DETAIL


2-15-2016

GUY EVERGREEN TREES ABOVE 12' TREE SHALL BEAR SAME RELATION HEIGHT. STAKE EVERGREEN TREE TO FINISH GRADE AS IT BORE ORIGINALLY OR SLIGHTLY HIGHER BELOW 12' HEIGHT. THAN FINISH GRADE UP TO 6" STAKE TREES AT FIRST BRANCH ABOVE GRADE, IF DIRECTED BY USING 2"-3" WIDE BELT-LIKE LANDSCAPE ARCHITECT FOR HEAVY NYLON OR PLASTIC STRAPS. CLAY SOIL AREAS. ALLOW FOR SOME MINIMAL FLEXING OF THE TREE. DO NOT PRUNE TERMINAL LEADER. REMOVE AFTER ONE YEAR. PRUNE ONLY DEAD OR BROKEN BRANCHES. 2" X 2" HARDWOOD STAKES, MIN. REMOVE ALL TAGS, STRING, 36" ABOVE GROUND FOR UPRIGHT, PLASTICS ETC. 18" IF ANGLED. DRIVE STAKES A MIN. 18" INTO UNDISTURBED GROUND OUTSIDE ROOTBALL. PLANT TREE SO ROOT REMOVE AFTER ONE YEAR. FLARE IS AT OR ABOVE SURROUNDING GRADE. MULCH 3" DEPTH WITH SHREDDED -REMOVE ROOT BALL HARDWOOD BARK. NATURAL IN DIRT TO EXPOSE FLARE COLOR, LEAVE 3" CIRCLE OF BARE IF NECESSARY AND CUT SOIL AT BASE OF TREE TRUNK TO ANY GIRDLING ROOTS. EXPOSE ROOT FLARE. PLANTING MIXTURE: AMEND SOILS PER SITE CONDITIONS AND MOUND EARTH TO FORM SAUCER -REQUIREMENTS OF THE PLANT MATERIAL. REMOVE ALL NON-BIODEGRADABLE MATERIALS COMPLETELY FROM THE SCARIFY PLANTING PIT ROOTBALL. CUT AND REMOVE WIRE SIDES. RECOMPACT TREE PIT = $3 \times$ BASKET AND BURLAP FROM TOP BASE TO 4" DEPTH. ROOTBALL WIDTH HALF OF THE ROOTBALL.

EVERGREEN TREE PLANTING DETAIL

2-15-2016

2-15-2016

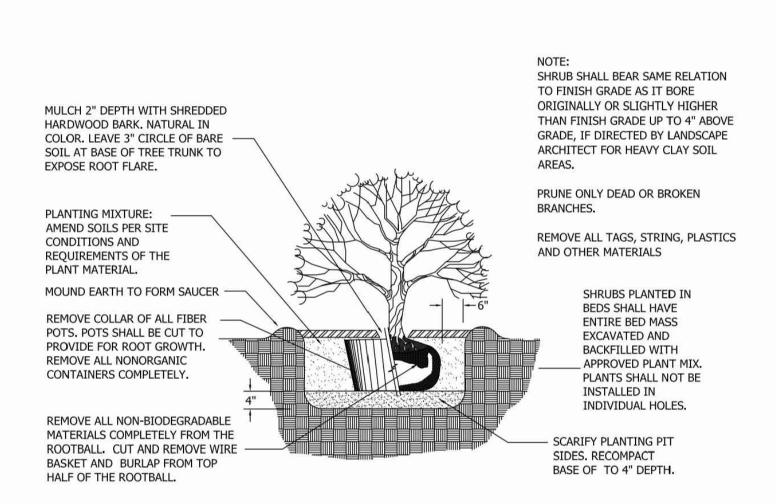

SHRUB PLANTING DETAIL NOT TO SCALE

ALSO ACCEPTABLE FINISHED GRADE PLANTING MIXTURE, AS SPECIFIED PERENNIAL PLANTING DETAIL


PLASTIC STRAPS.

1 1/2-2" SHREDDED BARK-

METAL EDGING (BETWEEN

BED AND LAWN) - DEEP CUT -


ORIENT STAKING/GUYING TO PREVAILING WINDS, EXCEPT ON SLOPES GREATER THAN 3:1 ORIENT TO SLOPE. USE SAME STAKING/GUYING ORIENTATION FOR ALL PLANTS WITHIN EACH GROUPING OR

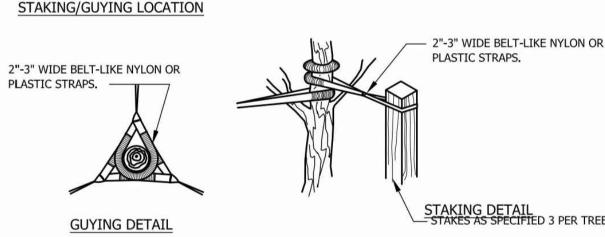

TREE STAKING DETAIL

2-15-2016

2-15-2016

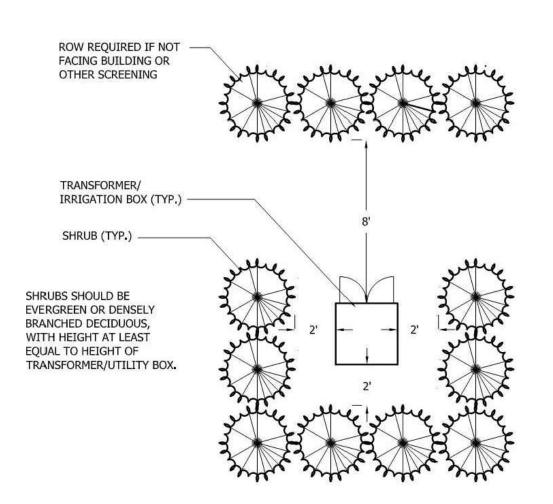

TRANSFORMER SCREENING DETAIL

2-15-2016

LANDSCAPE SUMMARY - MULTI-FAMILY

Existing Zoning TC-1 GREENBELT ("Gbt") Street Frontage Adjacent to Pkg. 230' Trees Required 10 Trees (230' / 25') Trees Provided 17 Trees Ornamental Trees Required 16 Trees (230' / 15') Ornamental Trees Provided 16 Trees

Street Frontage not Adjacent to Pkg. 850' 159' Less Drive Openings Net Frontage 691' 23 Trees (691' / 30') Trees Required Trees Provided 24 Trees 35 Trees (691' / 20') Ornamental Trees Required

09 Trees Ornamental Trees Provided PARKING LOT LANDSCAPING ("P")

Vehicular Use Area 68,138 SF (Exclusive of Deck) 3,750 SF (50,000 x 7.5%) VUA up to 50,000 SF 181 SF (18,138 x 1%) VUA Over 50,000 SF Landscape Area Required 3,931 SF Landscape Area Provided 4,376 SF Trees Required 20 Trees (734' / 35') 21 Trees Trees Provided

PARKING LOT PERIMETER LENGTH ("Per") 1,010 LF Parking Lot Perimeter Length

29 Trees (1,010' / 35') Trees Required Trees Provided 30 Trees

MULTI-FAMILY UNIT TREES TOTAL ("*") Trees Required 171 Trees

Trees Provided

A. Transformer to be screened per detail on sheet L-3 of preliminary landscape submittal by Allen Design. Plantings shall be located to closer than 4' to property

171 Trees

- C. Plantings shall be no closer than 10' to hydrants and
- utility structures No Japanese Knotweed is present on the site. Phragmites australis is found on site, refer to L4.06 for removal instructions and refer to LWP1.00 for
- approximate locations. No replacement trees are proposed to be planted on site and a payment of \$77,200 (193 tree credits x \$400) will be paid into the City of Novi Tree Fund.

FOUNDATION LANDSCAPING - INCLUDING DECK

Building Perimeter 2,072 LF 16,576 SF (2,072' x 8') Landscape Required Landscape Provided 16,645 SF

MULTI-FAMILY REQUIREMENTS

Units Proposed 57 Units (Ground Floor) Trees Required 171 Trees (57 x 3) Trees Provided 171 Trees

193 Trees

WOODLAND REPLACEMENT Trees Required 193 Trees Trees Provided 0 Trees

Trees to be Paid Into Fund **DETENTION POND**

High Water Length 411 LF 288 LF (411' x 70%) Plantings Required Plantings Provided 300 LF (73%)

WAIVERS GRANTED BY PLANNING COMMISSION ON 6/27/18:

- 1. Landscape waiver from Sec. 5.5.3.B.ii for the lack of a berm and screening as the applicant proposed a line of arborvitaes along the property line to soften the view toward the railroad tracks and industrial site beyond in lieu of required landscape screening
- 2. Landscape waiver from Sec. 5.5.3.B.ii for a reduction in the required greenbelt width between the right-of-way and parking areas along Flint/Bond Street (20 ft. width required, a range of 10 ft. to 20 ft. provided). A 2.5 foot brick wall screening the parking and additional landscaping in the narrower areas help to compensate for the lack of space in the areas with just a 10 foot
- 3. Landscape waiver from Sec. 5.5.3.F.ii.b(1) for a reduction in the total number multifamily unit trees provided (147 trees required, 127 provided) as the reduction is only 14% from the total requirements and the site is otherwise well-landscaped
- 4. Landscape waiver from Sec. 5.5.3.F.ii.B(2) for the reduction in the number of interior roadway perimeter trees provided (1 tree short) due to conflict with fire access lane (grass pavers) 5. Landscape waiver from Sec. 5.5.3.D. for the deficiency in the
- foundation landscaping coverage around the parking deck due to limited space available along the southwest side, along the railroad. Large arborvitaes are proposed in that area to help screen the view of the railroad and the industrial site 6. Landscape waiver from Sec. 5.5.3.C.(3) Chart footnote for not
- proposing the required parking lot perimeter trees for the temporary gravel parking proposed to be constructed for use by visitors to Novi Cemetery in Phase 1 (11 trees required, 0 proposed) as the landscape requirements will be met at the time of Phase 3 construction within a certain time mutually agreed between the applicant and the Cit;

ADDITIONAL LANDSCAPE WAIVERS APPROVED BY THE PLANNING COMMISSION ON 12/9/2020: Revision of the landscape waiver from Sec 5.5.3.F.ii.b(1) for a deficiency in the number of total number multifamily unit trees provided (171 required, 129 provided) as the number of ground floor units has increased but the building footprint has not changed and the site is otherwise well-landscaped

Landscape Notes:

- 1. All plants shall be North Midwest American region grown, No. 1 grade plant materials, and shall be true to name, free from physical damage and wind burn.
- Plants shall be full, well-branchesd, and in healthy vigorous growing
- 3. Plants shall be watered before and after planting is complete. 4. All trees must be staked, fertilized and mulched and shall be guaranteed to exhibit a normal growth cycle for at least (2) full years following city approval.
- 5. All material shall conform to the guidelines established in the most
- recent edition of the American Standard for Nursery Stock. 6. Provide clean backfill soil, using material stockpiled on site. Soil shall be screened and free of any debris, foreign material shall be
- added to the planting pits before being backfilled. 7. "Agriform" tabs or similar slow-release fertilizer shall b added to the planting pits before being backfilled.
- 8. Amended planting mix shall consist of $\frac{1}{3}$ screened topsoil, $\frac{1}{3}$ sand and $\frac{1}{3}$ compost, mixed well and spread to the depth as indicated in planting details.
- 9. All plantings shall be mulched per planting details located on this
- 10. The landscape contractor shall be responsible for all work shown on the landscape drawings and specifications. 11. No substitutions or changes of location, or plant types shall be
- made without the approval of the landscape Architect. 12. The City of Novi's Landscape Architect shall be notified of any discrepancies between the plans and field conditions prior to
- 13. The Landscape Contractor shall be responsible for maintaining all plant material in a vertical condition throughout the guaranteed
- 14. The Landscape Architect shall have the right, at any stage of the installation, to reject any work or material that does not meet the requirements of the plans and specifications, if requested by owner.

ensure quantities on drawings and plant list are the same. In the

event of a discrepancy, the quantities on the plans shall prevail. 16. The Landscape Contractor shall seed and mulch or sod (as indicated on plans) all areas disturbed during construction,

15. Contractor shall be responsible for checking plant quantities to

- throughout the contract limits. 17. A pre-emergent weed control agent, "Preen" or equal, shall be applied uniformly on top of all mulched in all planting beds.
- 18. All landscape areas shall be provided with an underground automatic sprinkler system.
- 19. Sod shall be two year old "Baron/Cheridelphi" Kentucky Blue Grass grown in a sod nursery on loam soil.

City of Novi Notes:

- All landscape islands shall be backfilled with a sand mixture to facilitate drainage.
- 2. All proposed landscape islands shall be curbed. All proposed landscape areas shall be irrigated. Overhead utility lines and poles to be relocated as
- directed by utility company of record. Evergreen and canopy trees shall be planted a minimum of 10' from a fire hydrant, and manhole, 15'
- from overhead wires. All plant material shall be guaranteed for two (2) years after City Approval and shall be installed and maintained according to City of Novi standards. Failing material shall be replaced with 3 months, or the next appropriate time as determined by the City Landscape
- All proposed street trees shall be planted a minimum of 4' from both the back of curb and proposed walks.
- All tree and shrub planting beds shall be mulched with shredded hardwood bark, spread to minimum depth of 4". All lawn area trees shall have a 4' diameter circle of shredded hardwood mulch 3" away from trunk. All perennial, annual and ground cover beds shall receive 2" of dark colored bark mulch as indicated on the plant list. Mulch is to be free from debris and foreign material, and shall contain no pieces of inconsistent size.
- All substitutions or deviations from the Landscape Plan must be approved in writing by the City of Novi prior to their installation.

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DESIGNED BY:

DRAWN BY:

PLOT DATE:

ISSUE DATE

NO:

ISSUE FOR PRICING/BIDDING:

ISSUE FOR CONSTRUCTION:

DATE:

08/14/2020

09/25/2020

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expressly conditioned on the full and timely paymen

Landscape Architecture, L.L.C. and, in the absence

of any written agreement to the contrary, is limited to

a one-time use on the site indicated on these plans.

of all fees otherwise due Humphreys & Partners

depicted in sealed construction drawings is

limitation the construction of any landscape

LAOR:

SPENCER J. OKESON

DANIEL R. ERLANDSON


DESCRIPTION:

ADDENDUM B

ADDENDUM C

S.J.O. & I.K.

06/25/2021

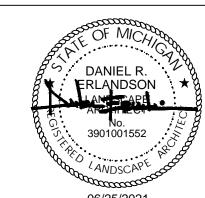

HUMPHREYS & PARTNERS LANDSCAPE ARCHITECTURE, L.L.C. 5339 ALPHA ROAD SUITE 300 DALLAS, TX 75240 T: (972) 701-9636 F: (972) 701-9639 W: www.hplastudio.com

CLIENT DTN MANAGEMENT 2502 LAKE LANSING RD SUITE C, LANSING, MI 48912

SHEET TITLE LANDSCAPE PLAN

SHEET NUMBER

VISED

SCALE: AS INDICATED

CITY JOB #: JSP18-0010

Call MISS DIG before digging 1-800-482-7171

*ALL TRANSFORMERS SHALL BE SCREENED PER THIS DETAIL

	PLS
	FLO
Common Name	Ounces/Acre
River Bulrush	1.0
Bristly Sedge	2.5
	0.5
Bottlebrush Sedge	4.0
Common Tussock Sedge	1.0
	2.0
-	1.0
Common Rush	1.0
Rice Cut Grass	3.0
Hard-Stemmed Bulrush	2.5
Chairmaker's Rush	1.5
Great Bulrush	6.0
Total	26.0
Common Oat	360.0
	100.0
Total	460.0
Sweet Flag	1.0
	2.0
	1.0
	1.0
	6.0
	0.5
· · · · · · · · · · · · · · · · · · ·	0.5
	4.0
· · · · · · · · · · · · · · · · · · ·	6.0
-	0.2
	0.2
	1.0
	1.0
3	16.0
	0.5
·	2.0
	4.0
NA CONTRACTOR IN CONTRACTOR	2.0
ACCURATION OF SECURITION OF THE CONTRACT OF	6.0
And the second second second	1.0
	56.0
	Bristly Sedge Common Lake Sedge Bottlebrush Sedge Common Tussock Sedge Brown Fox Sedge Great Spike Rush Common Rush Rice Cut Grass Hard-Stemmed Bulrush Chairmaker's Rush Great Bulrush Total Common Oat Annual Rye

Mix Statistics					
Native Component	PLS lbs./Acre	PLS Seeds/Acre	PLS Seeds/Sq. Ft.	% of Native Mix	
Forbs	3.50	1,354,097	31.09	34.63%	
Grasses	1.63	2,556,083	58.68	65.37%	
Total Natives	5.13	3,910,179	89.77	100.00%	
Cover	28.75	4,343,800	99.72		
Totals	33.88	8,253,979	189.49		

Prior to applying the detention basin seed, the contractor shall provide proof of the seed mix being used in the detention basin in the form of a photograph of the seed bag or invoice via email to Rick Meader at rmeader@cityofnovi.org

		PLS
Botanical Name	Common Name	Ounces/Acre
Permanent Grasses/Sedges/Rushes:		
Bolboschoenus fluviatilis	River Bulrush	1.00
Carex cristatella	Crested Oval Sedge	0.50
Carex lurida	Bottlebrush Sedge	3.00
Carex vulpinoidea	Brown Fox Sedge	2.00
Elymus virginicus	Virginia Wild Rye	24.00
Glyceria striata	Fowl Manna Grass	1.00
Juncus effusus	Common Rush	1.00
Leersia oryzoides	Rice Cut Grass	1.00
Panicum virgatum	Switch Grass	2.00
Schoenoplectus tabernaemontani	Great Bulrush	3.00
Scirpus atrovirens	Dark Green Rush	2.00
Scirpus cyperinus	Wool Grass	1.00
	Total	41.50
Tamanawami Carrani		
Temporary Cover: Avena sativa	Common Oot	360.00
Lolium multiflorum	Common Oat	360.00
Lonum munnorum	Annual Rye Total	100.00 460.00
Forbs & Shrubs:		
Alisma subcordatum	Common Water Plantain	2.50
Asclepias incarnata	Swamp Milkweed	2.00
Bidens spp.	Bidens Species	2.00
Eupatorium perfoliatum	Common Boneset	1.00
Helenium autumnale	Sneezeweed	2.00
Iris virginica v. shrevei	Blue Flag	4.00
Lycopus americanus	Common Water Horehound	0.50
Mimulus ringens	Monkey Flower	1.00
Penthorum sedoides	Ditch Stonecrop	0.50
Persicaria spp.	Pinkweed Species	2.00
Rudbeckia subtomentosa	Sweet Black-Eyed Susan	1.00
Rudbeckia triloba	Brown-Eyed Susan	1.50
Sagittaria latifolia	Common Arrowhead	1.00
Senna hebecarpa	Wild Senna	2.00
Symphyotrichum lanceolatum	Panicled Aster	0.50
Symphyotrichum novae-angliae	New England Aster	0.50
Thalictrum dasycarpum	Purple Meadow Rue	2.00
Z I	Total	26.00

Mix Statistics					
Native Component	PLS lbs./Acre		PLS Seeds/Acre	PLS Seeds/Sq. Ft.	% of Native Mix
Forbs		1.63	1,334,949	30.65	32.19%
Grasses		2.59	2,812,650	64.57	67.81%
Total Natives		4.22	4,147,599	95.22	100.00%
Cover		28.75	4,343,800	99.72	
Totals		32 97	8 491 399	194 94	

Phragmites Removal Treatment:

Phragmites australis is a plant that grows in dense monocultures that will outcompete native vegetation. If Phragmites is not managed, they can restrict water flow, fish migration, and native plant growth. These plants can reach 20 feet in height. Nearly 80% of their yearly biomass is contained underground in the form of dense root mass and rhizomes. Mature plants can produce more than 2000 seeds a year. Rhizomes may exceed 60 feet in length and grow more than 6 feet per year. Herbicide treatment is the recommended management option to control Phragmites. After an herbicide treatment, using a prescribed fire is a great way to manage Phragmites duff and seed heads.

Apply a glyphosate after the plants are in full bloom in the late summer up until the first killing frost. The glyphosate can be applied by a backpack sprayer or hand swiping. When using a sprayer, use only on low wind days. Spray close to the leaves and use a flat fan nozzle to avoid non-target plants. The backpack sprayer is best used in scattered to dense stands. Hand swiping or wicking is covering each individual stem and leaf by applying herbicide to a cloth glove worn over a chemical resistant glove. This is best utilized when Phragmites is scattered or isolated. Also this method is preferred if there are areas of desirable, native plant species that must be avoided. The recommended herbicide rate is 1-2% (2 ounces per gallon). A blue dye (2 ounces per gallon) is recommended to identify the coverage and location of spraying. It may be necessary to retreat the following years because the herbicide may have not thoroughly transferred through the root system. The recommended glyphosate to use on Phragmites include Rodeo, Aquamaster, and AquaNeat.

Prescribed fire is an effective tool for the removal of Phragmites and may promote native vegetation growth. It is recommended to use prescribed fire where large, dense stands of Phragmites occur. The use of prescribed fire without first treating the area with herbicide does not control Phragmites. Prescribed fire should be conducted in the late summer of the following year after the herbicide treatment. This will allow some time for native vegetation to green-up before the first frost, kill any remaining Phragmites, and destroy seed heads and dead stems.

The ideal treatment plan is to use a glyphosate herbicide treatment in September the first year. A prescribed fire in July or August of year two would remove dead debris and seed heads. In September, a follow-up glyphosate treatment to spot treat remaining Phragmites plant. In year three, an additional September spot treatment may be needed if any Phragmites remain.

OPEN SPACE CALCULATIONS

OPEN SPACE REQUIREMENTS:

SOUTH PARK AREA (AS SHOWN) 9,583 SF POOL AREA (AS SHOWN) ADDITIONAL OPEN SPACE: BUILDING 1 BALCONIES CLUB HOUSE (AS SHOWN) COURTYARDS (AS SHOWN) BUILDING 2 BALCONIES FITNESS ROOM (AS SHOWN)

COURTYARDS (AS SHOWN)

EAST PARK AREA (AS SHOWN)

OPEN SPACE PROVIDED:

3,162 SF 64,990 SF = 1.49 AC

Call MISS DIG before digging 1-800-482-7171

TOTAL PARCEL X 15% = 6.87 AC X .15 = 1.03 AC

8,956 SF 7,690 SF 7,127 SF 6,752 SF 7,297 SF

7,671 SF

6752 SF

REVISED

CITY JOB #: JSP18-0010

2021-JUNE-25

DESIGNED BY: SPENCER J. OKESON DRAWN BY: S.J.O. & I.K. DANIEL R. ERLANDSON PLOT DATE: 06/25/2021

ISSUE FOR PRICING/BIDDING:

ISSUE FOR PERMIT APPLICATION:

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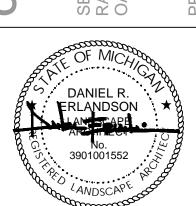
ISSUE DATE

REVISION SCHEDULE DATE: NO: DESCRIPTION: ADDENDUM B 08/14/2020 09/25/2020 ADDENDUM C

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06/25/2021

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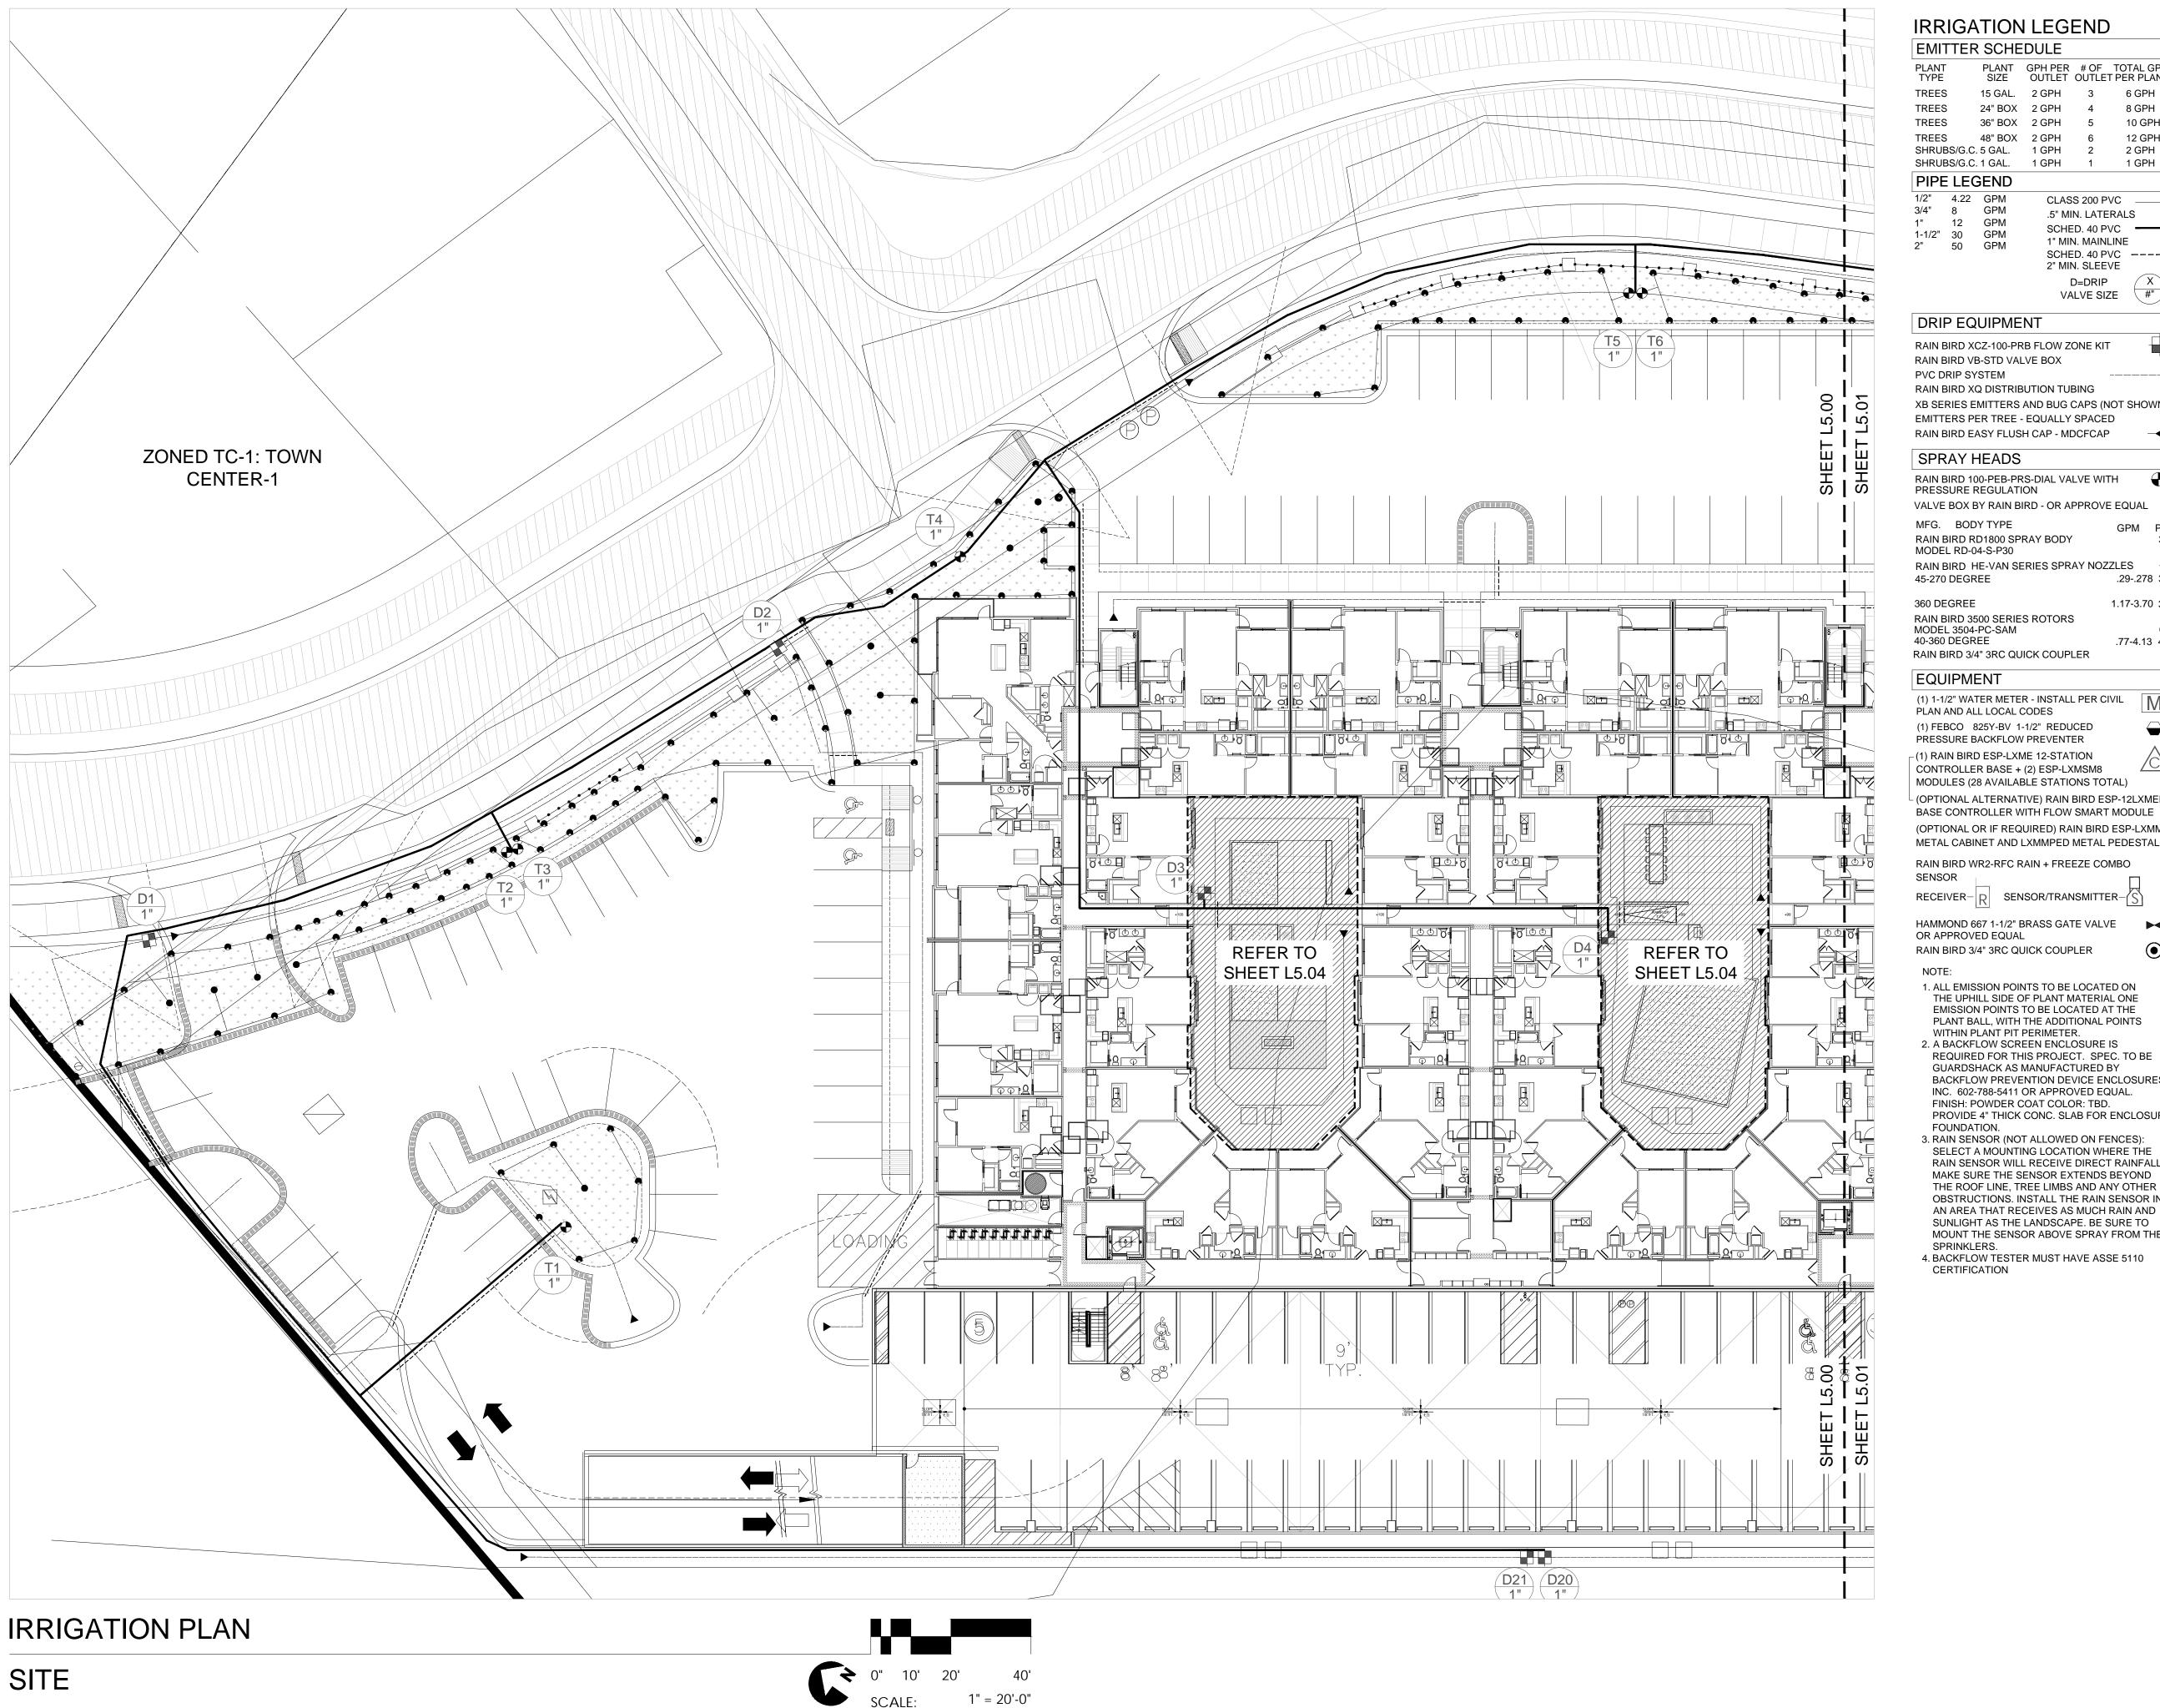
W: www.hplastudio.com CLIENT DTN MANAGEMENT 2502 LAKE LANSING RD SUITE C,

LANSING, MI 48912

SHEET TITLE LANDSCAPE PLAN

SHEET NUMBER

SCALE: AS INDICATED



IRRIGATION LEGEND

1	EMITTER	SCHE	DULE		
	PLANT TYPE	PLANT SIZE	GPH PER OUTLET		TOTAL GPH PER PLANT
	TREES	15 GAL.	2 GPH	3	6 GPH
-	TREES	24" BOX	2 GPH	4	8 GPH
	TREES	36" BOX	2 GPH	5	10 GPH
	TREES SHRUBS/G.C.	48" BOX 5 GAL.	2 GPH 1 GPH	6 2	12 GPH 2 GPH

SHRUBS/G.C. 1 GAL. 1 GPH 1 1 GPH PIPE LEGEND 1/2" 4.22 GPM CLASS 200 PVC 3/4" 8 GPM .5" MIN. LATERALS 12 GPM SCHED. 40 PVC —— 1-1/2" 30 GPM 2" 50 GPM

1" MIN. MAINLINE SCHED. 40 PVC ----2" MIN. SLEEVE D=DRIP VALVE SIZE #"

DRIP EQUIPMENT

RAIN BIRD XCZ-100-PRB FLOW ZONE KIT RAIN BIRD VB-STD VALVE BOX PVC DRIP SYSTEM RAIN BIRD XQ DISTRIBUTION TUBING

XB SERIES EMITTERS AND BUG CAPS (NOT SHOWN) EMITTERS PER TREE - EQUALLY SPACED RAIN BIRD EASY FLUSH CAP - MDCFCAP

SPRAY HEADS

RAIN BIRD 100-PEB-PRS-DIAL VALVE WITH PRESSURE REGULATION VALVE BOX BY RAIN BIRD - OR APPROVE EQUAL MFG. BODY TYPE GPM PSI RAIN BIRD RD1800 SPRAY BODY MODEL RD-04-S-P30 RAIN BIRD HE-VAN SERIES SPRAY NOZZLES .29-.278 30 45-270 DEGREE 1.17-3.70 30 360 DEGREE RAIN BIRD 3500 SERIES ROTORS MODEL 3504-PC-SAM 40-360 DEGREE .77-4.13 45

EQUIPMENT

(1) 1-1/2" WATER METER - INSTALL PER CIVIL PLAN AND ALL LOCAL CODES (1) FEBCO 825Y-BV 1-1/2" REDUCED PRESSURE BACKFLOW PREVENTER -(1) RAIN BIRD ESP-LXME 12-STATION CONTROLLER BASE + (2) ESP-LXMSM8 MODULES (28 AVAILABLE STATIONS TOTAL) - (OPTIONAL ALTERNATIVE) RAIN BIRD ESP-12LXMEF BASE CONTROLLER WITH FLOW SMART MODULE (OPTIONAL OR IF REQUIRED) RAIN BIRD ESP-LXMM

RAIN BIRD WR2-RFC RAIN + FREEZE COMBO SENSOR

RECEIVER- | SENSOR/TRANSMITTER- |

HAMMOND 667 1-1/2" BRASS GATE VALVE OR APPROVED EQUAL RAIN BIRD 3/4" 3RC QUICK COUPLER

NOTE: 1. ALL EMISSION POINTS TO BE LOCATED ON

THE UPHILL SIDE OF PLANT MATERIAL ONE EMISSION POINTS TO BE LOCATED AT THE PLANT BALL, WITH THE ADDITIONAL POINTS WITHIN PLANT PIT PERIMETER. 2. A BACKFLOW SCREEN ENCLOSURE IS REQUIRED FOR THIS PROJECT. SPEC. TO BE GUARDSHACK AS MANUFACTURED BY BACKFLOW PREVENTION DEVICE ENCLOSURES INC. 602-788-5411 OR APPROVED EQUAL. FINISH: POWDER COAT COLOR: TBD. PROVIDE 4" THICK CONC. SLAB FOR ENCLOSURE

FOUNDATION. 3. RAIN SENSOR (NOT ALLOWED ON FENCES): SELECT A MOUNTING LOCATION WHERE THE RAIN SENSOR WILL RECEIVE DIRECT RAINFALL MAKE SURE THE SENSOR EXTENDS BEYOND THE ROOF LINE, TREE LIMBS AND ANY OTHER OBSTRUCTIONS. INSTALL THE RAIN SENSOR IN AN AREA THAT RECEIVES AS MUCH RAIN AND SUNLIGHT AS THE LANDSCAPE. BE SURE TO MOUNT THE SENSOR ABOVE SPRAY FROM THE

SPRINKLERS. 4. BACKFLOW TESTER MUST HAVE ASSE 5110 CERTIFICATION DESIGNED BY: DRAWN BY:

LAOR:

SPENCER J. OKESON S.J.O. & I.K.

DANIEL R. ERLANDSON PLOT DATE: 06/25/2021

ISSUE FOR PRICING/BIDDING:

ISSUE FOR PERMIT APPLICATION:

ISSUE FOR CONSTRUCTION: ISSUE DATE

	REVISION SCHEDULE						
NO:	DATE:	DESCRIPTION:					
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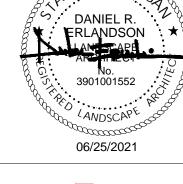
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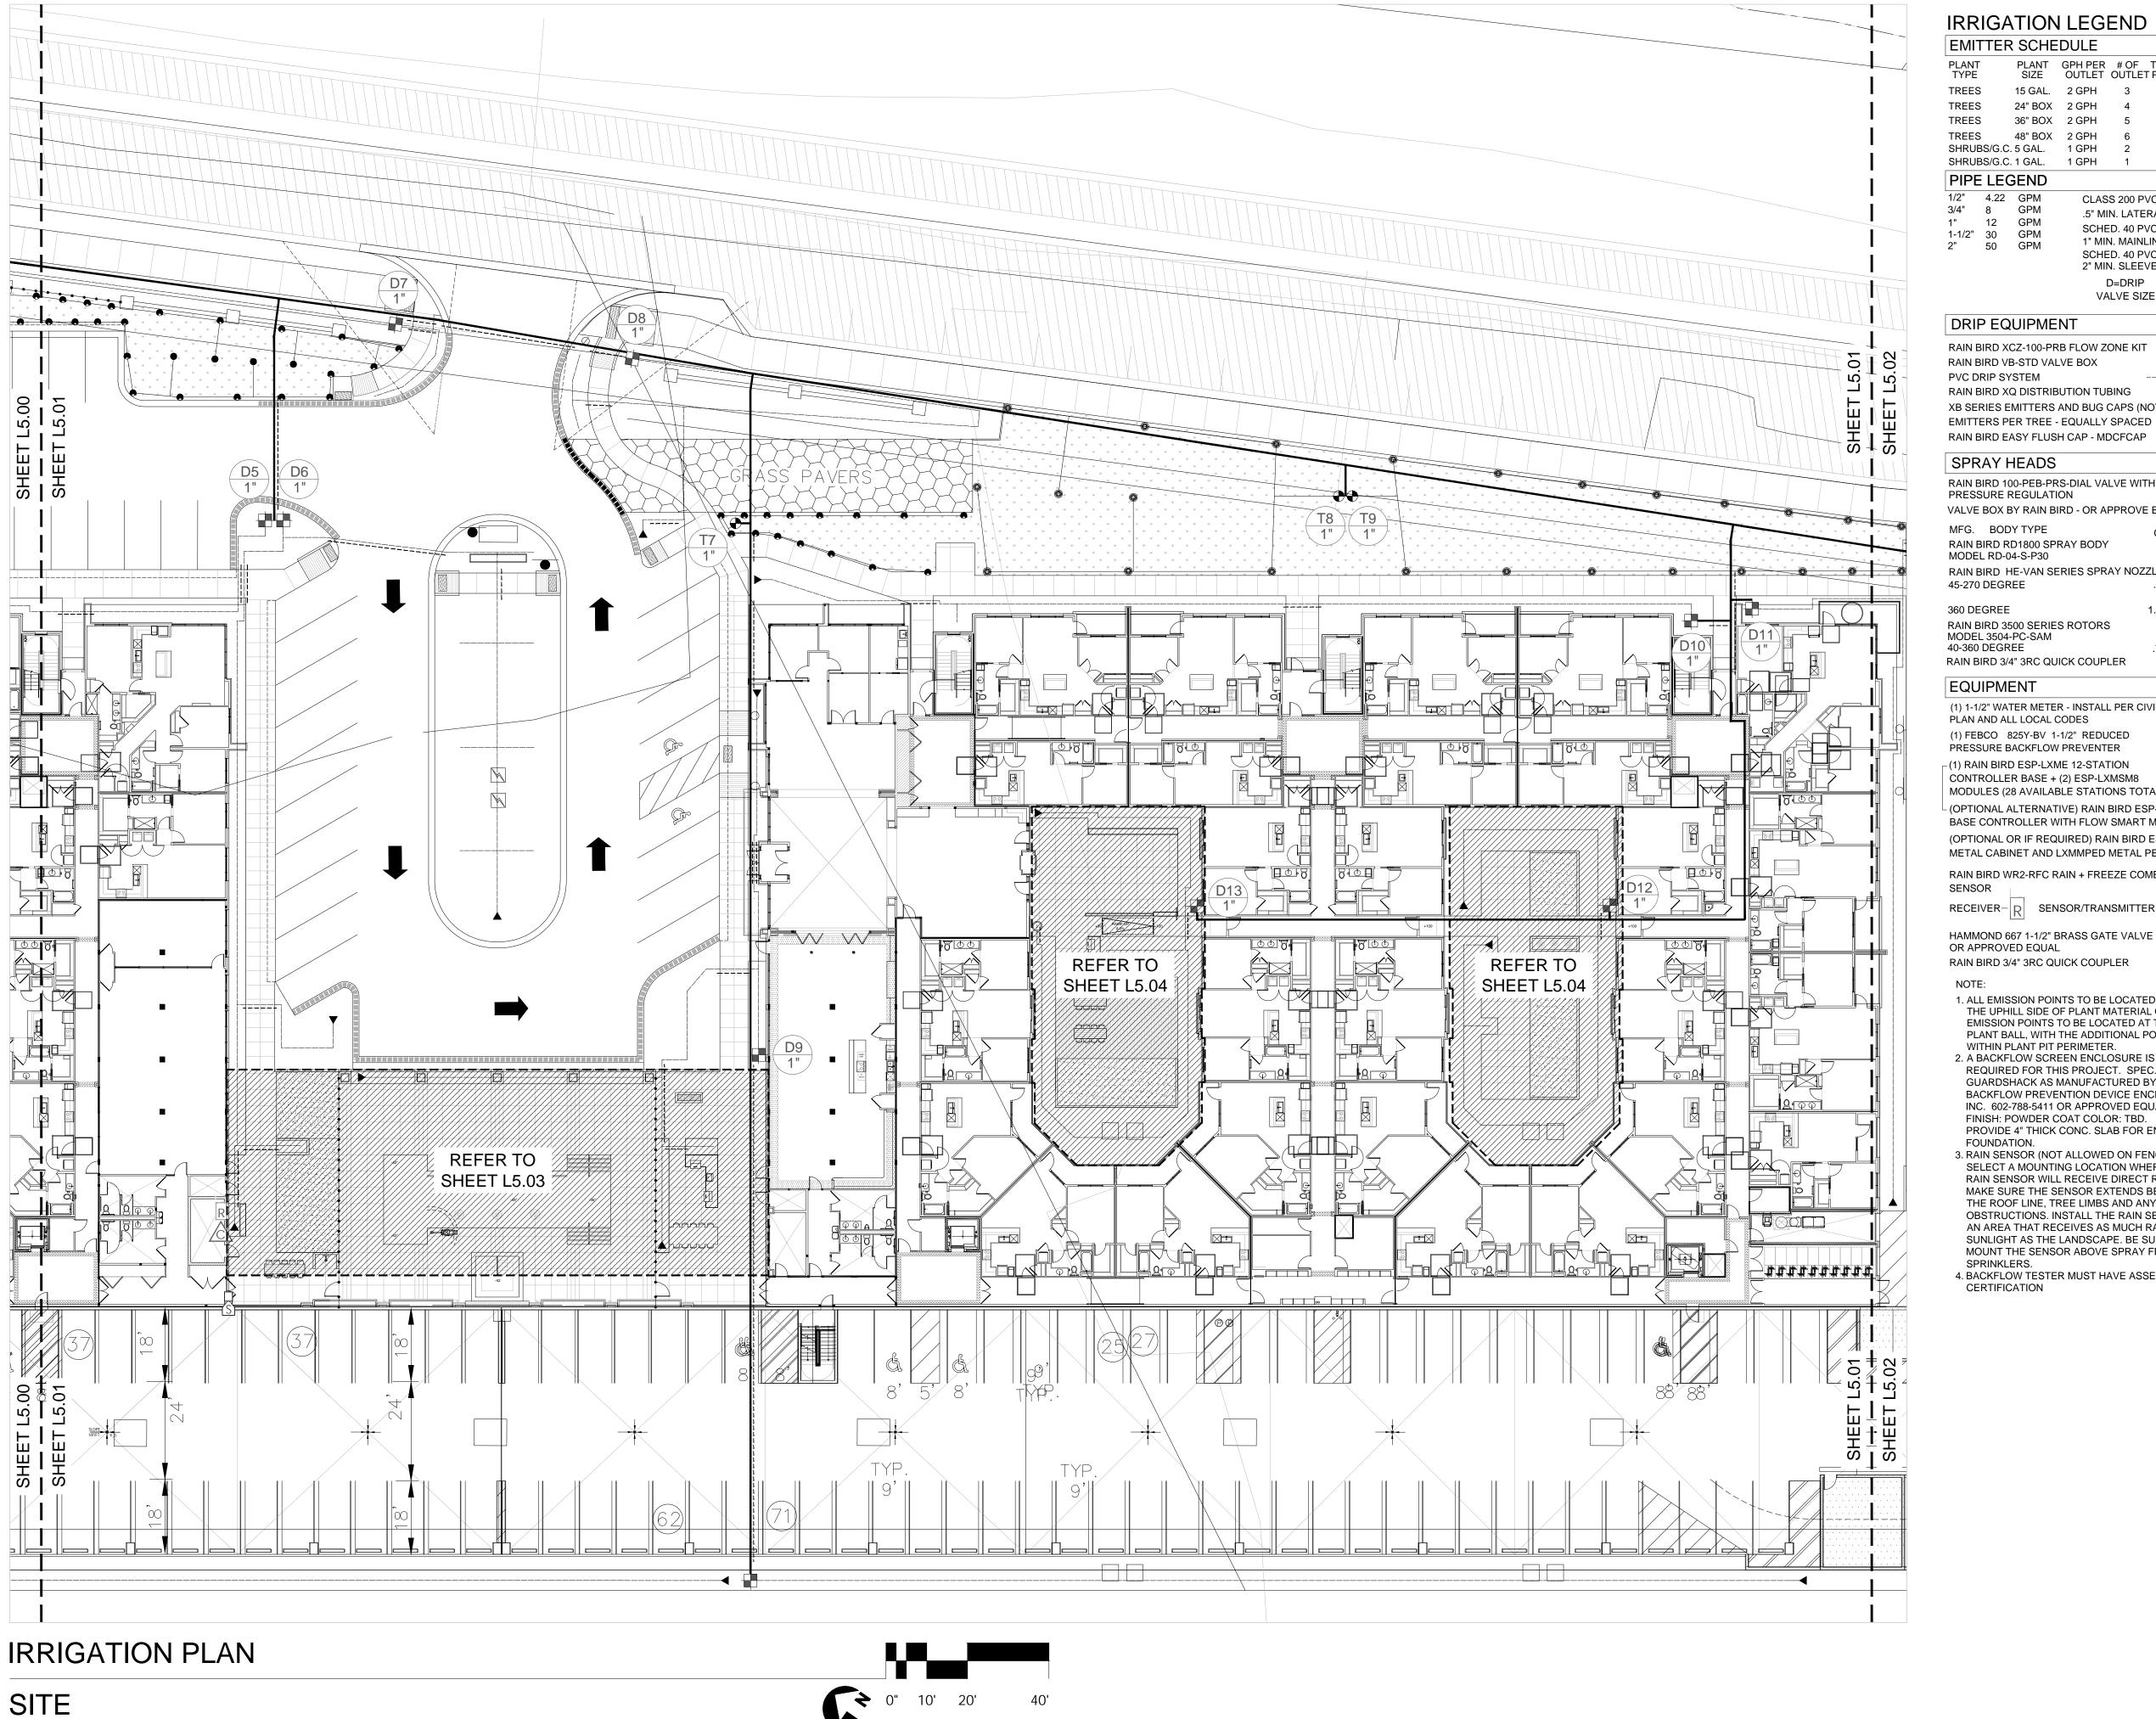
SHEET TITLE

IRRIGATION PLAN

SHEET NUMBER

SCALE: AS INDICATED CITY JOB #: JSP18-0010

2021



1" = 20'-0"

IRRIGATION LEGEND

EMITTER	SCHE	DULE		
PLANT TYPE	PLANT SIZE	GPH PER OUTLET		TOTAL GP PER PLAN
TREES	15 GAL.	2 GPH	3	6 GPH
TREES	24" BOX	2 GPH	4	8 GPH
TREES	36" BOX	2 GPH	5	10 GPH
TREES	48" BOX	2 GPH	6	12 GPH
SHRUBS/G.C.	5 GAL.	1 GPH	2	2 GPH
SHRUBS/G.C.	1 GAL.	1 GPH	1	1 GPH

PIPE LEGEND 1/2" 4.22 GPM CLASS 200 PVC 3/4" 8 GPM .5" MIN. LATERALS 12 GPM SCHED. 40 PVC —— 1-1/2" 30 GPM 1" MIN. MAINLINE 2" 50 GPM

SCHED. 40 PVC ----2" MIN. SLEEVE D=DRIP VALVE SIZE #"

DRIP EQUIPMENT

RAIN BIRD XCZ-100-PRB FLOW ZONE KIT RAIN BIRD VB-STD VALVE BOX PVC DRIP SYSTEM RAIN BIRD XQ DISTRIBUTION TUBING XB SERIES EMITTERS AND BUG CAPS (NOT SHOWN) EMITTERS PER TREE - EQUALLY SPACED

SPRAY HEADS

RAIN BIRD 100-PEB-PRS-DIAL VALVE WITH PRESSURE REGULATION VALVE BOX BY RAIN BIRD - OR APPROVE EQUAL

MFG. BODY TYPE GPM PSI RAIN BIRD RD1800 SPRAY BODY MODEL RD-04-S-P30 RAIN BIRD HE-VAN SERIES SPRAY NOZZLES .29-.278 30 45-270 DEGREE 1.17-3.70 30 360 DEGREE RAIN BIRD 3500 SERIES ROTORS MODEL 3504-PC-SAM

40-360 DEGREE .77-4.13 45 RAIN BIRD 3/4" 3RC QUICK COUPLER

(1) 1-1/2" WATER METER - INSTALL PER CIVIL PLAN AND ALL LOCAL CODES

(1) FEBCO 825Y-BV 1-1/2" REDUCED PRESSURE BACKFLOW PREVENTER $_{
m ilde{\square}}$ (1) RAIN BIRD ESP-LXME 12-STATION CONTROLLER BASE + (2) ESP-LXMSM8

MODULES (28 AVAILABLE STATIONS TOTAL) - (OPTIONAL ALTERNATIVE) RAIN BIRD ESP-12LXMEF BASE CONTROLLER WITH FLOW SMART MODULE (OPTIONAL OR IF REQUIRED) RAIN BIRD ESP-LXMM METAL CABINET AND LXMMPED METAL PEDESTAL

RAIN BIRD WR2-RFC RAIN + FREEZE COMBO SENSOR

RECEIVER-R SENSOR/TRANSMITTER-S HAMMOND 667 1-1/2" BRASS GATE VALVE

NOTE:

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GUARDSHACK AS MANUFACTURED BY BACKFLOW PREVENTION DEVICE ENCLOSURES INC. 602-788-5411 OR APPROVED EQUAL. FINISH: POWDER COAT COLOR: TBD. PROVIDE 4" THICK CONC. SLAB FOR ENCLOSURE FOUNDATION. 3. RAIN SENSOR (NOT ALLOWED ON FENCES):

SELECT A MOUNTING LOCATION WHERE THE RAIN SENSOR WILL RECEIVE DIRECT RAINFALL MAKE SURE THE SENSOR EXTENDS BEYOND THE ROOF LINE, TREE LIMBS AND ANY OTHER OBSTRUCTIONS. INSTALL THE RAIN SENSOR IN AN AREA THAT RECEIVES AS MUCH RAIN AND SUNLIGHT AS THE LANDSCAPE. BE SURE TO MOUNT THE SENSOR ABOVE SPRAY FROM THE SPRINKLERS.

4. BACKFLOW TESTER MUST HAVE ASSE 5110 CERTIFICATION

DESIGNED BY:

DRAWN BY:

07/02/2019

LAOR:

SPENCER J. OKESON S.J.O. & I.K. DANIEL R. ERLANDSON

06/25/2021

PLOT DATE:

ISSUE FOR PRICING/BIDDING:

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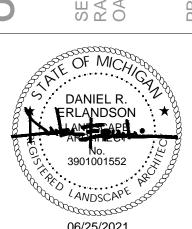
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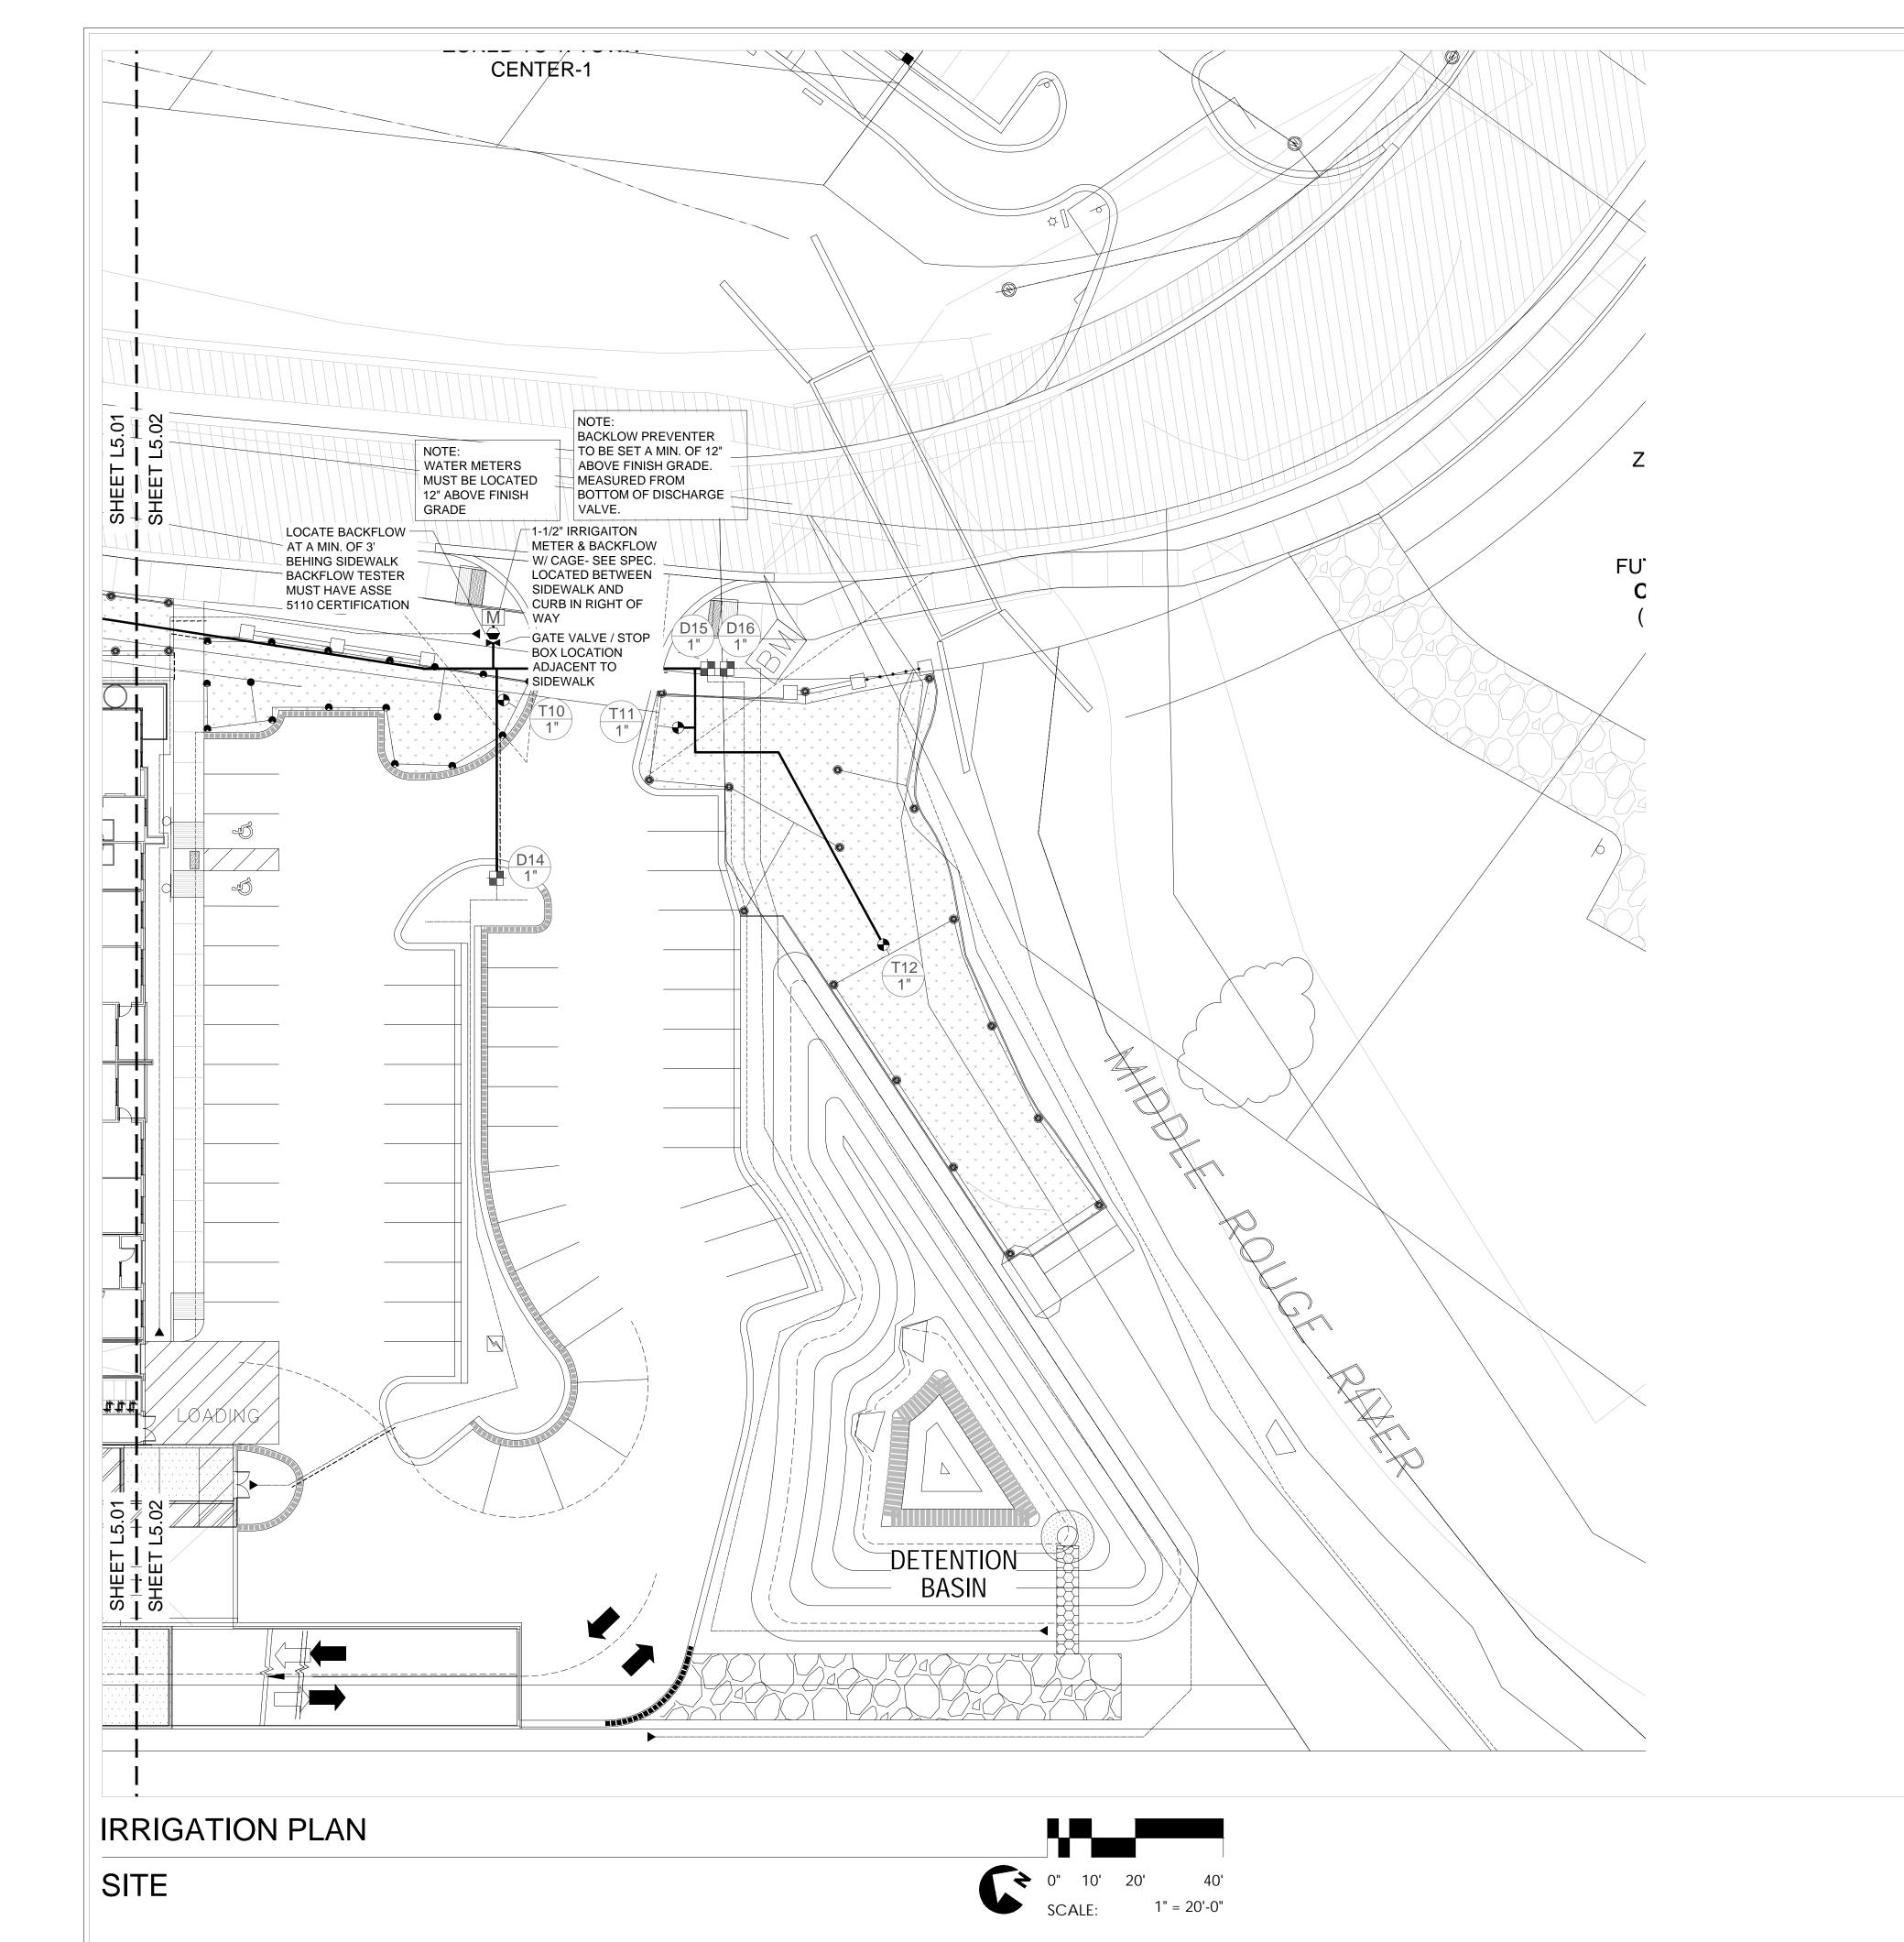
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CLIENT DTN MANAGEMENT 2502 LAKE LANSING RD SUITE C, LANSING, MI 48912

SHEET TITLE

IRRIGATION PLAN

SHEET NUMBER



IRRIGATION LEGEND

EMITTER SCHEDULE

PLANT GPH PER # OF TOTAL GPH SIZE OUTLET OUTLET PER PLANT TREES 15 GAL. 2 GPH 6 GPH TREES 8 GPH 10 GPH 48" BOX 2 GPH 12 GPH SHRUBS/G.C. 5 GAL. 1 GPH 2 GPH SHRUBS/G.C. 1 GAL. 1 GPH 1 1 GPH PIPE LEGEND 1/2" 4.22 GPM CLASS 200 PVC 3/4" 8 GPM .5" MIN. LATERALS 1" 12 GPM SCHED. 40 PVC —— 1-1/2" 30 GPM 1" MIN. MAINLINE 2" 50 GPM SCHED. 40 PVC ----2" MIN. SLEEVE

DRIP EQUIPMENT

RAIN BIRD XCZ-100-PRB FLOW ZONE KIT RAIN BIRD VB-STD VALVE BOX PVC DRIP SYSTEM RAIN BIRD XQ DISTRIBUTION TUBING XB SERIES EMITTERS AND BUG CAPS (NOT SHOWN)

D=DRIP

VALVE SIZE #"

EMITTERS PER TREE - EQUALLY SPACED RAIN BIRD EASY FLUSH CAP - MDCFCAP

SPRAY HEADS

RAIN BIRD 100-PEB-PRS-DIAL VALVE WITH PRESSURE REGULATION VALVE BOX BY RAIN BIRD - OR APPROVE EQUAL

MFG. BODY TYPE GPM PSI RAIN BIRD RD1800 SPRAY BODY MODEL RD-04-S-P30 RAIN BIRD HE-VAN SERIES SPRAY NOZZLES 45-270 DEGREE .29-.278 30

1.17-3.70 30 360 DEGREE RAIN BIRD 3500 SERIES ROTORS MODEL 3504-PC-SAM

.77-4.13 45

40-360 DEGREE RAIN BIRD 3/4" 3RC QUICK COUPLER

EQUIPMENT

(1) 1-1/2" WATER METER - INSTALL PER CIVIL PLAN AND ALL LOCAL CODES (1) FEBCO 825Y-BV 1-1/2" REDUCED PRESSURE BACKFLOW PREVENTER

_(1) RAIN BIRD ESP-LXME 12-STATION CONTROLLER BASE + (2) ESP-LXMSM8 MODULES (28 AVAILABLE STATIONS TOTAL) (OPTIONAL ALTERNATIVE) RAIN BIRD ESP-12LXMEF BASE CONTROLLER WITH FLOW SMART MODULE (OPTIONAL OR IF REQUIRED) RAIN BIRD ESP-LXMM

METAL CABINET AND LXMMPED METAL PEDESTAL

RAIN BIRD WR2-RFC RAIN + FREEZE COMBO SENSOR

RECEIVER-R SENSOR/TRANSMITTER-

HAMMOND 667 1-1/2" BRASS GATE VALVE OR APPROVED EQUAL RAIN BIRD 3/4" 3RC QUICK COUPLER

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4. BACKFLOW TESTER MUST HAVE ASSE 5110 CERTIFICATION

DESIGNED BY: DRAWN BY:

SPENCER J. OKESON S.J.O. & I.K. DANIEL R. ERLANDSON

06/25/2021

LAOR: PLOT DATE:

ISSUE FOR PRICING/BIDDING:

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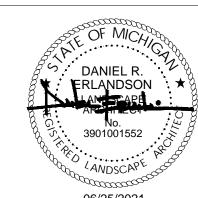
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2021 **HUMPHREYS & PARTNERS** LANDSCAPE ARCHITECTURE, L.L.C. 5339 ALPHA ROAD SUITE 300 DALLAS, TX 75240 T: (972) 701-9636 F: (972) 701-9639 W: www.hplastudio.com

> CLIENT DTN MANAGEMENT 2502 LAKE LANSING RD SUITE C, LANSING, MI 48912


SHEET TITLE

IRRIGATION PLAN

SHEET NUMBER

SCALE: AS INDICATED CITY JOB #: JSP18-0010

REVISED

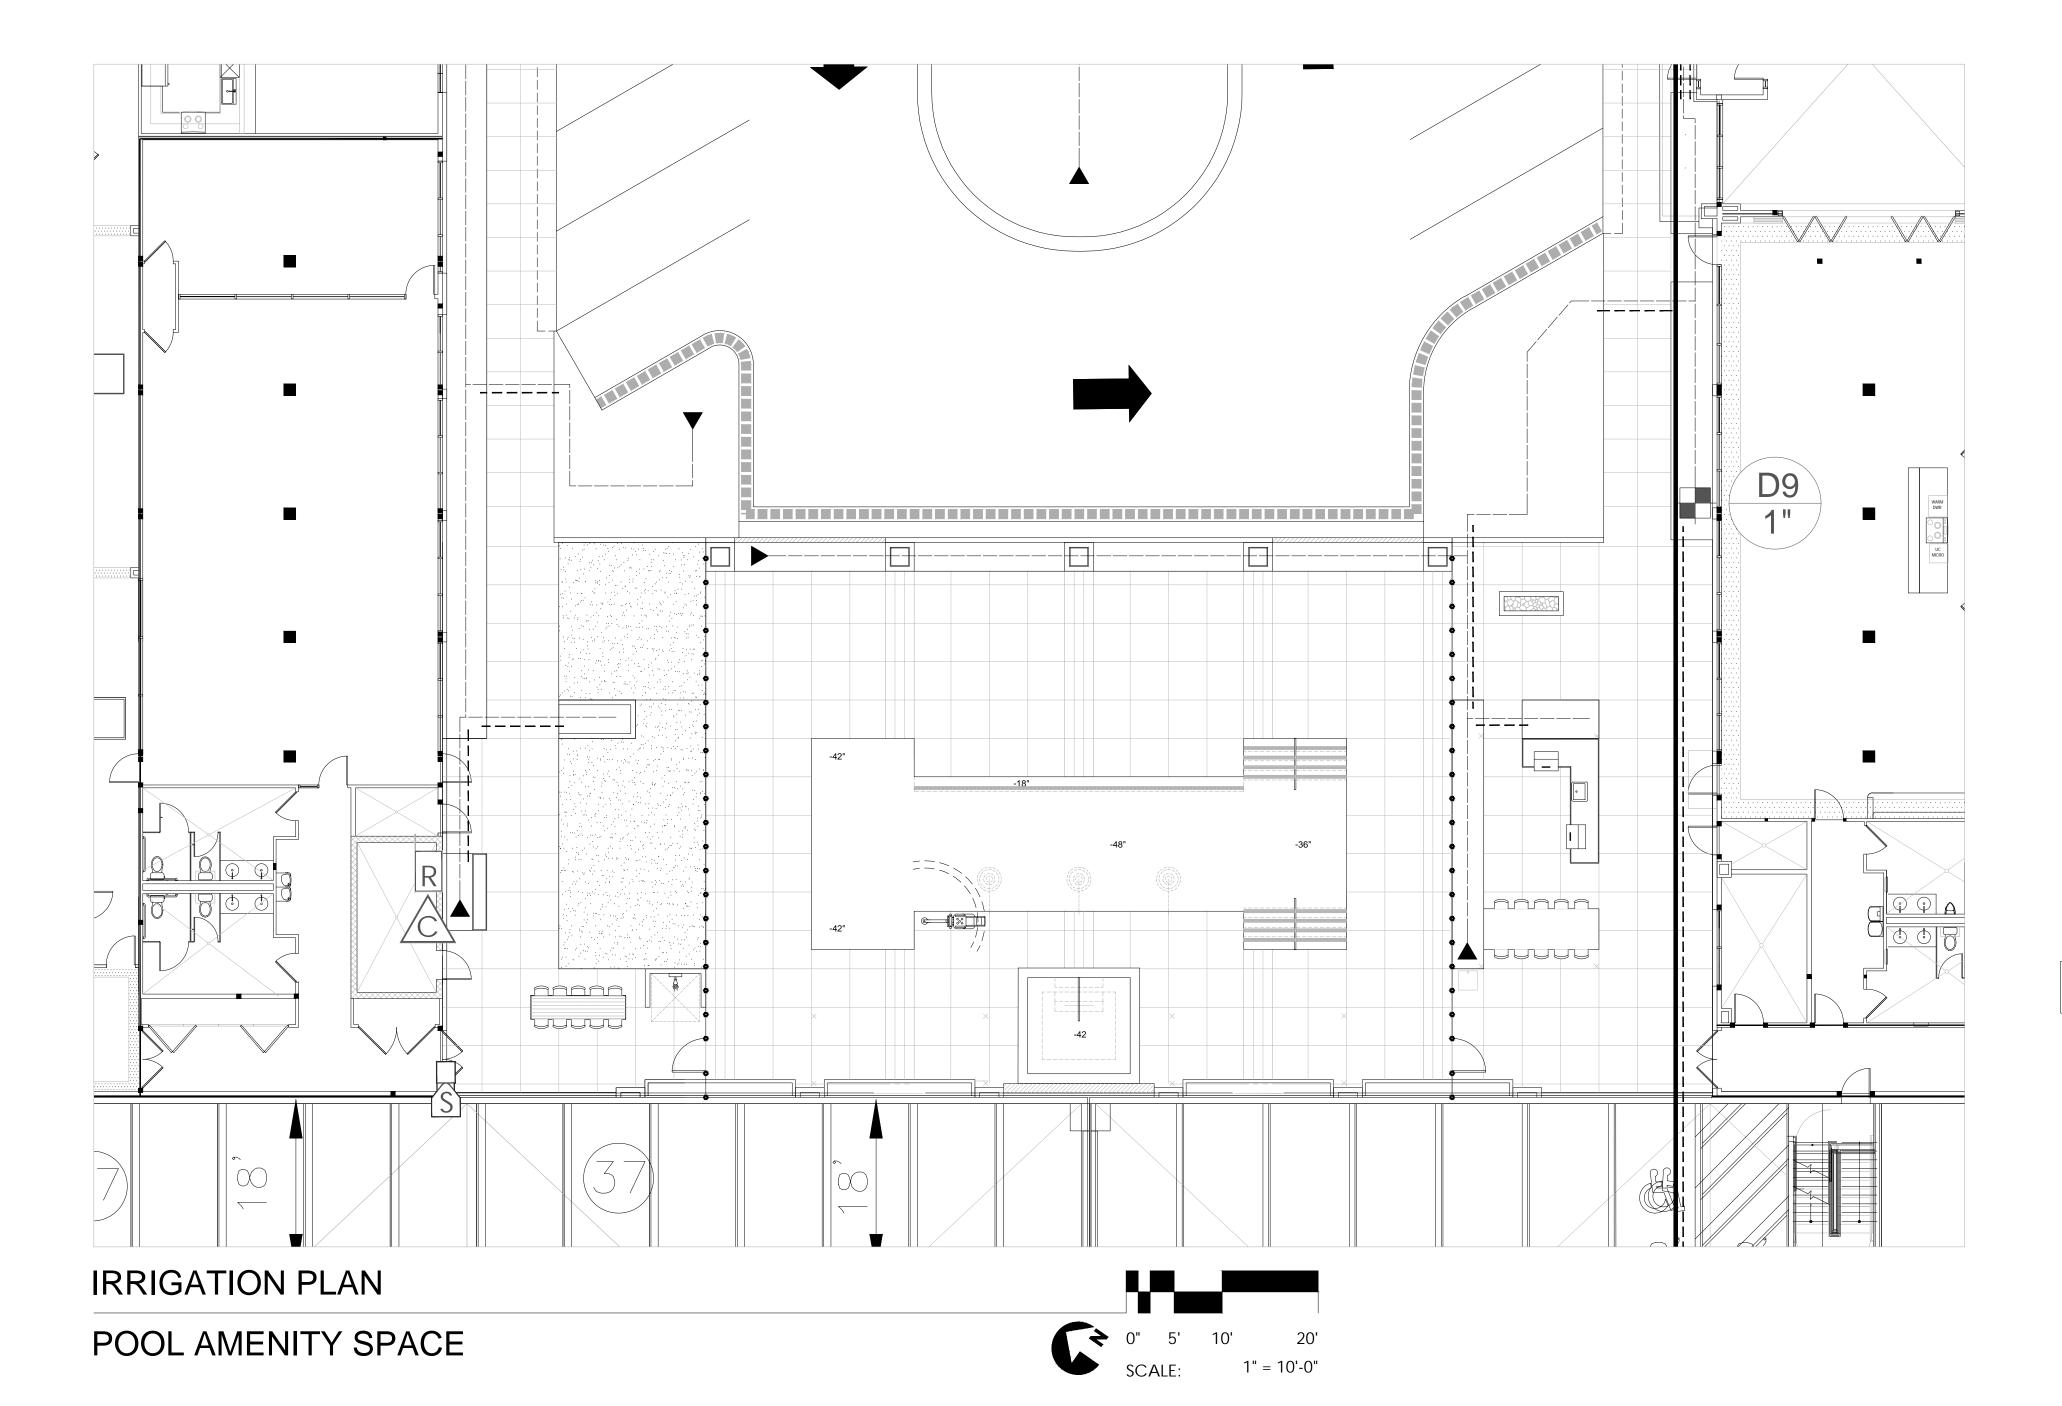

IRRIGATION LEGEND EMITTER SCHEDULE 8 GPH 48" BOX 2 GPH 12 GPH SHRUBS/G.C. 5 GAL. 1 GPH 2 2 GPH SHRUBS/G.C. 1 GAL. 1 GPH 1 1 GPH PIPE LEGEND 1/2" 4.22 GPM CLASS 200 PVC —— 3/4" 8 GPM .5" MIN. LATERALS 1" 12 GPM SCHED. 40 PVC 1-1/2" 30 GPM 1" MIN. MAINLINE 2" 50 GPM SCHED. 40 PVC ----2" MIN. SLEEVE D=DRIP X VALVE SIZE (#") DRIP EQUIPMENT RAIN BIRD XCZ-100-PRB FLOW ZONE KIT RAIN BIRD VB-STD VALVE BOX PVC DRIP SYSTEM RAIN BIRD XQ DISTRIBUTION TUBING XB SERIES EMITTERS AND BUG CAPS (NOT SHOWN) EMITTERS PER TREE - EQUALLY SPACED RAIN BIRD EASY FLUSH CAP - MDCFCAP SPRAY HEADS RAIN BIRD 100-PEB-PRS-DIAL VALVE WITH PRESSURE REGULATION VALVE BOX BY RAIN BIRD - OR APPROVE EQUAL MFG. BODY TYPE RAIN BIRD RD1800 SPRAY BODY MODEL RD-04-S-P30 RAIN BIRD HE-VAN SERIES SPRAY NOZZLES 45-270 DEGREE 360 DEGREE 1.17-3.70 30 RAIN BIRD 3500 SERIES ROTORS MODEL 3504-PC-SAM 40-360 DEGREE .77-4.13 45 RAIN BIRD 3/4" 3RC QUICK COUPLER **EQUIPMENT** (1) 1-1/2" WATER METER - INSTALL PER CIVIL PLAN AND ALL LOCAL CODES (1) FEBCO 825Y-BV 1-1/2" REDUCED PRESSURE BACKFLOW PREVENTER (1) RAIN BIRD ESP-LXME 12-STATION CONTROLLER BASE + (2) ESP-LXMSM8 MODULES (28 AVAILABLE STATIONS TOTAL) (OPTIONAL ALTERNATIVE) RAIN BIRD ESP-12LXMEF BASE CONTROLLER WITH FLOW SMART MODULE (OPTIONAL OR IF REQUIRED) RAIN BIRD ESP-LXMM METAL CABINET AND LXMMPED METAL PEDESTAL RAIN BIRD WR2-RFC RAIN + FREEZE COMBO SENSOR RECEIVER-R SENSOR/TRANSMITTER-S HAMMOND 667 1-1/2" BRASS GATE VALVE ► OR APPROVED EQUAL RAIN BIRD 3/4" 3RC QUICK COUPLER NOTE: 1. ALL EMISSION POINTS TO BE LOCATED ON THE UPHILL SIDE OF PLANT MATERIAL ONE EMISSION POINTS TO BE LOCATED AT THE PLANT BALL, WITH THE ADDITIONAL POINTS WITHIN PLANT PIT PERIMETER. 2. A BACKFLOW SCREEN ENCLOSURE IS REQUIRED FOR THIS PROJECT. SPEC. TO BE GUARDSHACK AS MANUFACTURED BY BACKFLOW PREVENTION DEVICE ENCLOSURES INC. 602-788-5411 OR APPROVED EQUAL. FINISH: POWDER COAT COLOR: TBD. PROVIDE 4" THICK CONC. SLAB FOR ENCLOSURE FOUNDATION. 3. RAIN SENSOR (NOT ALLOWED ON FENCES): SELECT A MOUNTING LOCATION WHERE THE RAIN SENSOR WILL RECEIVE DIRECT RAINFALL. MAKE SURE THE SENSOR EXTENDS BEYOND

THE ROOF LINE, TREE LIMBS AND ANY OTHER

4. BACKFLOW TESTER MUST HAVE ASSE 5110

SPRINKLERS.

CERTIFICATION

OBSTRUCTIONS. INSTALL THE RAIN SENSOR IN AN AREA THAT RECEIVES AS MUCH RAIN AND SUNLIGHT AS THE LANDSCAPE. BE SURE TO MOUNT THE SENSOR ABOVE SPRAY FROM THE DRAWN BY: LAOR: PLOT DATE:

ISSUE DATE

DESIGNED BY:

SPENCER J. OKESON S.J.O. & I.K. DANIEL R. ERLANDSON 06/25/2021

ISSUE FOR PRICING/BIDDING:

ISSUE FOR PERMIT APPLICATION:

ISSUE FOR CONSTRUCTION:

	REVISION SCHEDULE						
NO:	DATE:	DESCRIPTION:					
B	08/14/2020	ADDENDUM B					
∕c\	09/25/2020	ADDENDUM C					

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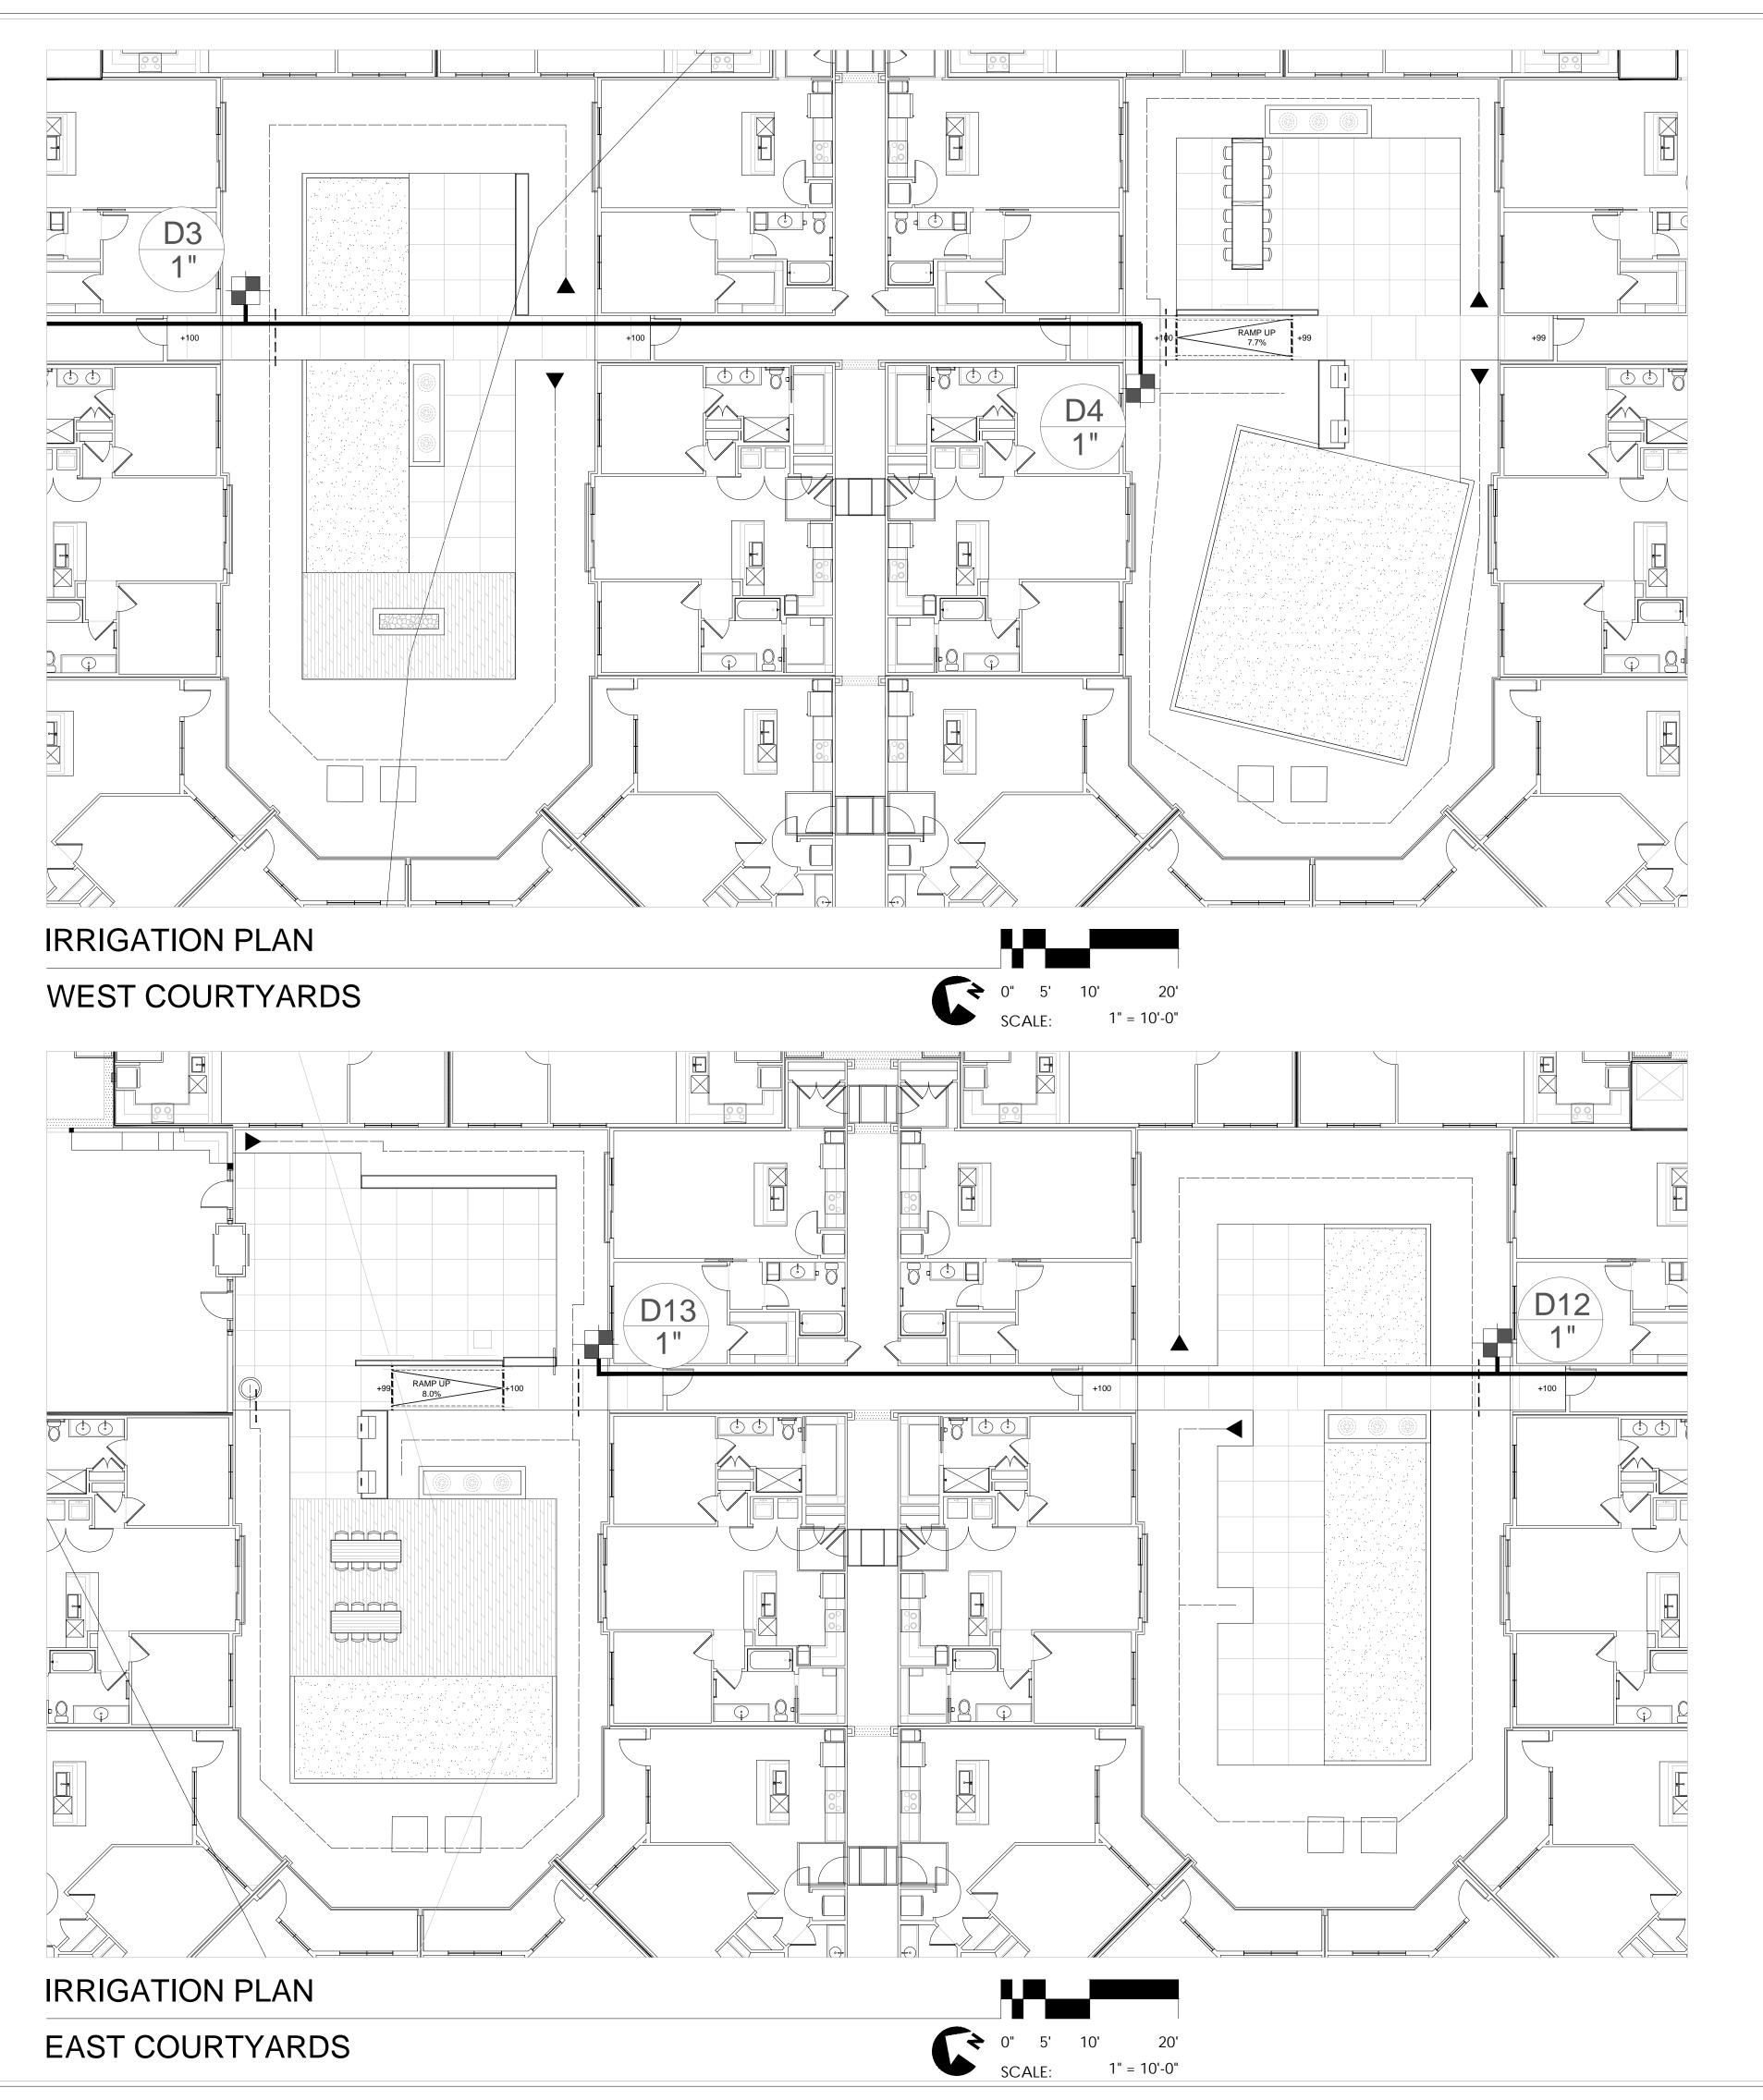
SHEET TITLE

IRRIGATION PLAN

SHEET NUMBER

SHEET INDIVIDER

3.03



IRRIGATION LEGEND

EMITTER SCHEDULE					
	PLANT TYPE	PLANT SIZE	GPH PER OUTLET		TOTAL GPH PER PLANT
	TREES	15 GAL.	2 GPH	3	6 GPH
	TREES	24" BOX	2 GPH	4	8 GPH
	TREES	36" BOX	2 GPH	5	10 GPH
	TREES	48" BOX	2 GPH	6	12 GPH
	SHRUBS/G C	5 GAI	1 GPH	2	2 GPH

SHRUBS/G.C. 1 GAL. 1 GPH PIPE LEGEND

1/2" 4.22 GPM CLASS 200 PVC —— 3/4" 8 GPM .5" MIN. LATERALS 1" 12 GPM SCHED. 40 PVC —— 1-1/2" 30 GPM 1" MIN. MAINLINE SCHED. 40 PVC ----2" MIN. SLEEVE D=DRIP VALVE SIZE

DRIP EQUIPMENT RAIN BIRD XCZ-100-PRB FLOW ZONE KIT RAIN BIRD VB-STD VALVE BOX PVC DRIP SYSTEM RAIN BIRD XQ DISTRIBUTION TUBING XB SERIES EMITTERS AND BUG CAPS (NOT SHOWN) EMITTERS PER TREE - EQUALLY SPACED RAIN BIRD EASY FLUSH CAP - MDCFCAP SPRAY HEADS RAIN BIRD 100-PEB-PRS-DIAL VALVE WITH

PRESSURE REGULATION VALVE BOX BY RAIN BIRD - OR APPROVE EQUAL

MFG. BODY TYPE RAIN BIRD RD1800 SPRAY BODY MODEL RD-04-S-P30 RAIN BIRD HE-VAN SERIES SPRAY NOZZLES 45-270 DEGREE .29-.278 30 1.17-3.70 30 360 DEGREE

RAIN BIRD 3500 SERIES ROTORS MODEL 3504-PC-SAM 40-360 DEGREE .77-4.13 45 RAIN BIRD 3/4" 3RC QUICK COUPLER

EQUIPMENT (1) 1-1/2" WATER METER - INSTALL PER CIVIL PLAN AND ALL LOCAL CODES

(1) FEBCO 825Y-BV 1-1/2" REDUCED PRESSURE BACKFLOW PREVENTER (1) RAIN BIRD ESP-LXME 12-STATION CONTROLLER BASE + (2) ESP-LXMSM8 MODULES (28 AVAILABLE STATIONS TOTAL)

(OPTIONAL ALTERNATIVE) RAIN BIRD ESP-12LXMEF BASE CONTROLLER WITH FLOW SMART MODULE (OPTIONAL OR IF REQUIRED) RAIN BIRD ESP-LXMM METAL CABINET AND LXMMPED METAL PEDESTAL

RAIN BIRD WR2-RFC RAIN + FREEZE COMBO

RECEIVER-R SENSOR/TRANSMITTER-S

HAMMOND 667 1-1/2" BRASS GATE VALVE ► OR APPROVED EQUAL RAIN BIRD 3/4" 3RC QUICK COUPLER

NOTE: 1. ALL EMISSION POINTS TO BE LOCATED ON THE UPHILL SIDE OF PLANT MATERIAL ONE EMISSION POINTS TO BE LOCATED AT THE

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FINISH: POWDER COAT COLOR: TBD. PROVIDE 4" THICK CONC. SLAB FOR ENCLOSURE FOUNDATION. 3. RAIN SENSOR (NOT ALLOWED ON FENCES): SELECT A MOUNTING LOCATION WHERE THE

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CERTIFICATION

DESIGNED BY: DRAWN BY:

NO:

SPENCER J. OKESON S.J.O. & I.K. DANIEL R. ERLANDSON

06/25/2021

PLOT DATE:

ISSUE FOR PRICING/BIDDING:

ISSUE FOR PERMIT APPLICATION:

09/25/2020

ISSUE FOR CONSTRUCTION: ISSUE DATE

REVISION SCHEDULE

DATE: DESCRIPTION: ADDENDUM B 08/14/2020

ADDENDUM C

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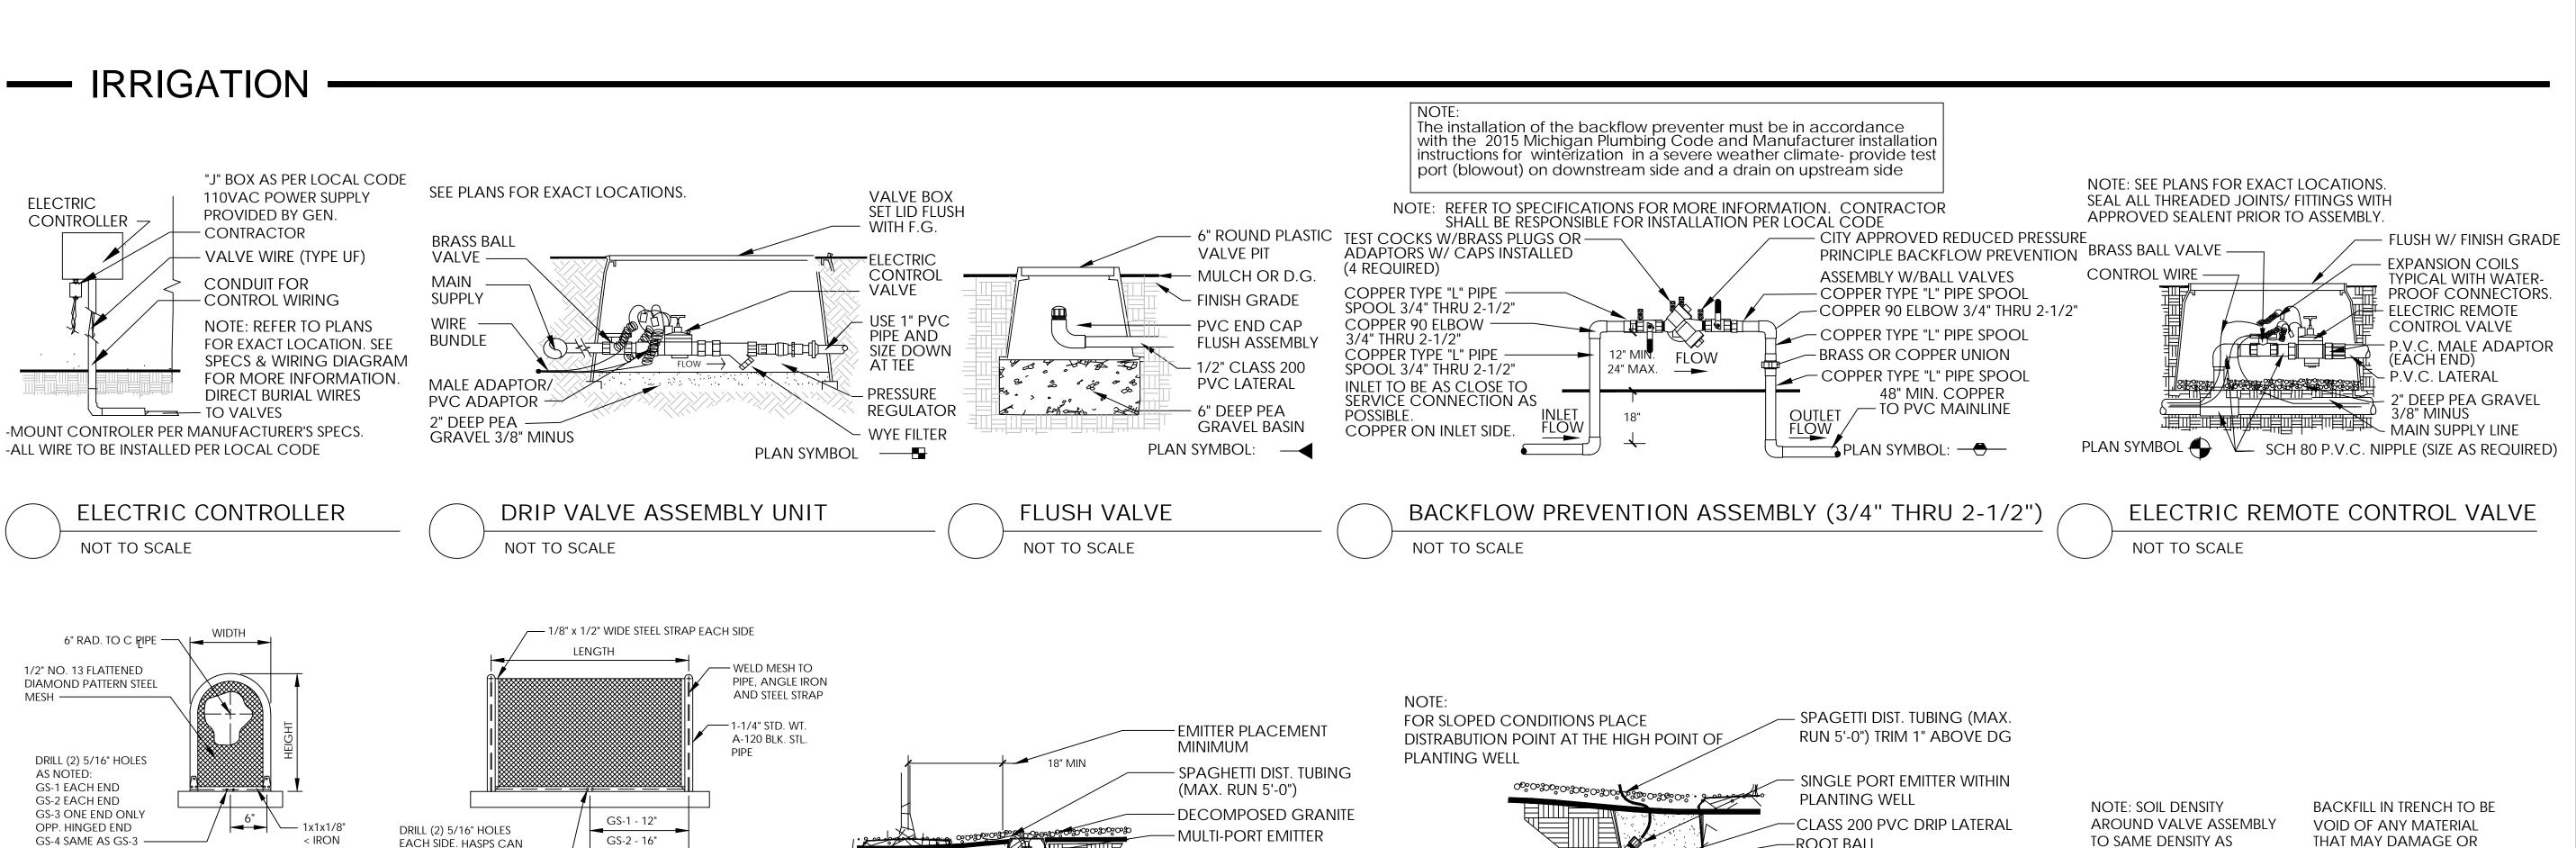
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CLIENT DTN MANAGEMENT 2502 LAKE LANSING RD SUITE C, LANSING, MI 48912

SHEET TITLE

IRRIGATION PLAN

SHEET NUMBER



-EMITTER PIT BOX

-PVC RISER PIPE

LATERAL (TYP).

MULTI-PORT EMITTER & SINGLE-PORT EMITTER

INSTALL A MINIMUM

BOWSMITH OR APPROVED EQUAL

DISTRIBUTOR

FLOW

EQUALLY SPACED AROUND

OF (1) MULTI-PORT

EMITTERS PER TREE-

DRIPLINE OF TREE

CANOPY TYPICAL

OPEN ADDITIONAL

PORTS AND INSTALL

TUBING TO PROVIDE

AS TREE MATURES(TYP).

ADEQUATE WATER

SPAGHETTI DISTRIBUTION

PVC DRIP

FLUSH VALVE/END CAP

MULTI-PORT EMITTER

SCH 40 PVC FITTING

SPAGHETTI DIST. TUBING (MAX. RUN 5'-0")

(TEE OR ELBOW)

- CLASS 200(MIN) PVC LATERAL

-ROOT BALL

PLANT WELL

DRIP EMITTER

- FINSH GRADE

— 1/2" x 12" PVC

P.V.C. LATERAL

SCH. 80 NIPPLE

– P.V.C. ELL OR TEE

UNDISTURBED SOIL.

P.V.C. -

24" MIN

LATERAL

- IMPAIR PIPES OR WIRING

MIN. 4" HOR. CLEARANCE

- 4" CLR. OUT TO OUT V

BUNDLE AND TAPE ALL

PIPE AND WIRING IN

FOR CONTRACTION

TRENCHES TO ALLOW

- 4-6" PVC SCHED. 40

— WIRING AT 10' O.C.

— P.V.C. MAINLINE

NOTE: SNAKE

SLEEVE

TRENCHING

NOT TO SCALE

- BETWEEN PIPES

EACH SIDE. HASPS CAN

NOTES:

AFTER WELDING, ENTIRE UNIT SHALL BE SANDBLASTED, AND

PROCESSED WITH IRON PHOSPHATE PRETREATMENT.

BE FUSION BONDED EPOXY - MORTON PU94175 (DESERT

HIGH GLOSS - SMOOTH FIELD 180 LB. IMPACT COATING.

ELECTROSTATIC APPLICATION OF POWDER SHALL

ALL BOLTS FOR HINGES AND HASP SHALL BE ZINC

CLEARANCE SHALL BE A MINIMUM OF 4" (TOP &

LOCKABLE AND MOUNTED ON CONCRETE PAD.

"GUARDSHACK" SECURITY CAGE

SIDES). SHOP DRAWINGS TO BE SUBMITTED TO

CITY FOR APPROVAL. METAL CAGE SHALL BE

NOT TO SCALE

CONTRACTOR SHALL PROVIDE AND INSTALL

PROTECTIVE CAGE, COLOR SHALL BE TAN.

TAN) OR APPROVED EQUAL

PLATED TAMPER PROOF.

BE LOCATED ON SIDES OR

ENDS AND SECURED WITH

GS-1 12" W x 24" H x 24"L

GS-2 12" W x 24" H x 32"L

GS-3 12" W x 24" H x 42"L

GS-4 12" W x 30" H x 48"L

TAMPER PROOF BOLTS

→

3/8" x 2" SLOT

FOR EYE BOLT

GS-3 - 21"

GS-4 - 24"

LIFT OFF UNIT

LIFT OFF UNIT

HINGED UNIT

HINGED UNIT

2 REQUIRED FOR GS-1 & GS-2

1 REQUIRED FOR GS-3 & GS-4

ELEVATION

PLAN

NOT TO SCALE

STANDARD SIZES - CENTERLINE DIMENSIONS

— DRILL (2) 1/4" HOLES

HASP DETAIL

3901001552 06/25/2021

SPENCER J. OKESON

DANIEL R. ERLANDSON

DESCRIPTION:

ADDENDUM B

ADDENDUM C

S.J.O. & I.K.

06/25/2021

DESIGNED BY: DRAWN BY:

PLOT DATE:

07/02/2019

01/22/2021

ISSUE DATE

NO:

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08/14/2020

09/25/2020

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of all fees otherwise due Humphreys & Partners

depicted in sealed construction drawings is

limitation the construction of any landscape

LAOR:


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CLIENT DTN MANAGEMENT 2502 LAKE LANSING RD SUITE C. LANSING, MI 48912

SHEET TITLE

GENERAL IRRIGATION DETAILS

SHEET NUMBER

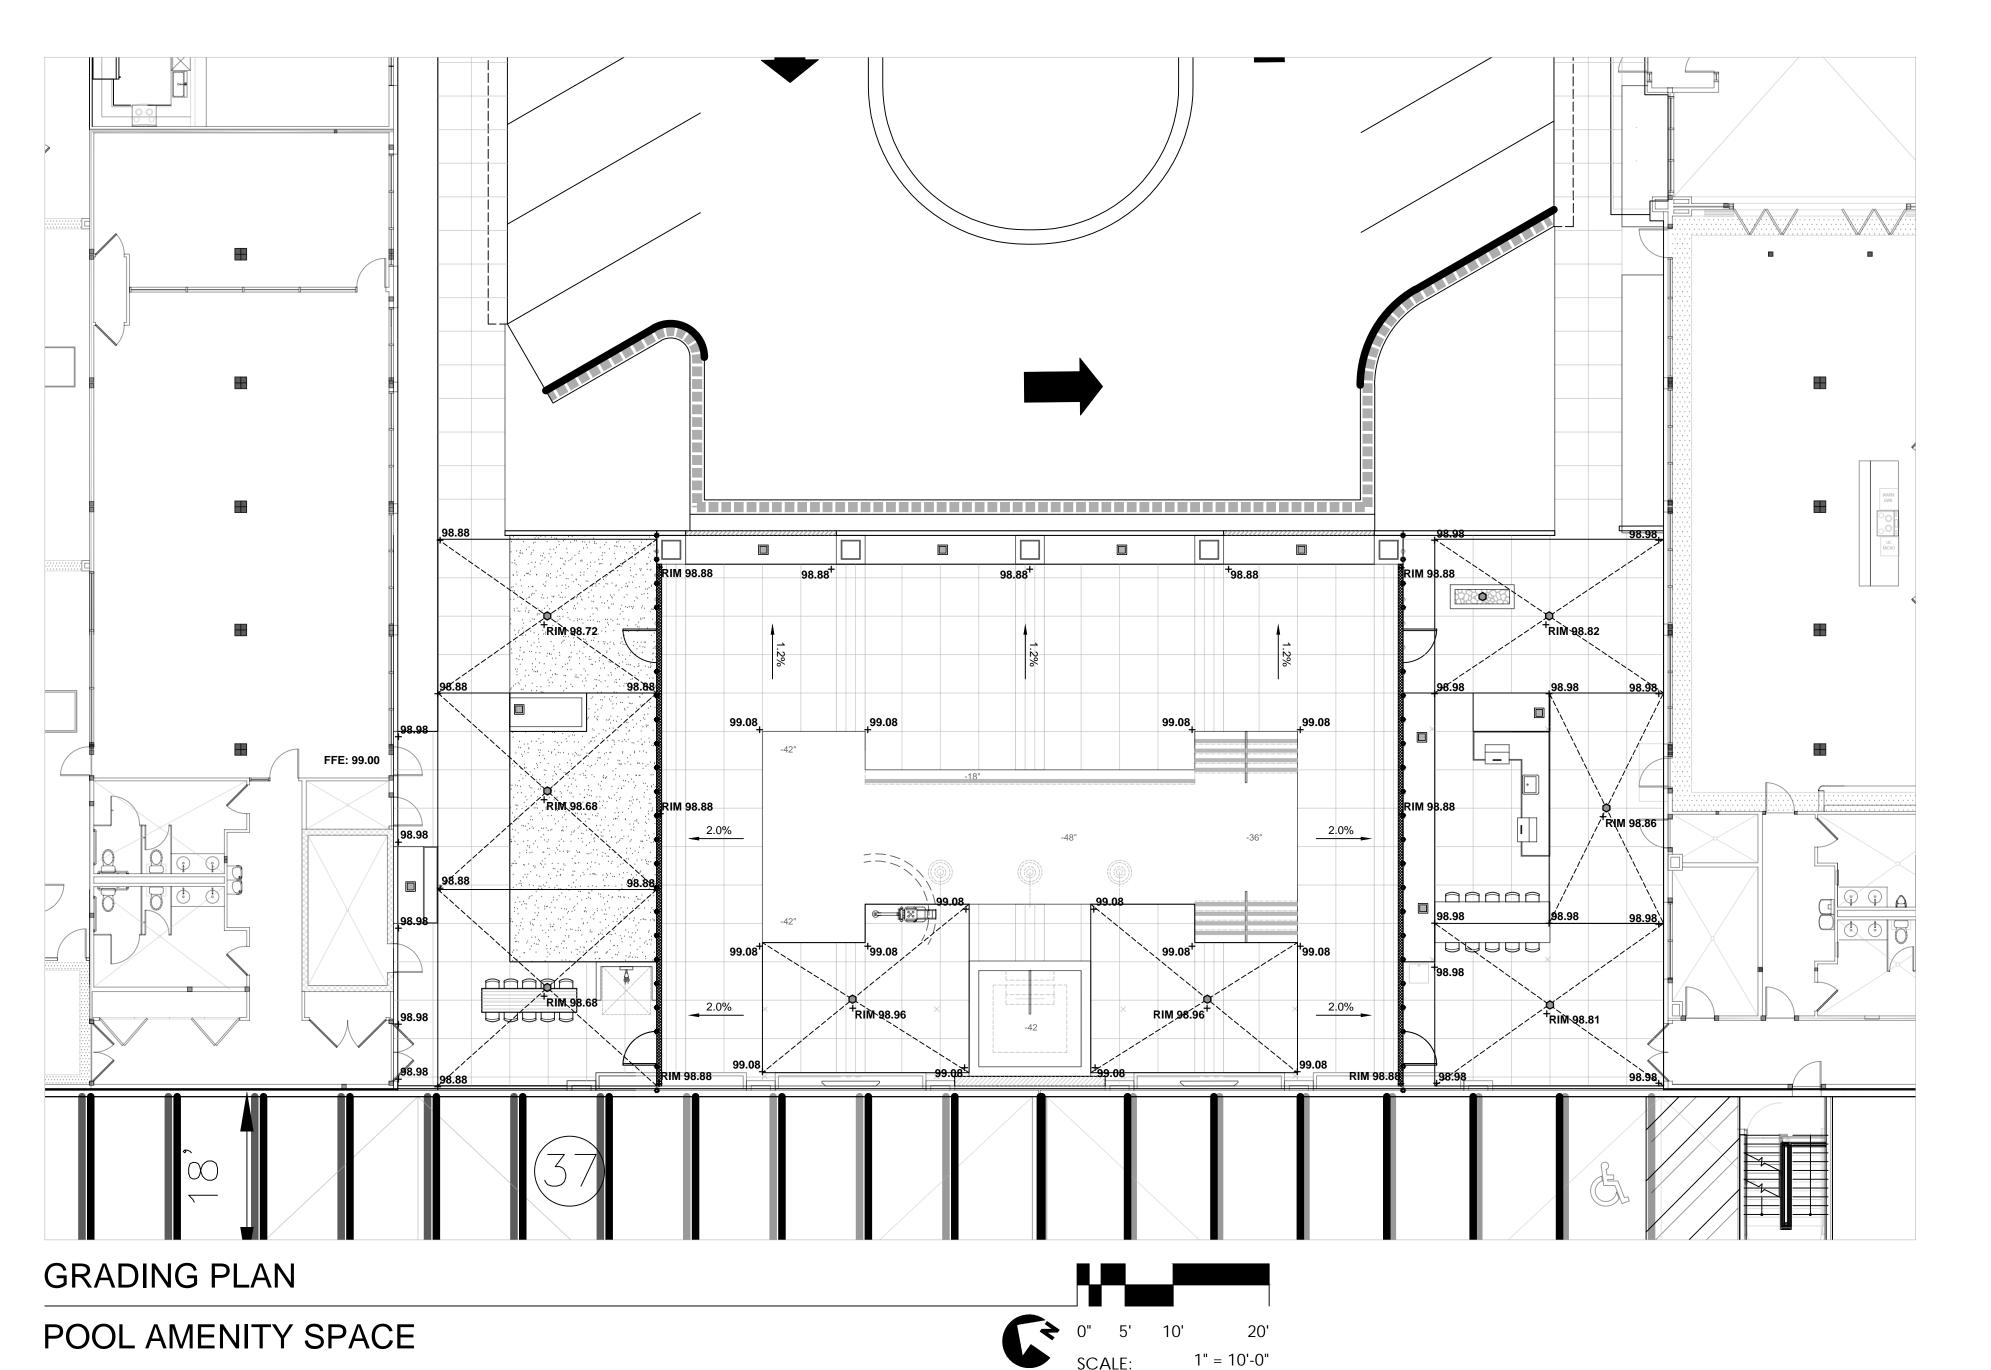

DRAINAGE LEGEND - POOL AMENITY SPACE

DRAIN INLETS (BY: RAINBIRD.COM) TYPE: 9" SQUARE BASIN | MODEL #: DB9S2 9" SQUARE FLAT GRATE (GREEN)

QTY: 09

7" DIAMETER, MEDIUM-DUTY DECK DRAIN W/ QTY: 09 HEEL-PROOF GRATE, POLISHED BRONZE OR NICKEL TOP (BY: WWW.ZURN.COM) PRODUCT #: Z507 - OR APPROVED EQUAL NOTE: LOCATE DRAIN UNDERNEATH POT DRAINAGE OUTLETS

6" WIDE, FIBER REINFORCED POLYMER TRENCH DRAIN 110 L.F. SYSTEM, WITH DECORATIVE GRATE (P6-AWG)

(BY: WWW.ZURN.COM) PRODUCT #: Z806 - OR APPROVED EQUAL

FFE - FINISHED FLOOR ELEVATION

HP - HIGH POINT

TOW - TOP OF WALL

RIM - ELEVATION AT DRAIN RIM

NOTES:

-MAXIMUM CROSS SLOPE ALLOWED: 2% -DRAINS TO BE SET FLUSH WITH DECK OR STRUCTURAL SLAB (WHERE APPLICABLE) -REFER TO MEP DRAWINGS FOR STRUCTURAL SLAB PENETRATIONS

ISSUE DATE

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DRAWN BY:

PLOT DATE:

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08/14/2020	ADDENDUM B					
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SPENCER J. OKESON


DANIEL R. ERLANDSON

S.J.O. & I.K.

06/25/2021

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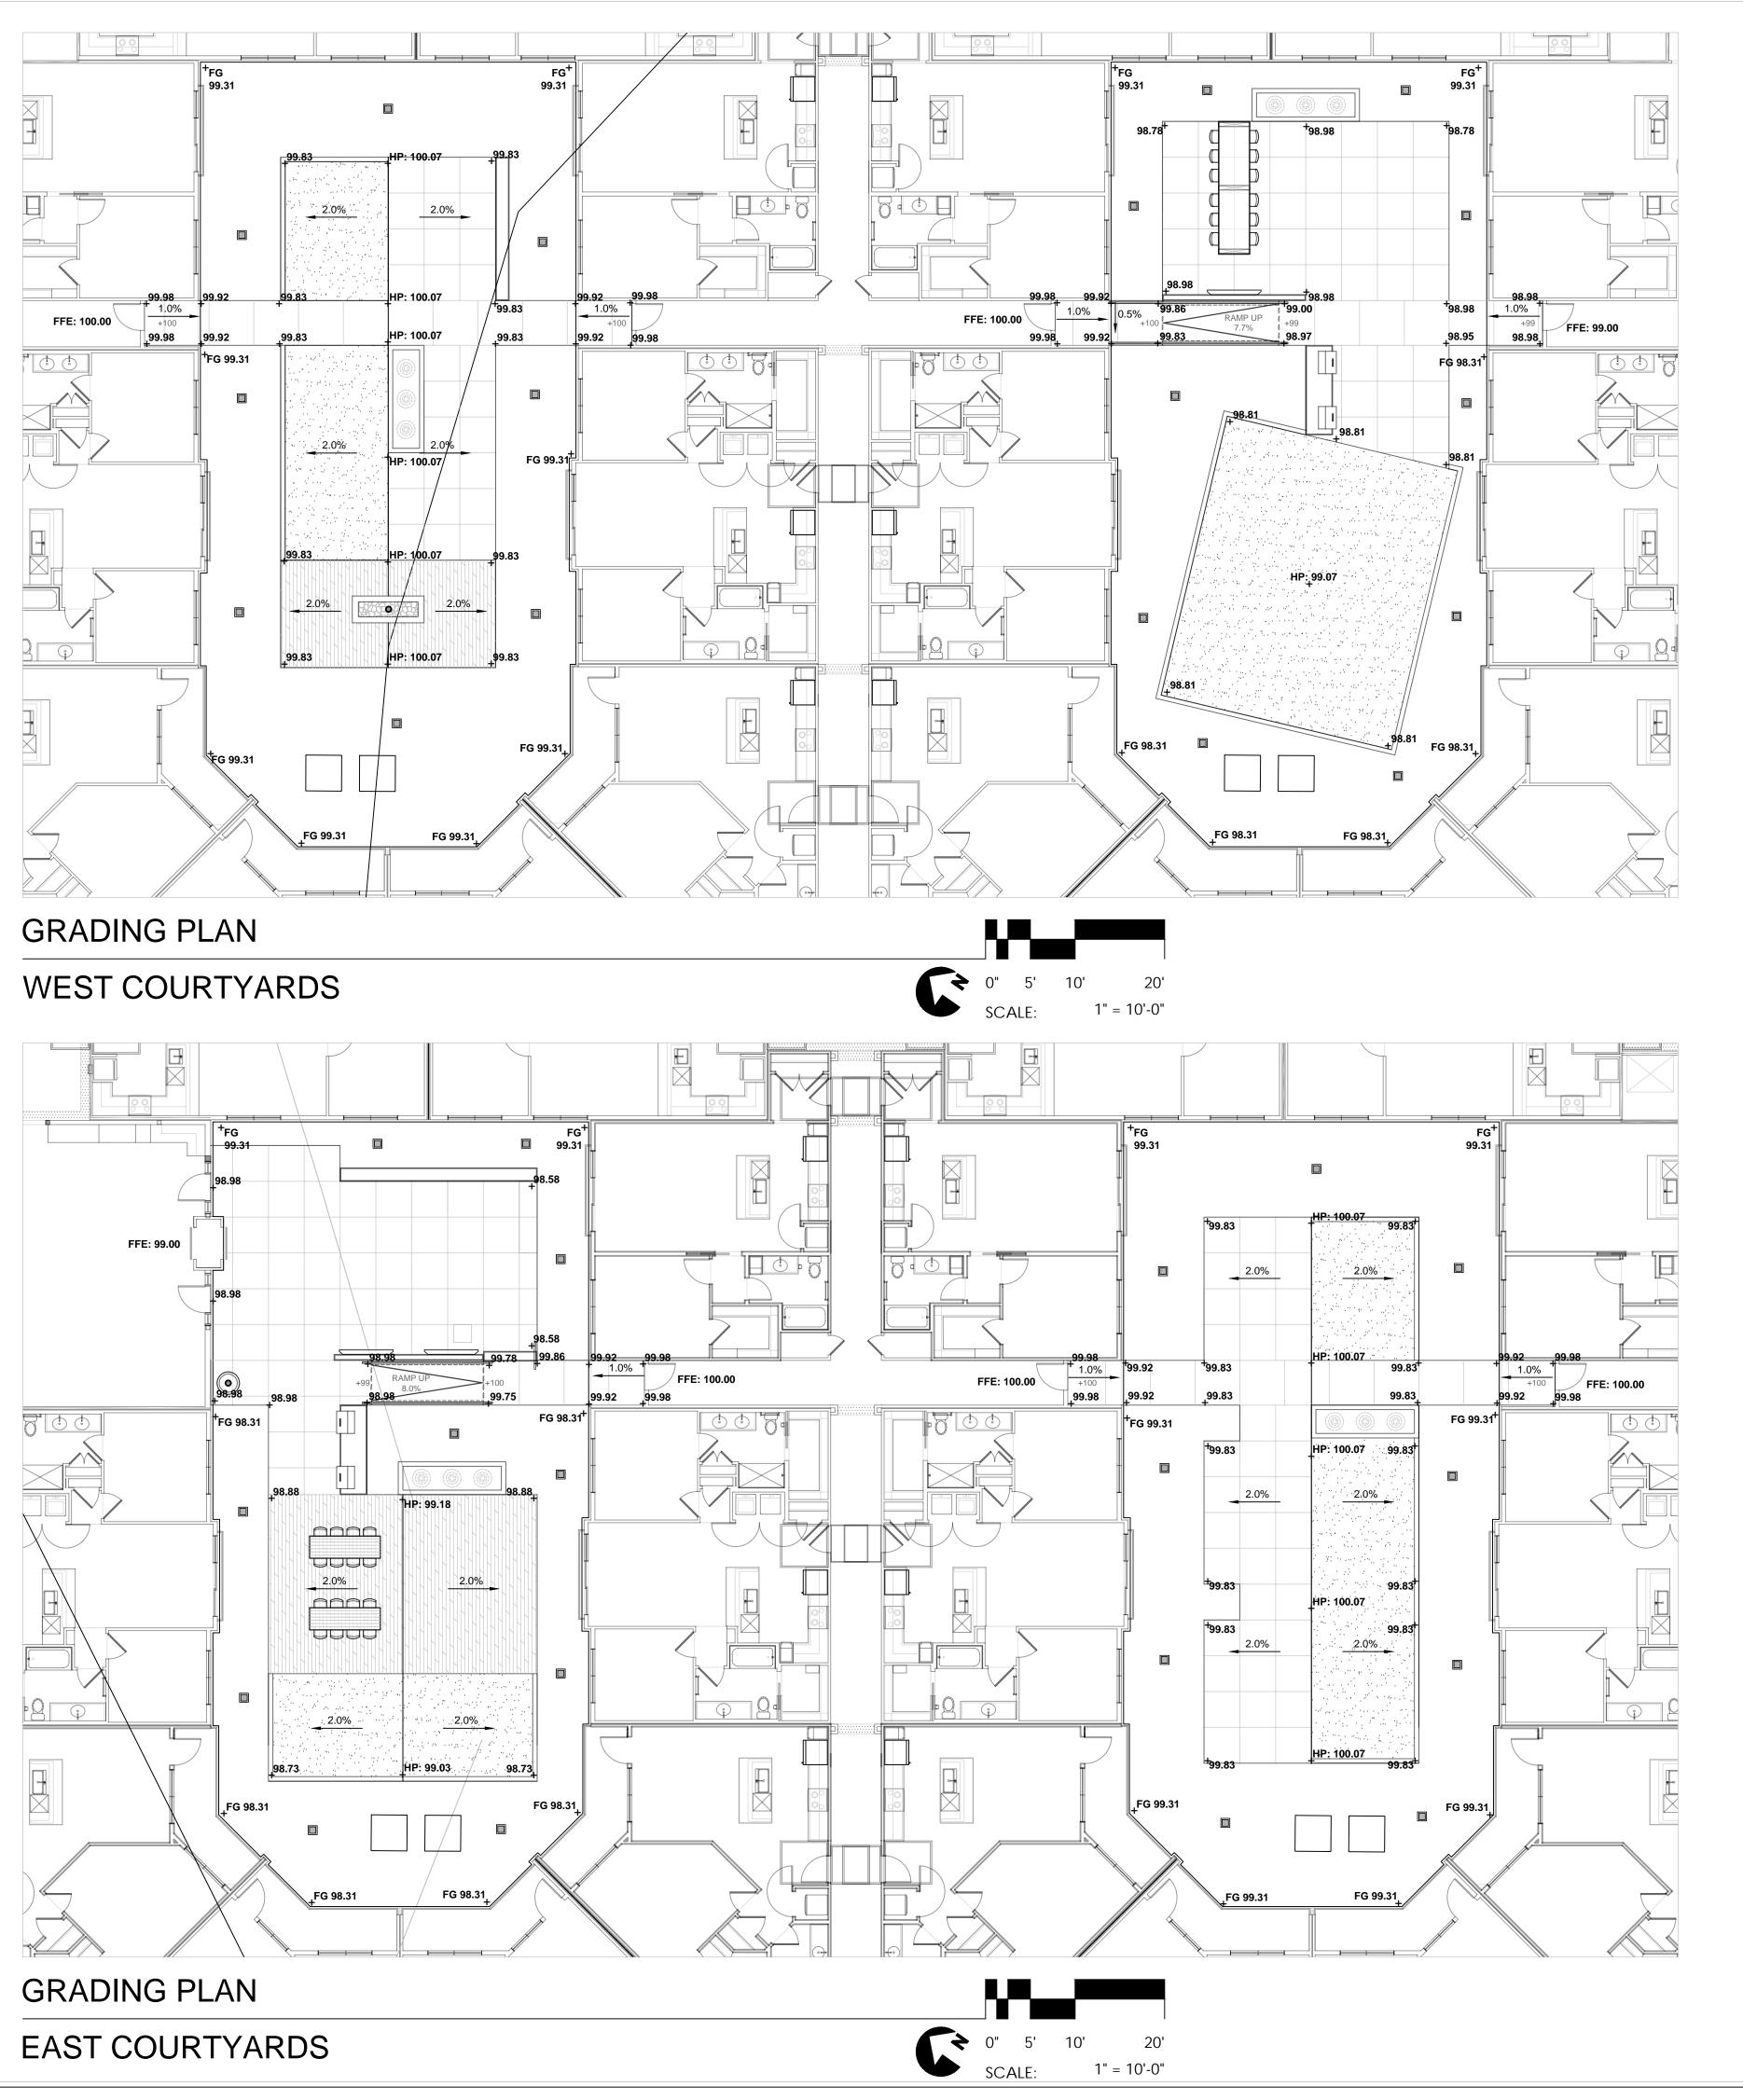
SHEET TITLE

GRADING PLAN

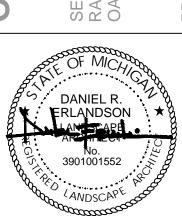SHEET NUMBER

SCALE: AS INDICATED CITY JOB #: JSP18-0010

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DRAINAGE LEGEND - WEST COURTYARDS

DRAIN INLETS (BY: RAINBIRD.COM) TYPE: 9" SQUARE BASIN | MODEL #: DB9S2

9" SQUARE FLAT GRATE (GREEN)

7" DIAMETER, MEDIUM-DUTY DECK DRAIN W/ HEEL-PROOF GRATE, POLISHED BRONZE OR NICKEL TOP (BY: WWW.ZURN.COM) PRODUCT #: Z507 - OR APPROVED EQUAL NOTE: LOCATE DRAIN UNDERNEATH POT DRAINAGE OUTLETS

FFE - FINISHED FLOOR ELEVATION

HP - HIGH POINT

TOW - TOP OF WALL

RIM - ELEVATION AT DRAIN RIM

-MAXIMUM CROSS SLOPE ALLOWED: 2% -DRAINS TO BE SET FLUSH WITH DECK OR STRUCTURAL SLAB (WHERE APPLICABLE) -REFER TO MEP DRAWINGS FOR STRUCTURAL **SLAB PENETRATIONS**

DRAINAGE LEGEND - EAST COURTYARDS

DRAIN INLETS (BY: RAINBIRD.COM) TYPE: 9" SQUARE BASIN | MODEL #: DB9S2 9" SQUARE FLAT GRATE (GREEN)

QTY: 19

QTY: 01

QTY: 22

QTY: 01

7" DIAMETER, MEDIUM-DUTY DECK DRAIN W/ HEEL-PROOF GRATE, POLISHED BRONZE OR NICKEL TOP (BY: WWW.ZURN.COM) PRODUCT #: Z507 - OR APPROVED EQUAL NOTE: LOCATE DRAIN UNDERNEATH POT DRAINAGE OUTLETS

FFE - FINISHED FLOOR ELEVATION

HP - HIGH POINT

TOW - TOP OF WALL

RIM - ELEVATION AT DRAIN RIM

-MAXIMUM CROSS SLOPE ALLOWED: 2% -DRAINS TO BE SET FLUSH WITH DECK OR STRUCTURAL SLAB (WHERE APPLICABLE) -REFER TO MEP DRAWINGS FOR STRUCTURAL SLAB PENETRATIONS

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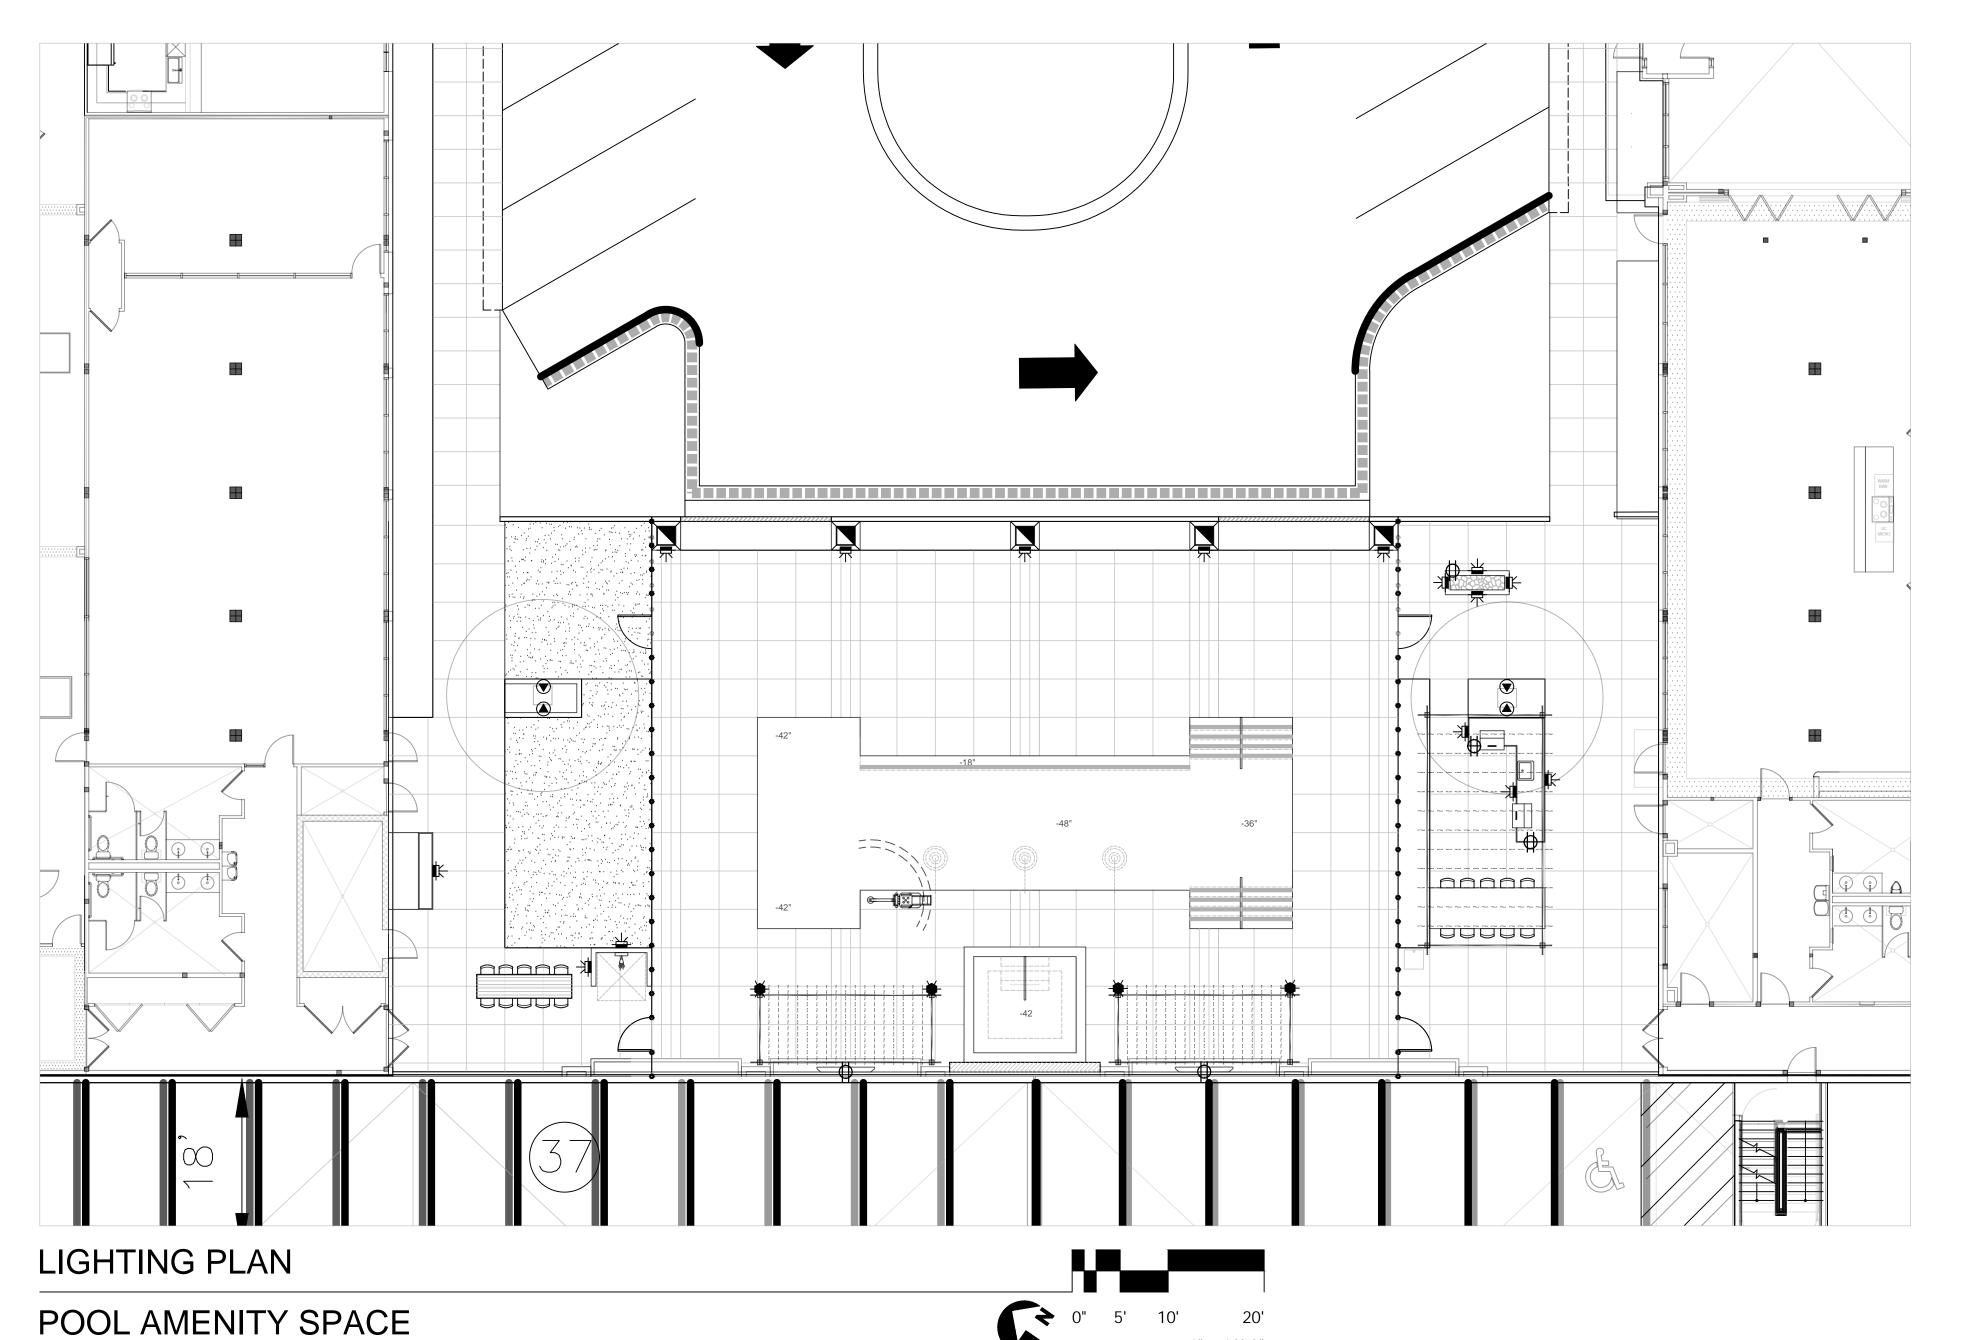
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SHEET TITLE

GRADING PLAN

SHEET NUMBER



1" = 10'-0"

LOW VOLTAGE LIGHTING - POOL COURTYARD FIXTURE TYPE QUANTITY DESCRIPTION BERNINI ILLUMINATED CUBES LIGHT BOX QTY: 05 BY: PLANTERS UNLIMITED | SIZE: 20: x 20" x 18" MODEL: MU-35 (MACCHIAULTIMO) QTY: 04 UPLIGHT COLOR: BLACK (BY: FXL.COM) WALL LIGHT MODEL: FX LOUVER MASSIMO QTY: 15 (BY: FXL.COM) PRODUCT #: LM-ZD-2LED-BLACK RECESSED RECESSED FLOOR LIGHT (IN-GRADE) QTY: 04 (BY: KIMLIGHTING.COM) FLOOR LIGHT PRODUCT #: LVT83FF-WW-12L5KUV-SR-RCA83 NOTE: REFERENCE ELECTRICAL DRAWINGS FOR TRANSFORMER, JBOX/RECEPTACLE, AND ALL OTHER EQUIPMENT LOCATIONS ELECTRICAL LEGEND FIXTURE TYPE DESCRIPTION QUANTITY MOUNTED IN-WALL (REFER TO ELECTRICAL QTY: 05 JUNCTION BOX PLAN FOR HEIGHTS) **GENERAL NOTES:** -ALL LIGHTING TO BE LOW VOLTAGE WITH THE EXCEPTION OF BOLLARDS AND RECESSED FLOOR LIGHTS. REFERENCE ELECTRICAL PLANS FOR BOLLARD ELECTRICAL INFORMATION. -LOW VOLTAGE TRANSFORMER TO PLUG INTO EXISTING ELECTRICAL OUTLET. REFERENCE ELECTRICAL DRAWINGS FOR LOCATION. -ALL DATE PALMS (IF APPLICABLE) TO RECEIVE (1) TREE RING FIXED TO

TRUNK WITH (2) DOWN-LIGHTS AND (2) UPLIGHTS ON EACH COLLAR

DESIGNED BY: DRAWN BY:

PLOT DATE:

SPENCER J. OKESON S.J.O. & I.K. DANIEL R. ERLANDSON 06/25/2021

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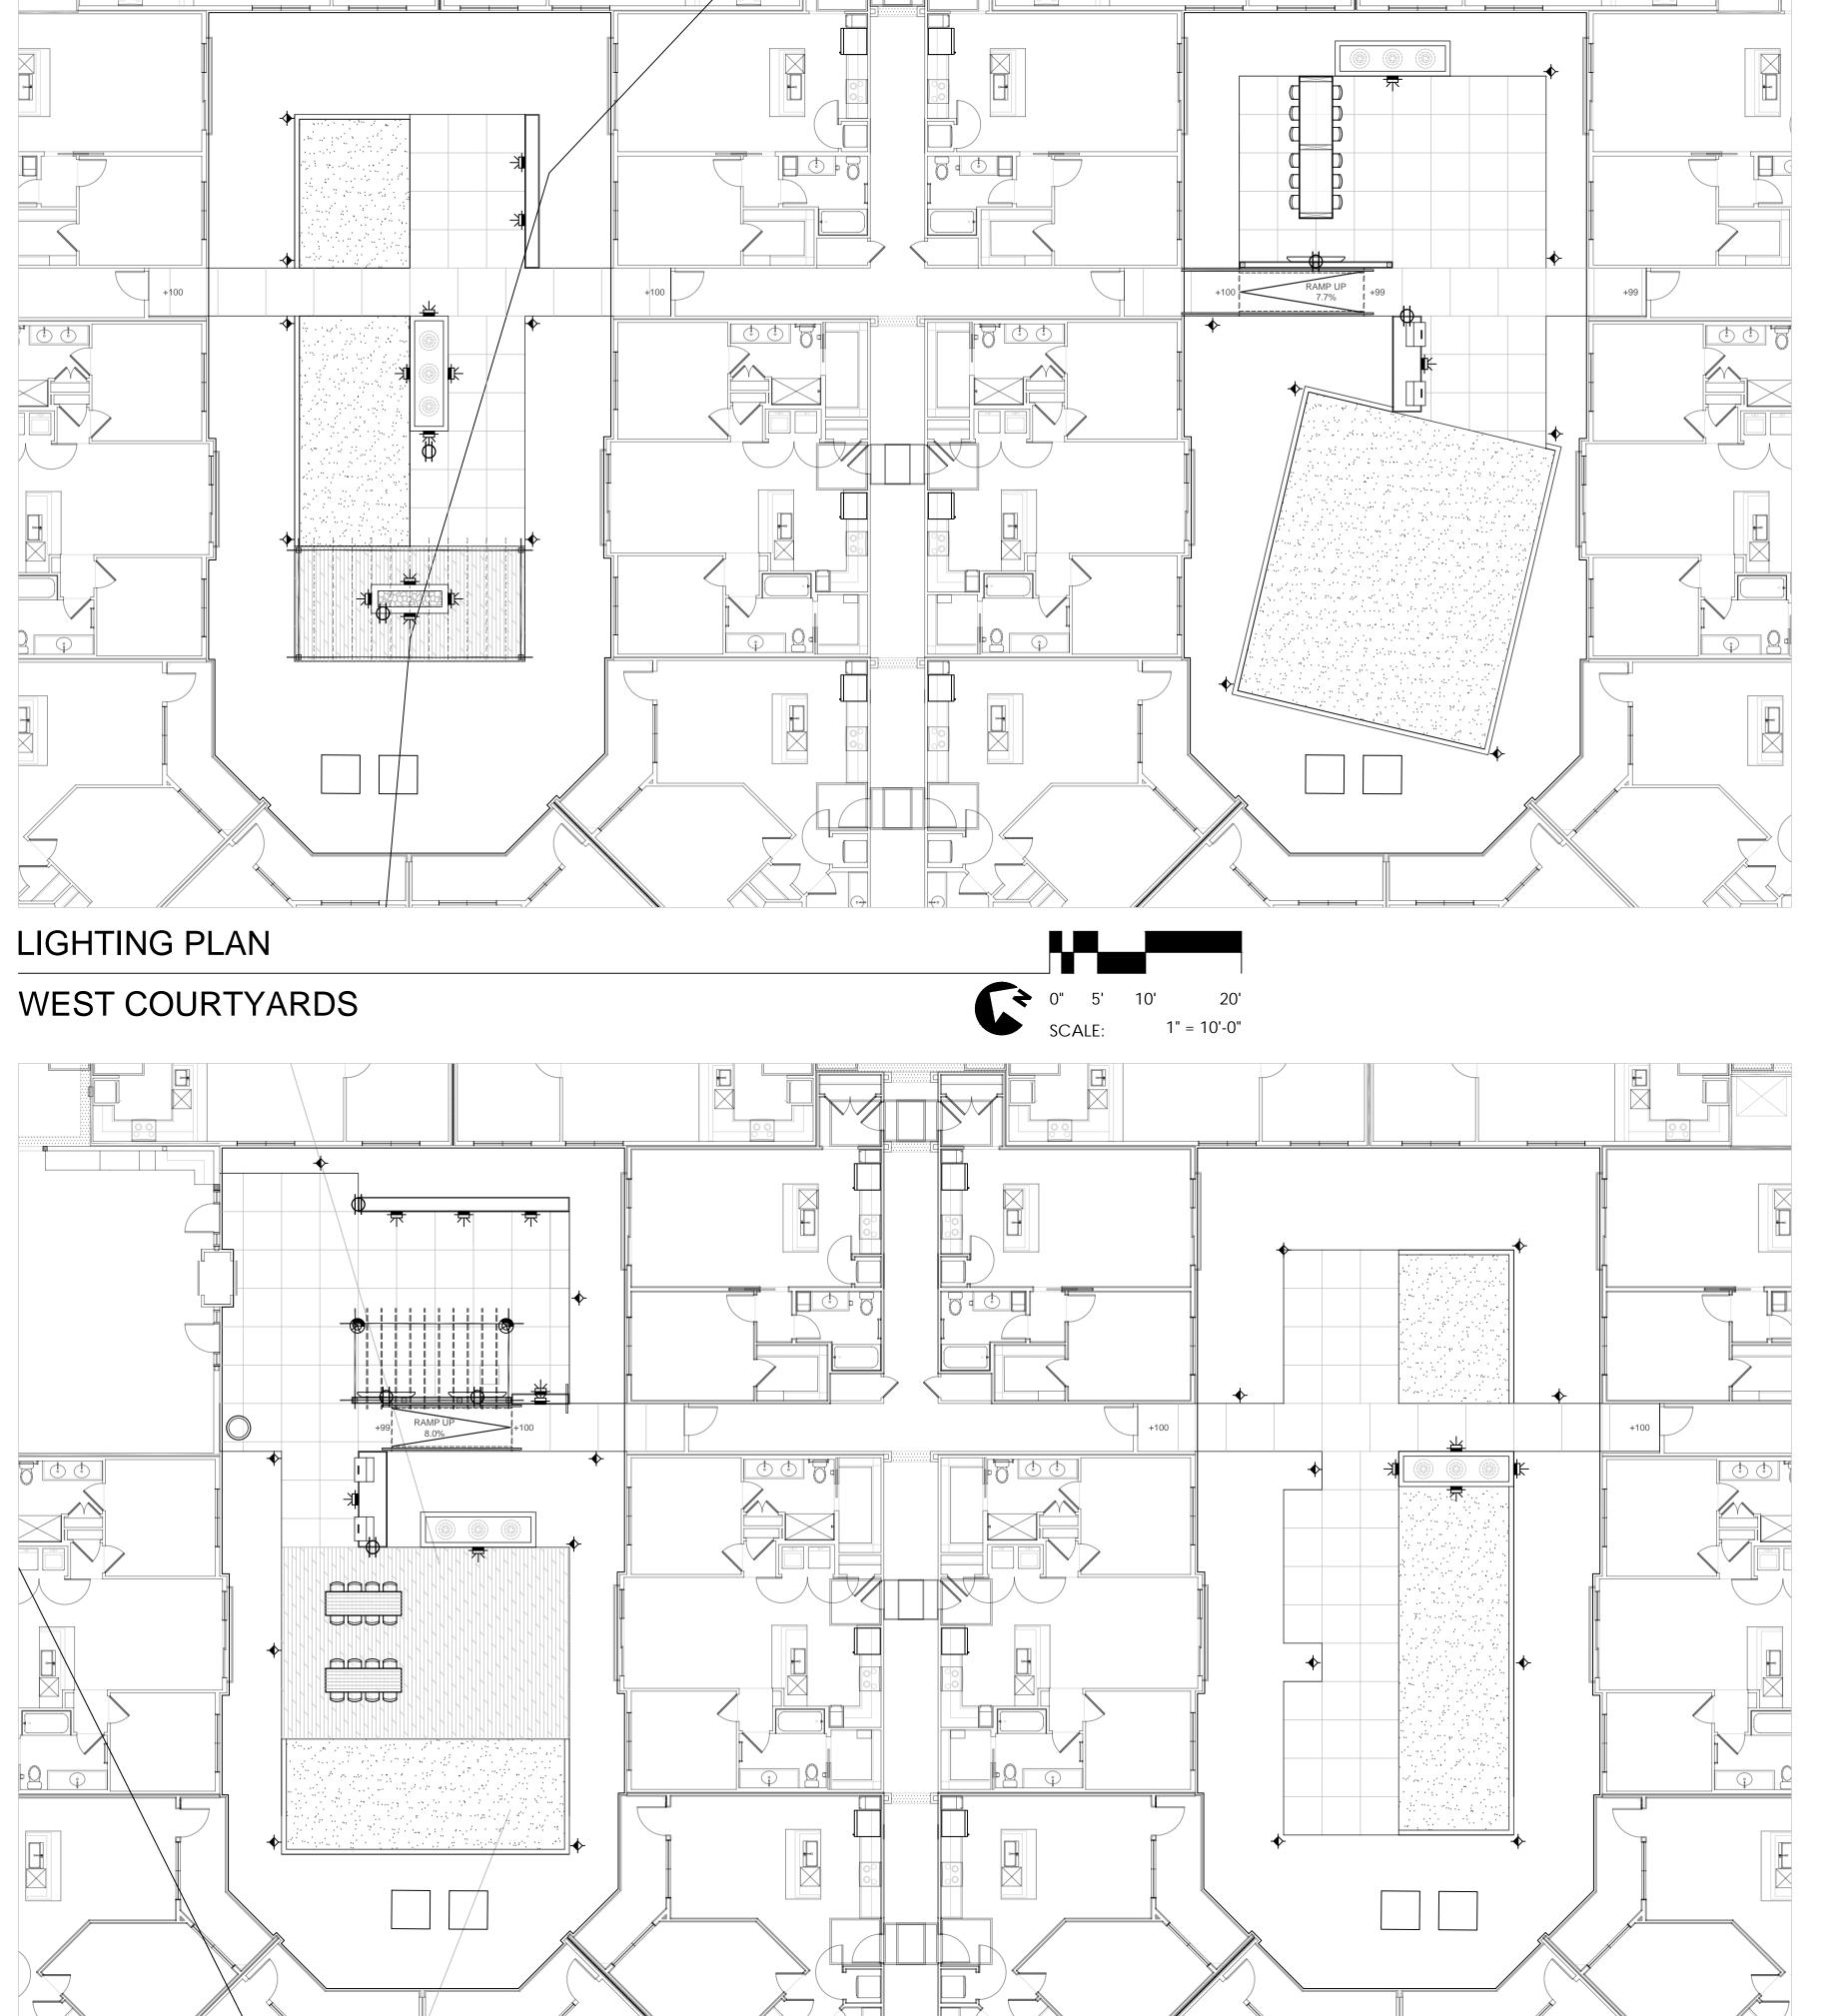
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CLIENT DTN MANAGEMENT 2502 LAKE LANSING RD SUITE C, LANSING, MI 48912

SHEET TITLE

LIGHTING PLAN

SHEET NUMBER



1" = 10'-0"

LIGHTING PLAN

EAST COURTYARDS

LOW VOLTAGE LIGHTING - WEST COURTYARDS DESCRIPTION QUANTITY — WALL LIGHT QTY: 12 MODEL: FX LOUVER MASSIMO (BY: FXL.COM) PRODUCT #: LM-ZD-2LED-BLACK PATH LIGHT QTY: 13 aPILLAR (BY: HOLM LIGHTING) PRODUCT #: aPLR-3LED-FB

NOTE: REFERENCE ELECTRICAL DRAWINGS FOR TRANSFORMER, JBOX/RECEPTACLE, AND ALL OTHER EQUIPMENT LOCATIONS

ELECTRICAL LEGEND

FIXTURE TYPE DESCRIPTION QUANTITY QTY: 04 ELECTRICAL MOUNTED IN-WALL (REFER TO JUNCTION BOX PLAN FOR HEIGHTS)

GENERAL NOTES:

-ALL LIGHTING TO BE LOW VOLTAGE WITH THE EXCEPTION OF BOLLARDS AND RECESSED FLOOR LIGHTS. REFERENCE ELECTRICAL PLANS FOR BOLLARD ELECTRICAL INFORMATION.

-LOW VOLTAGE TRANSFORMER TO PLUG INTO EXISTING ELECTRICAL OUTLET. REFERENCE ELECTRICAL DRAWINGS FOR LOCATION. -ALL DATE PALMS (IF APPLICABLE) TO RECEIVE (1) TREE RING FIXED TO TRUNK WITH (2) DOWN-LIGHTS AND (2) UPLIGHTS ON EACH COLLAR

LOW VOLTAGE LIGHTING - EAST COURTYARDS

QUANTITY DESCRIPTION DOWN-LIGHTS MODEL: MU-35 (MACCHIAULTIMO) QTY: 02 (SHADE STRUCTURE) COLOR: BLACK (BY: FXL.COM) PATH LIGHT aPILLAR (BY: HOLM LIGHTING) QTY: 17 PRODUCT #: aPLR-3LED-FB MODEL: FX LOUVER MASSIMO - WALL LIGHT QTY: 11 (BY: FXL.COM)

NOTE: REFERENCE ELECTRICAL DRAWINGS FOR TRANSFORMER, JBOX/RECEPTACLE, AND ALL OTHER EQUIPMENT LOCATIONS

FIXTURE TYPE

ELECTRICAL LEGEND QUANTITY DESCRIPTION ELECTRICAL MOUNTED IN-WALL (REFER TO QTY: 04 JUNCTION BOX PLAN FOR HEIGHTS)

PRODUCT #: LM-ZD-2LED-BLACK

GENERAL NOTES:

-ALL LIGHTING TO BE LOW VOLTAGE WITH THE EXCEPTION OF BOLLARDS AND RECESSED FLOOR LIGHTS. REFERENCE ELECTRICAL PLANS FOR BOLLARD ELECTRICAL INFORMATION.

-LOW VOLTAGE TRANSFORMER TO PLUG INTO EXISTING ELECTRICAL OUTLET. REFERENCE ELECTRICAL DRAWINGS FOR LOCATION. -ALL DATE PALMS (IF APPLICABLE) TO RECEIVE (1) TREE RING FIXED TO TRUNK WITH (2) DOWN-LIGHTS AND (2) UPLIGHTS ON EACH COLLAR

DESIGNED BY: DRAWN BY:

NO:

SPENCER J. OKESON S.J.O. & I.K. DANIEL R. ERLANDSON

06/25/2021

PLOT DATE: ISSUE FOR PRICING/BIDDING:

ISSUE FOR PERMIT APPLICATION:

ISSUE FOR CONSTRUCTION: ISSUE DATE

REVISION SCHEDULE

DATE: DESCRIPTION: ADDENDUM B 08/14/2020 ADDENDUM C 09/25/2020


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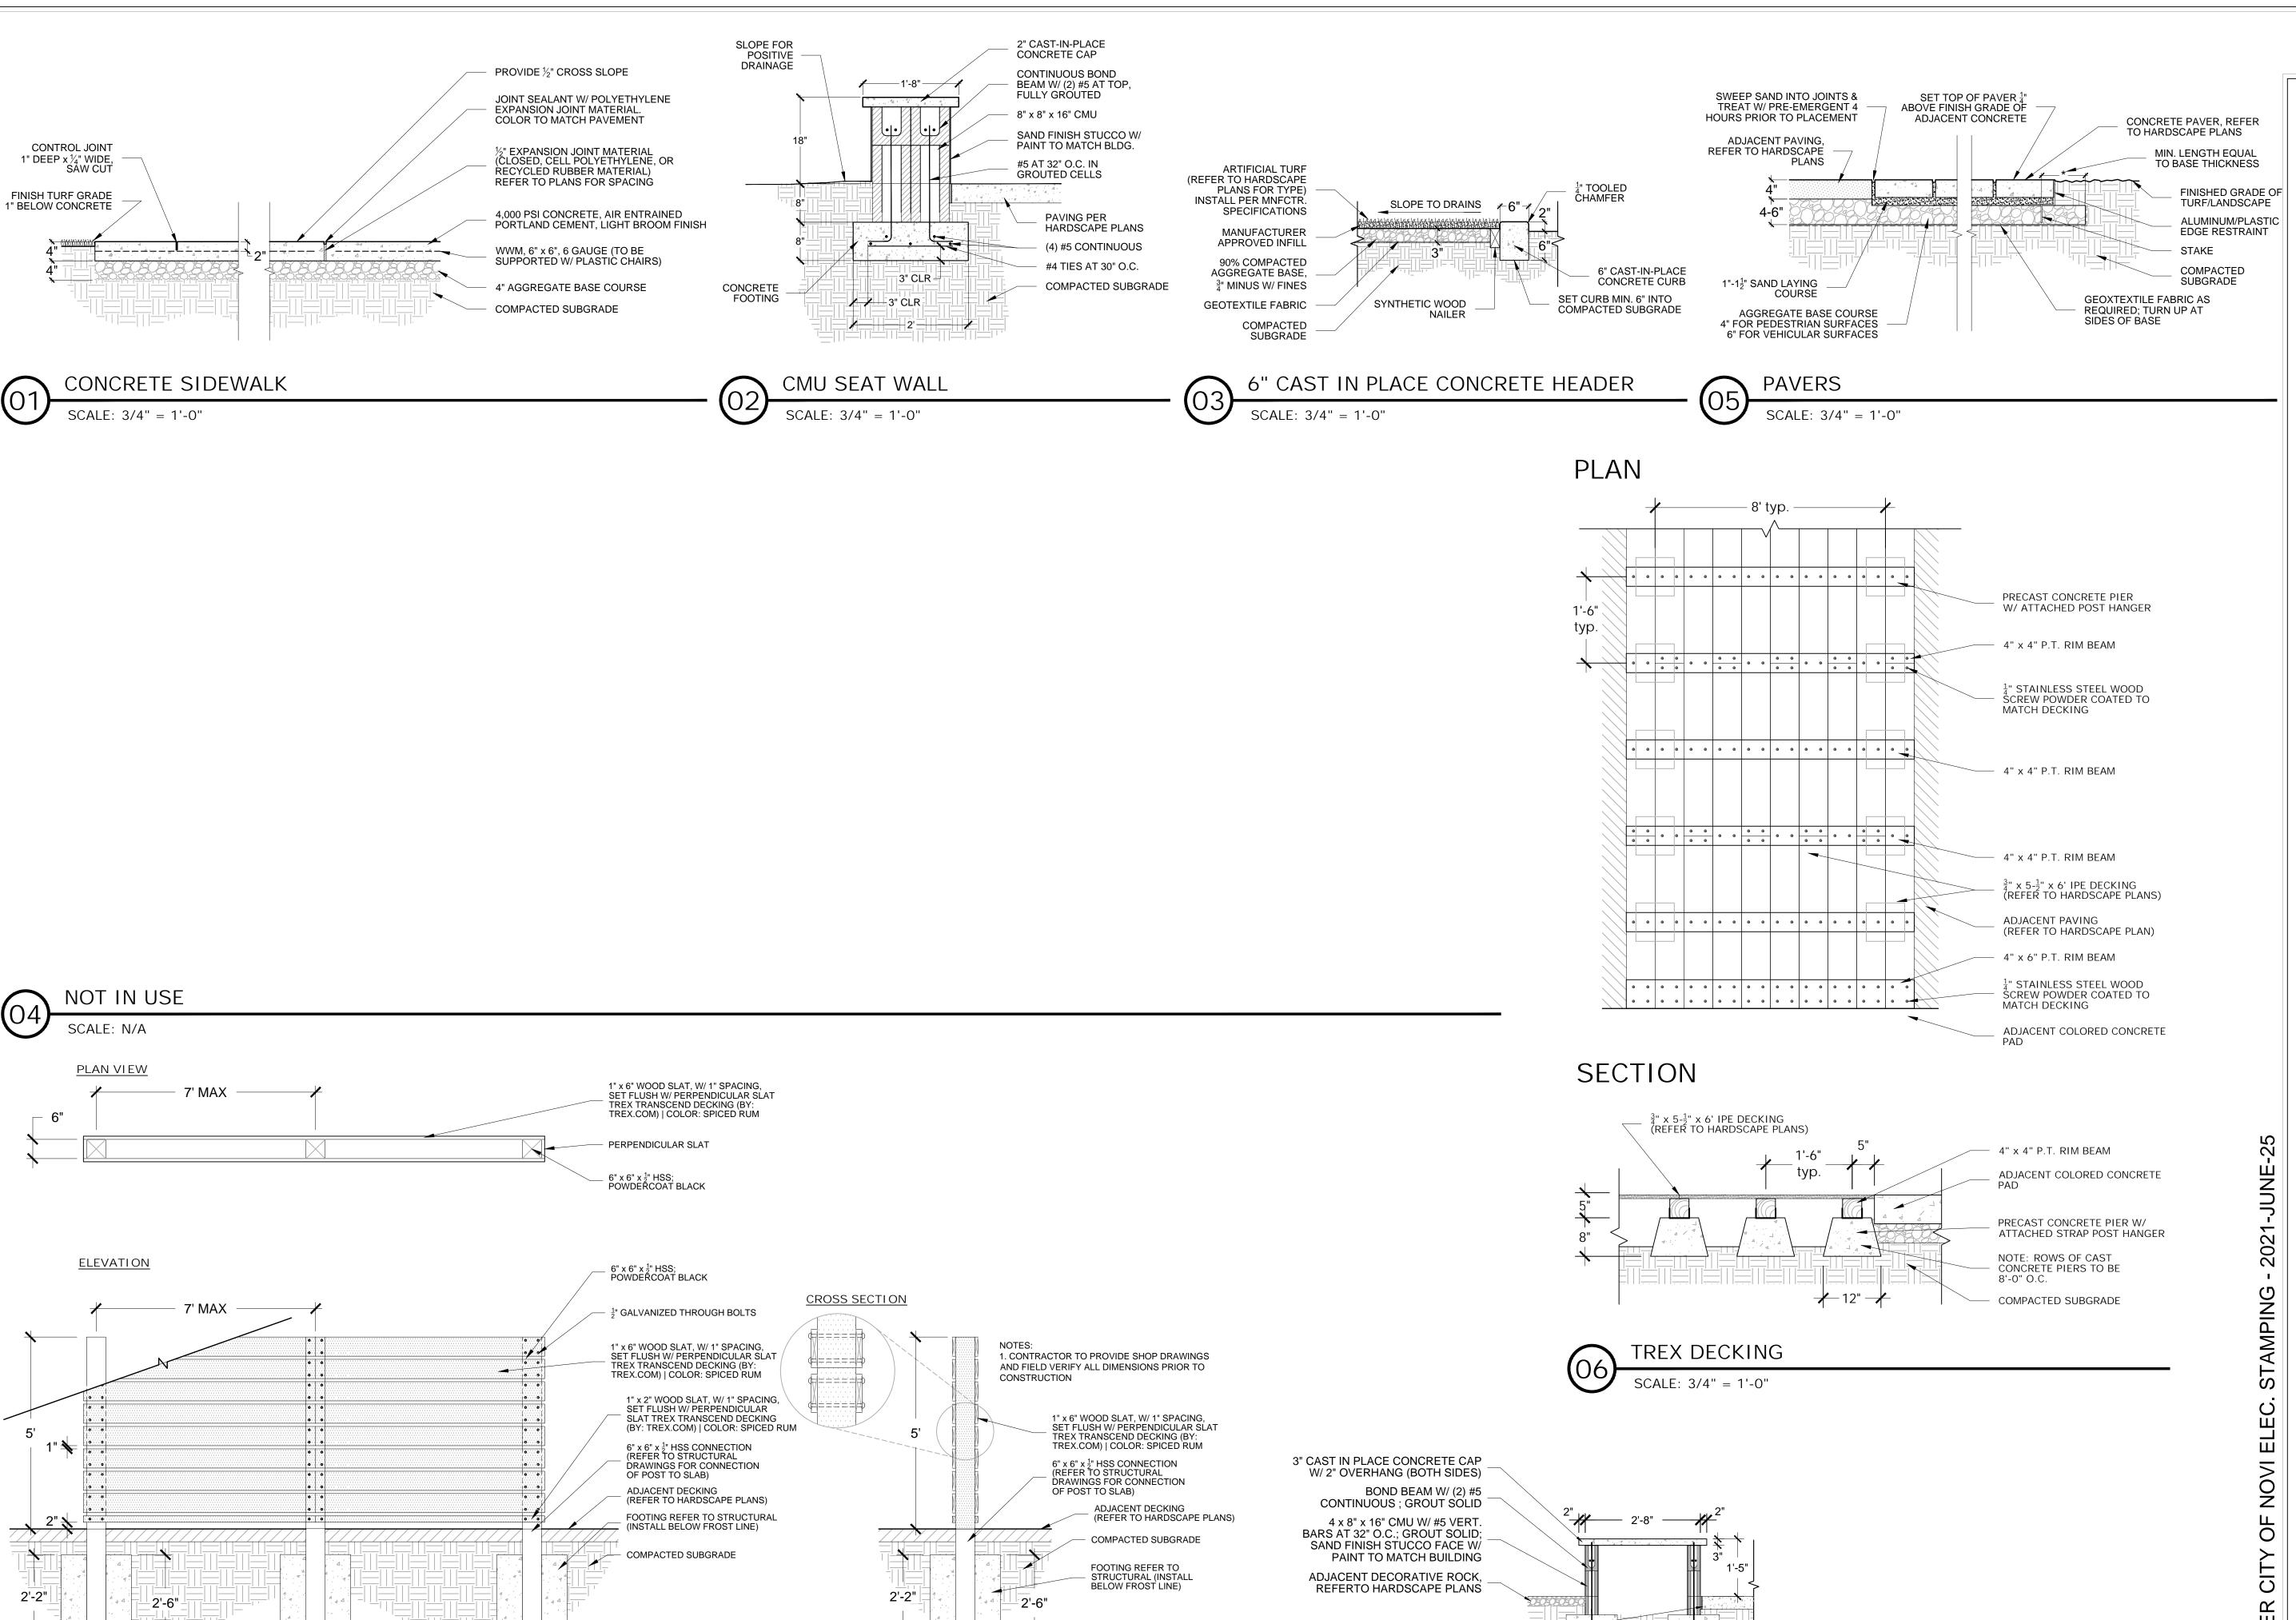
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W: www.hplastudio.com CLIENT DTN MANAGEMENT 2502 LAKE LANSING RD SUITE C, LANSING, MI 48912

SHEET TITLE

LIGHTING PLAN

SHEET NUMBER

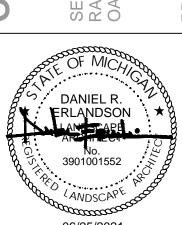

CLEAR OF FOOTING BOTTOM

BOTTOM OF POST MIN 3" CLEAR OF FOOTING BOTTOM

BOTTOM OF POST MIN 3" CLEAR OF FOOTING BOTTOM

WOOD SLAT FENCE

SCALE: 1/2" = 1'-0"

WATERPROOFING LAYER

FOOTING REF. TO STRUCTURAL

(INSTALL BELOW FROST LINE)

DRAWN BY: LAOR: DANIEL R. ERLANDSON PLOT DATE:

SPENCER J. OKESON

S.J.O. & I.K.

06/25/2021

ISSUE FOR PRICING/BIDDING:

DESIGNED BY:

ISSUE DATE

ISSUE FOR PERMIT APPLICATION:

ISSUE FOR CONSTRUCTION:

REVISION SCHEDULE NO: DATE: DESCRIPTION: 08/14/2020 ADDENDUM B ADDENDUM C 09/25/2020

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SE RA OA DANIEL R. ERLANDSON LANDEARE 3901001552

06/25/2021


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SHEET TITLE

SITE DETAILS

SHEET NUMBER



18" MAX FLAME

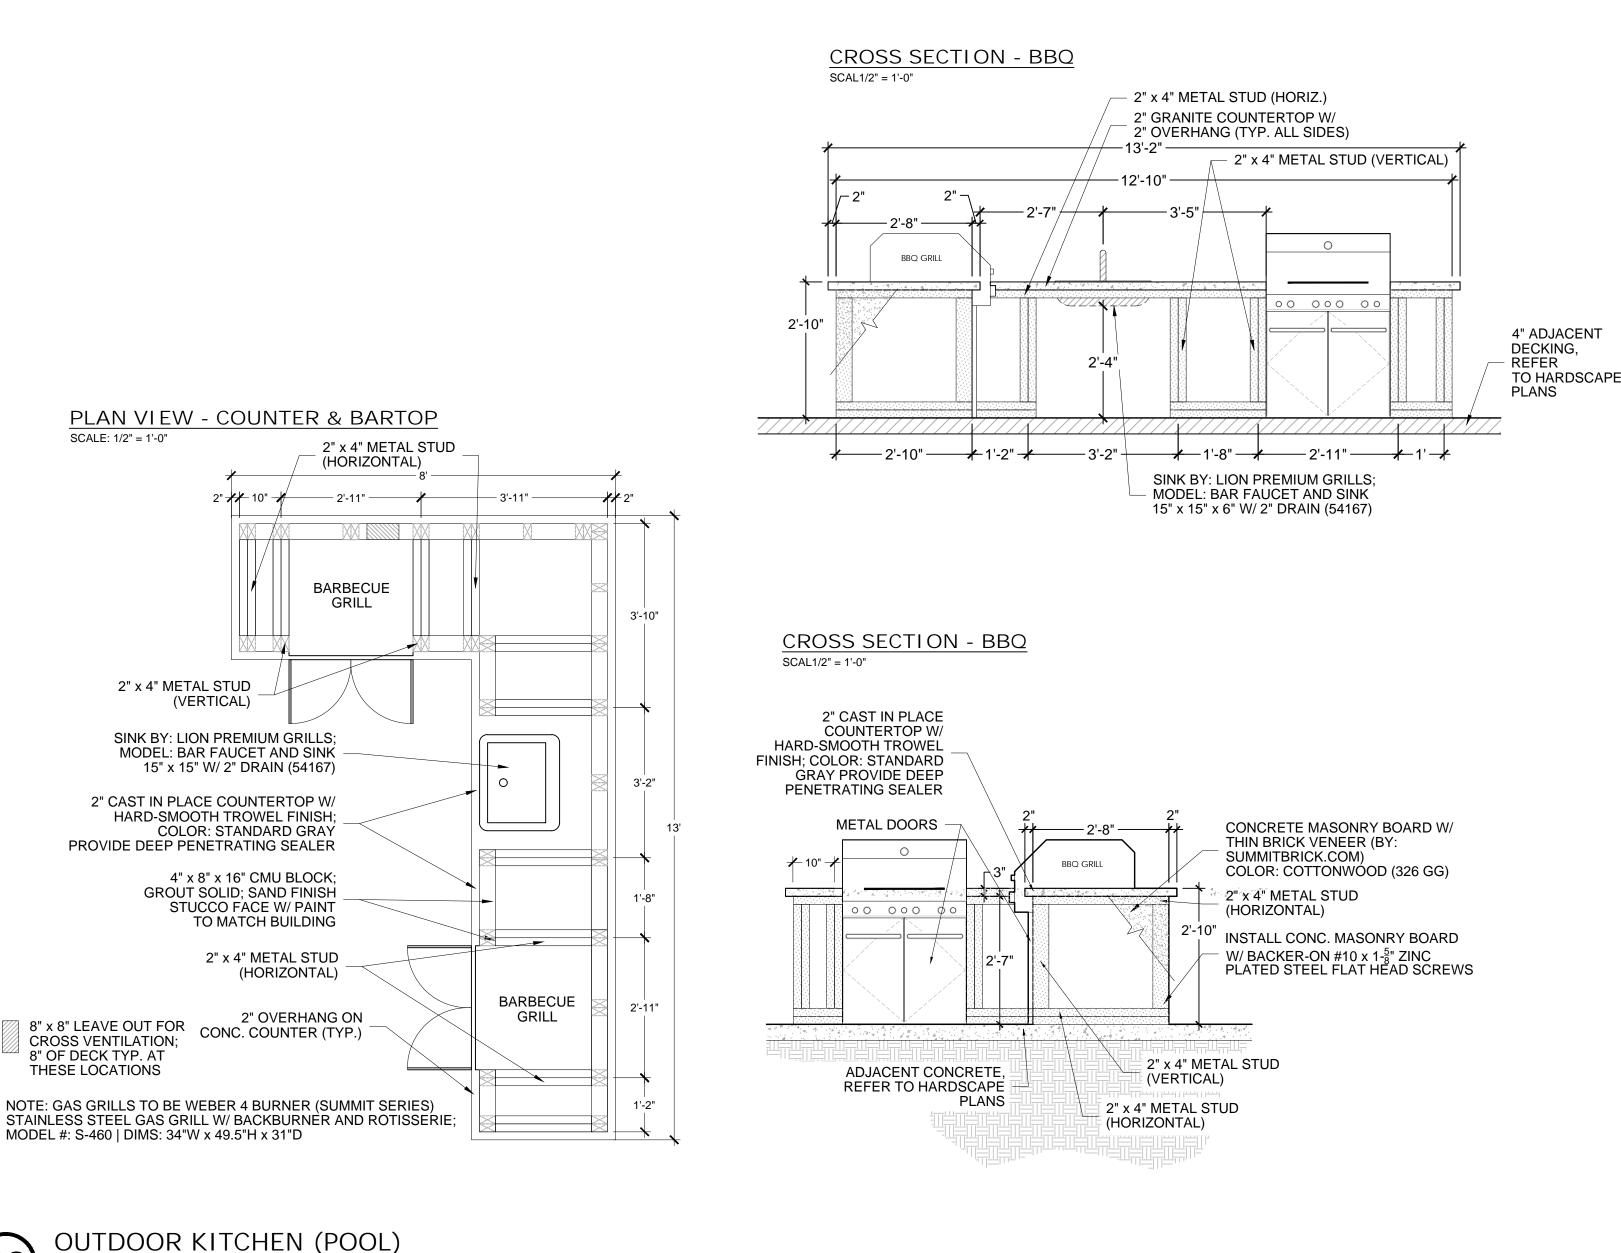CAP, COLOR:

ELECTRONIC IGNITION

STARTING SYSTEM BY

FIREPITSDIRECT.COM

36" PERFORATED METAL

2" CAST-IN-PLACE CONC.

4" x 8" x 16" CMU BLOCK

8" x 8" x 16" CMU BLOCK

SAND FINISH STUCCO, PAINT

DECKING, REFER TO

HARDSCAPE PLANS

TO MATCH BUILDING

GAS LINE, COORDINATE SIZE AND LOCATION W/ MECHANICAL

COMPACTED SUBGRADE


ر الوف الفيه


-FIRE PIT TO REQUIRE APPROX. 400,000 BTU W/ SUPPLY PRESSURE OF

-PROVIDE WEATHER PROOF JUNCTION BOX, TO BE COORDINATED WITH

-PROVIDE 18" MIN. OF VENTILATION ON EACH SIDE OF FIRE PIT W/


GAS TUBE, HIGH CAPACITY

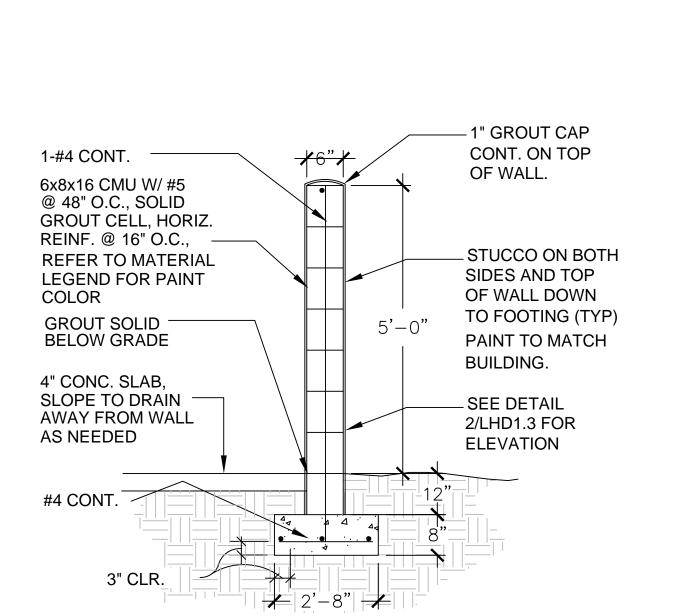

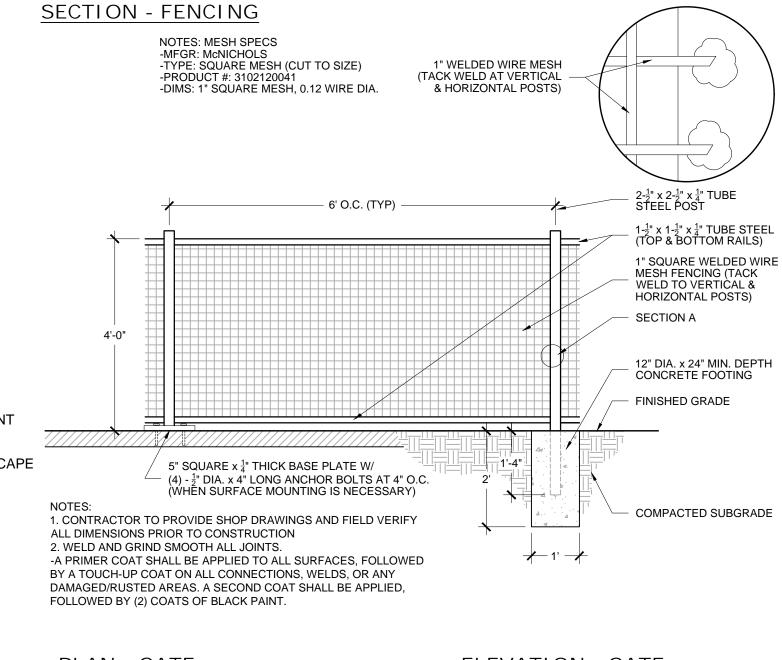

PLAN - GATE

ELEVATION - GATE

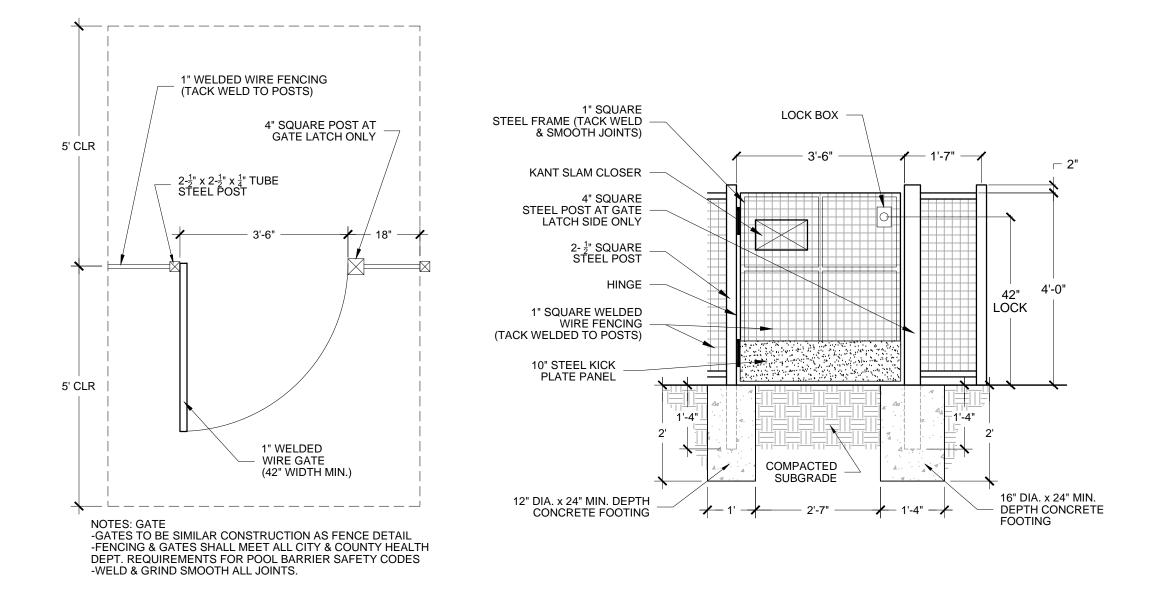

48" WELDED WIRE MESH POOL FENCE

SCALE: 1/2" = 1'-0"

2 2021 **HUMPHREYS & PARTNERS** LANDSCAPE ARCHITECTURE, L.L.C. 5339 ALPHA ROAD SUITE 300 DALLAS, TX 75240 T: (972) 701-9636 F: (972) 701-9639 W: www.hplastudio.com CLIENT DTN MANAGEMENT 2502 LAKE LANSING RD SUITE C, LANSING, MI 48912 SHEET NUMBER

SHEET TITLE SITE DETAILS

DESIGNED BY:

DRAWN BY:

PLOT DATE:

ISSUE DATE

NO:

ISSUE FOR PRICING/BIDDING:

ISSUE FOR CONSTRUCTION:

DATE:

08/14/2020

09/25/2020

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ISSUE FOR PERMIT APPLICATION:

REVISION SCHEDULE

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of any written agreement to the contrary, is limited to

SE RA OA

DANIEL R. ERLANDSON LANGSPARE

3901001552

06/25/2021

architectural element, is expressed or should be implied from delivery of preliminary drawings or unsealed construction drawings. Permission to construct the landscape architectural elements

The landscape architectural works depicted herein

LAOR:

SPENCER J. OKESON

DANIEL R. ERLANDSON

DESCRIPTION:

ADDENDUM B

ADDENDUM C

S.J.O. & I.K.

06/25/2021

SCALE: AS INDICATED CITY JOB #: JSP18-0010

CMU SHOWER ENCLOSURE



SCALE: 1/2" = 1'-0"

ELECTRONIC IGNITION FLAME CONTROL SYSTEM

3.5"-7" OF WATER COLUMN

ELECTRICAL

DECORATIVE LOUVERED PANEL

ELECTRICAL

PANEL

TO PREVENT DAMAGE TO WIRES, CONNECTORS AND THERMOCOUPLE

SWITCH LOCATED —

1"-2" TUMBLED GLASS

BLOCKING AS NEEDED

 $\frac{1}{4}$ " x 3" FLAT STEEL SUPPORT RESTED ON

BEAM AT 16" O.C.,

REINFORCING #5 AT

16" O.C., GROUT SOLID

¹/₂" PEA GRAVEL

FOR DRAINAGE

GROUT SOLID

(1) - #4 CONT. IN BOND


COLOR: BLACK


TO HOLD PAN


ANGLE IRON

ALLOW CLEARANCE

INSIDE CMU ACCESS

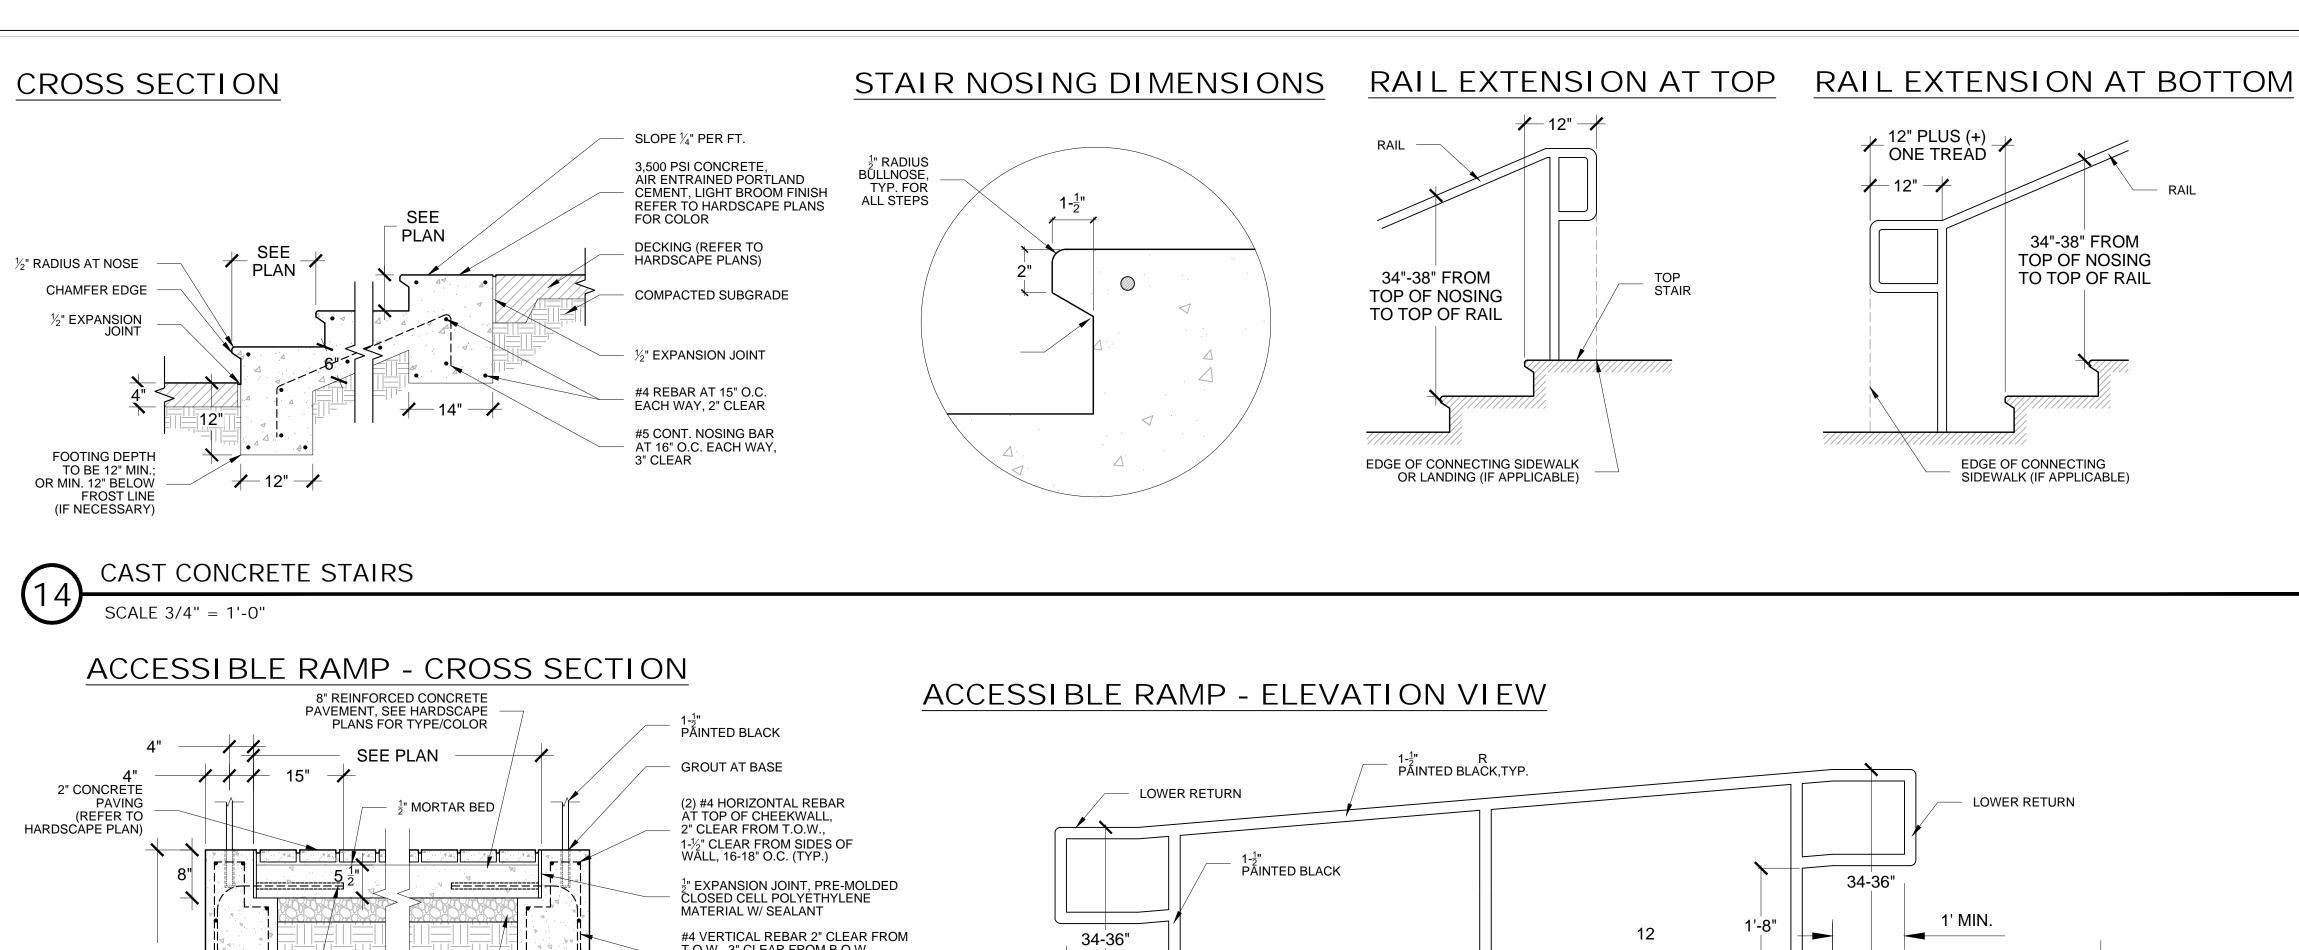

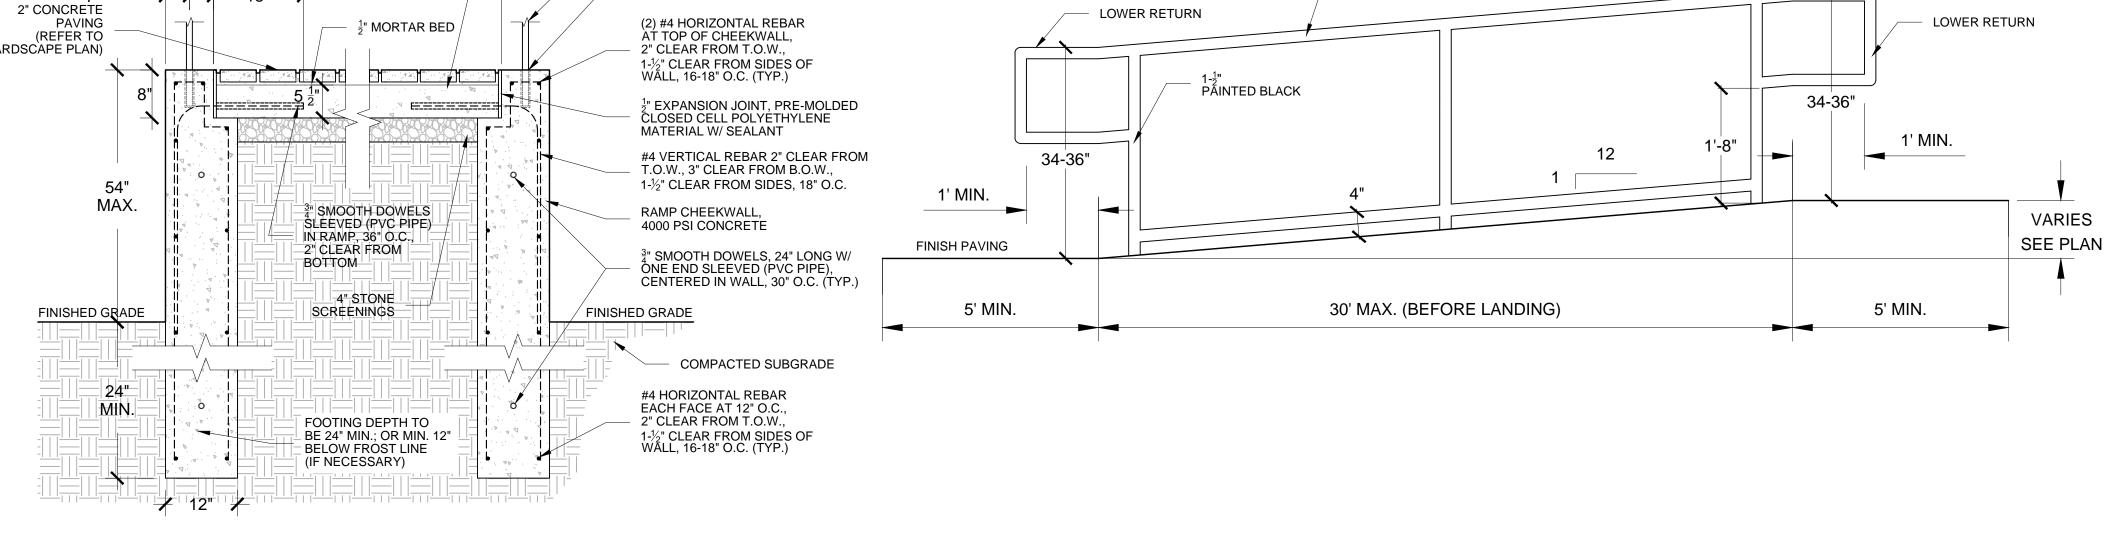

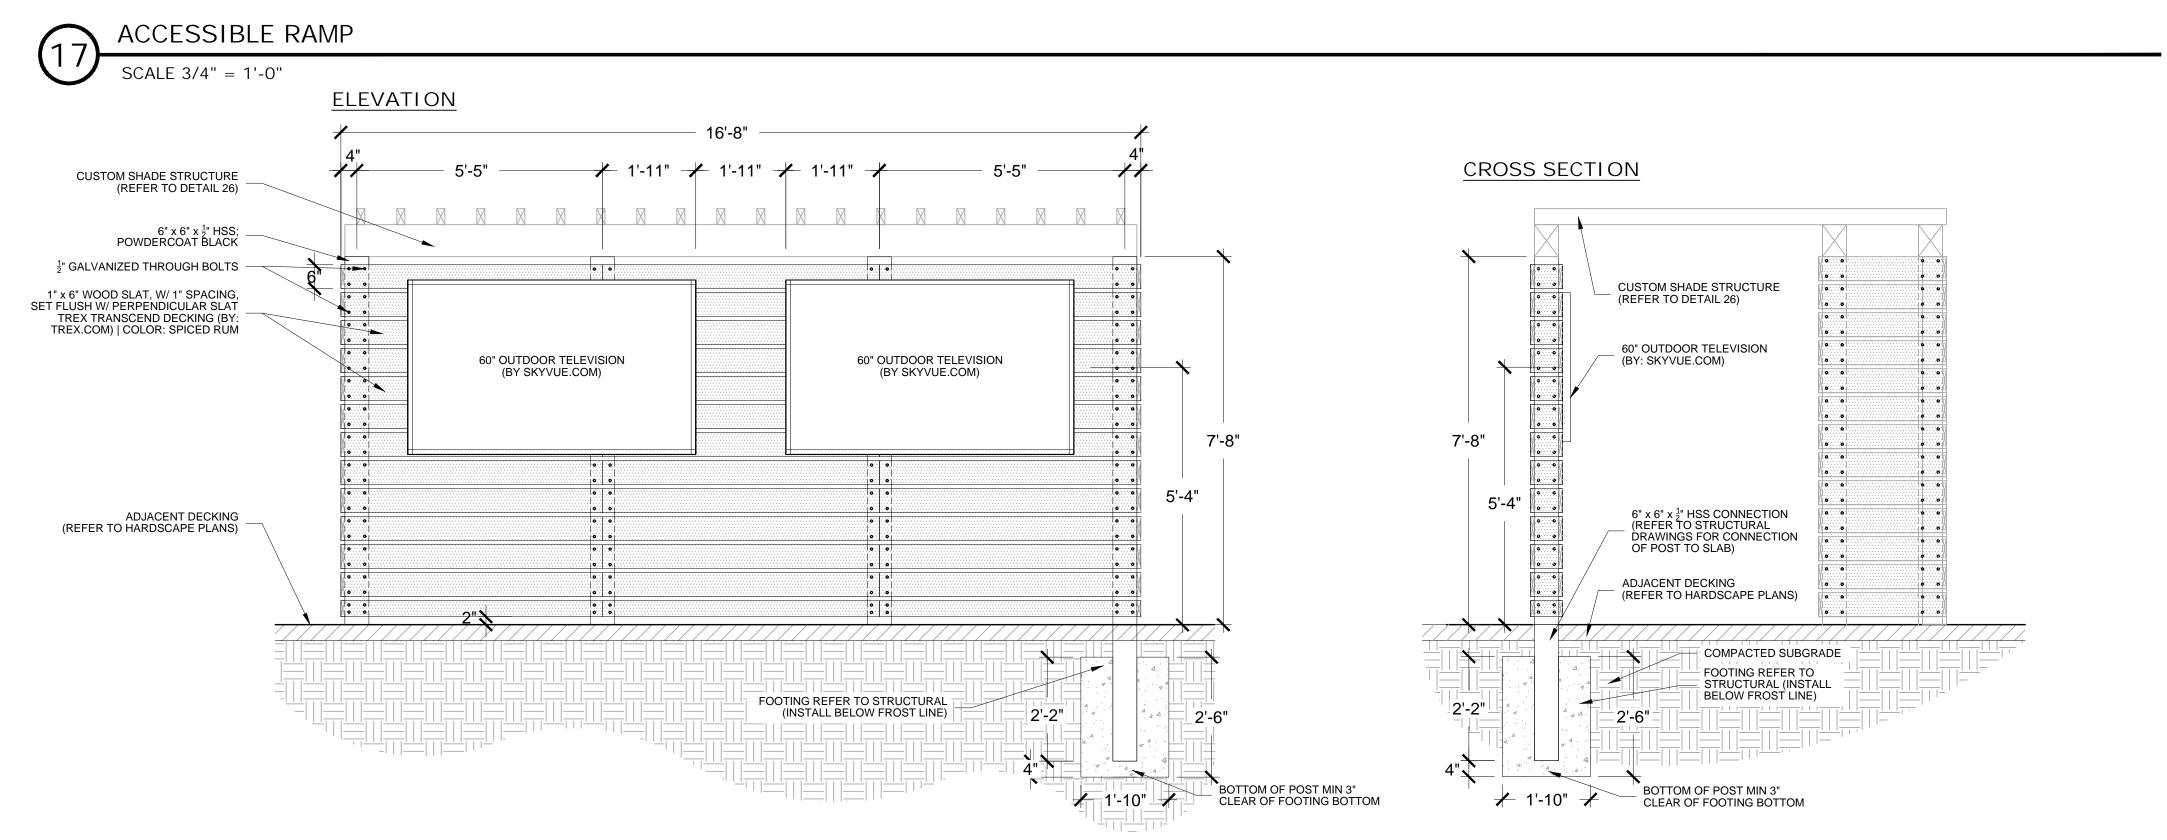

WOOD ACCENT WALL (EAST C.Y.)

SCALE 1" = 1'-0"

DRAWN BY: LAOR: PLOT DATE:

NOT IN USE

DESIGNED BY:

SPENCER J. OKESON S.J.O. & I.K. DANIEL R. ERLANDSON

06/25/2021

ISSUE FOR PRICING/BIDDING:

ISSUE FOR PERMIT APPLICATION:

01/22/2021


ISSUE FOR CONSTRUCTION: ISSUE DATE

REVISION SCHEDULE						
O:	DATE:	DESCRIPTION:				
<u>/</u>	08/14/2020	ADDENDUM B				
<i>>></i>	09/25/2020	ADDENDUM C				

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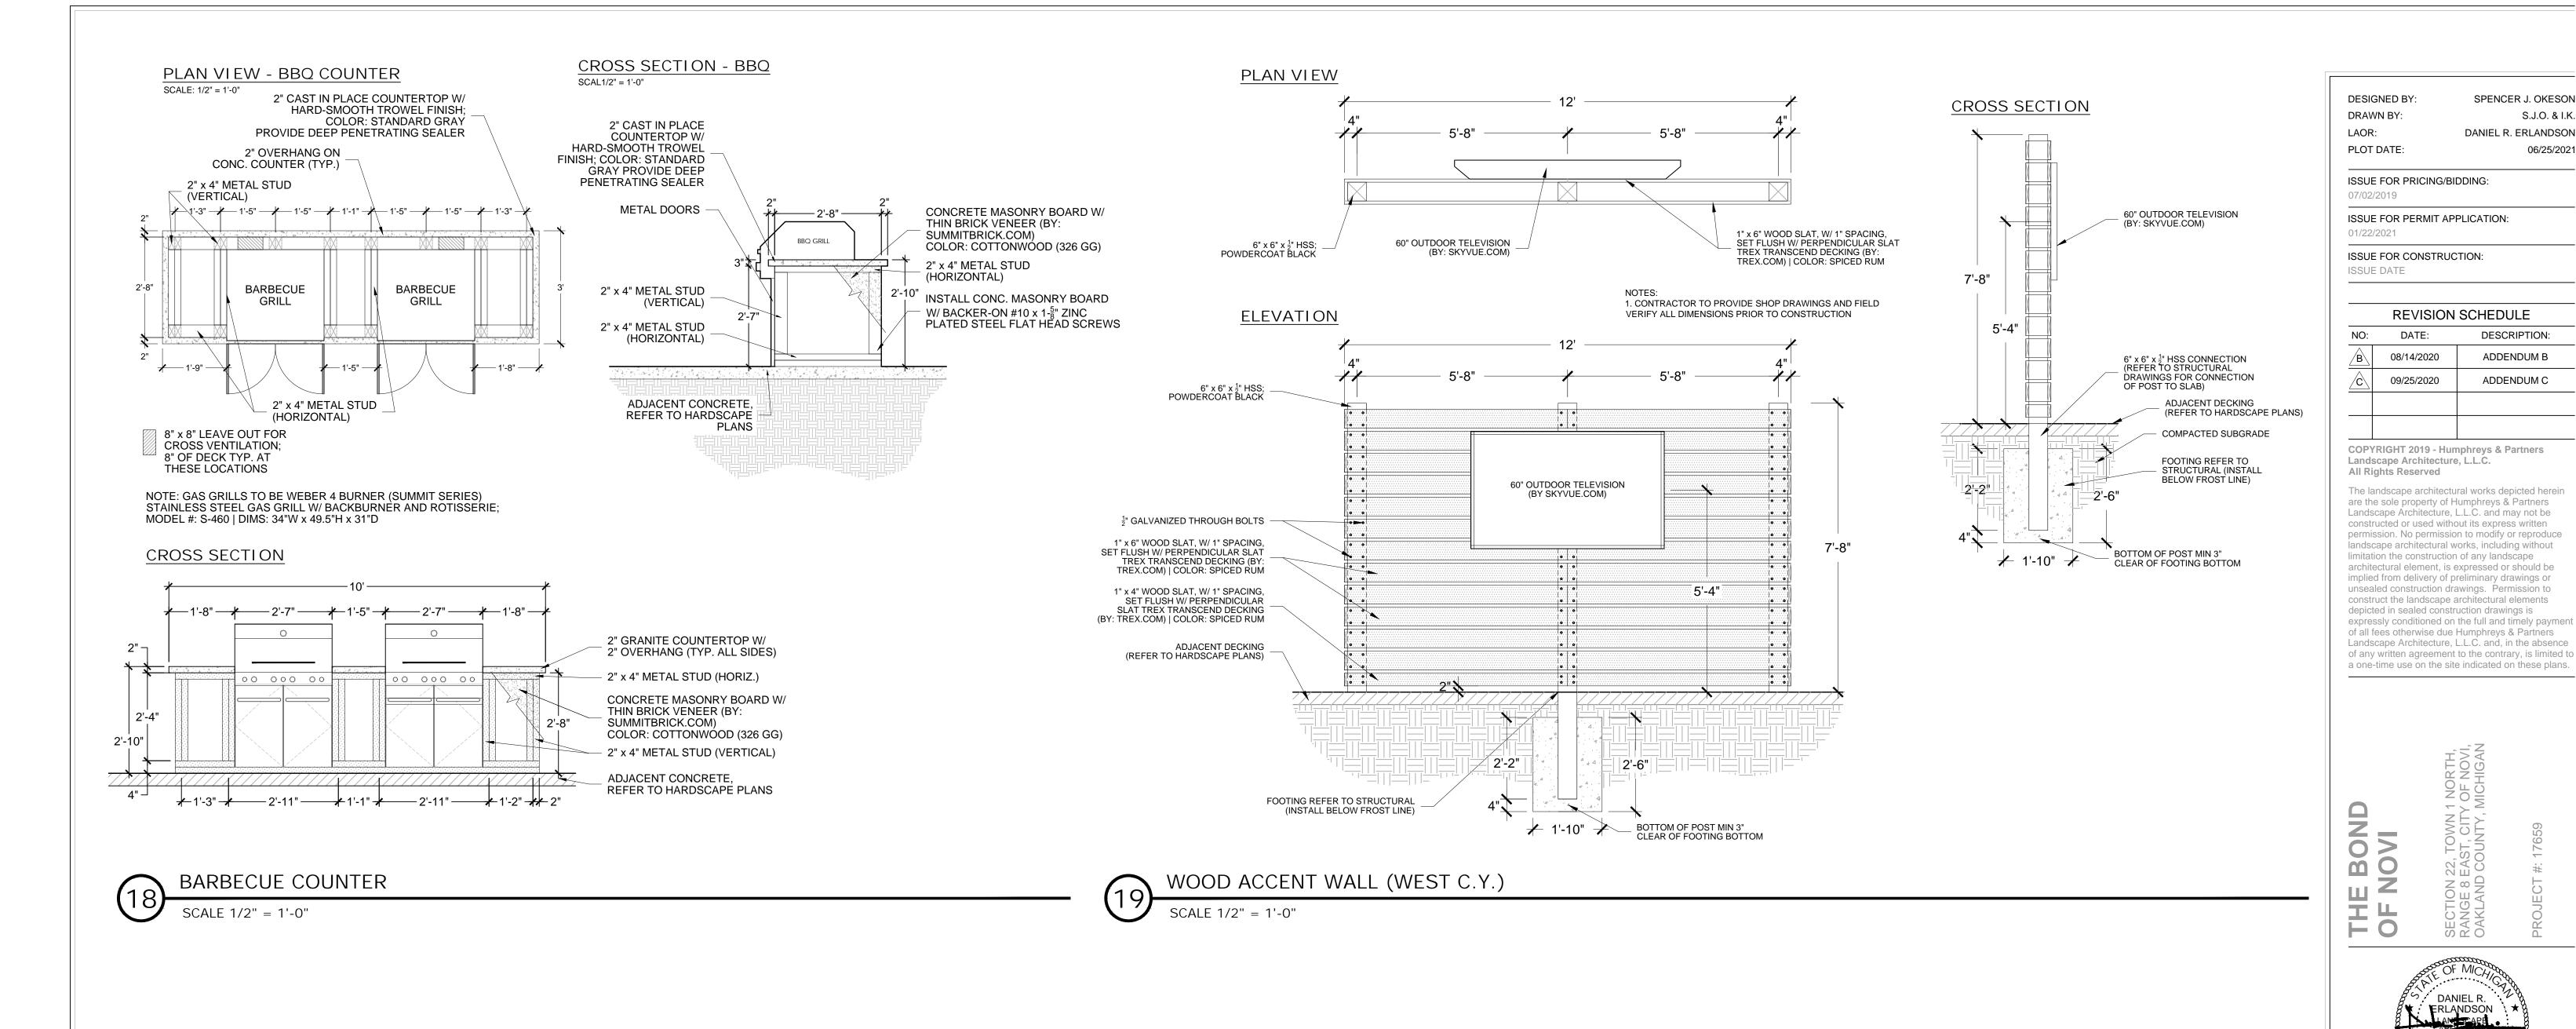
CLIENT
DTN MANAGEMENT
2502 LAKE LANSING RD
SUITE C,
LANSING, MI 48912

SHEET TITLE


SITE DETAILS

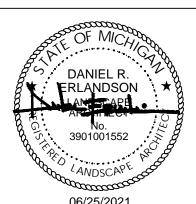SHEET NUMBER

1902



NOT IN USE

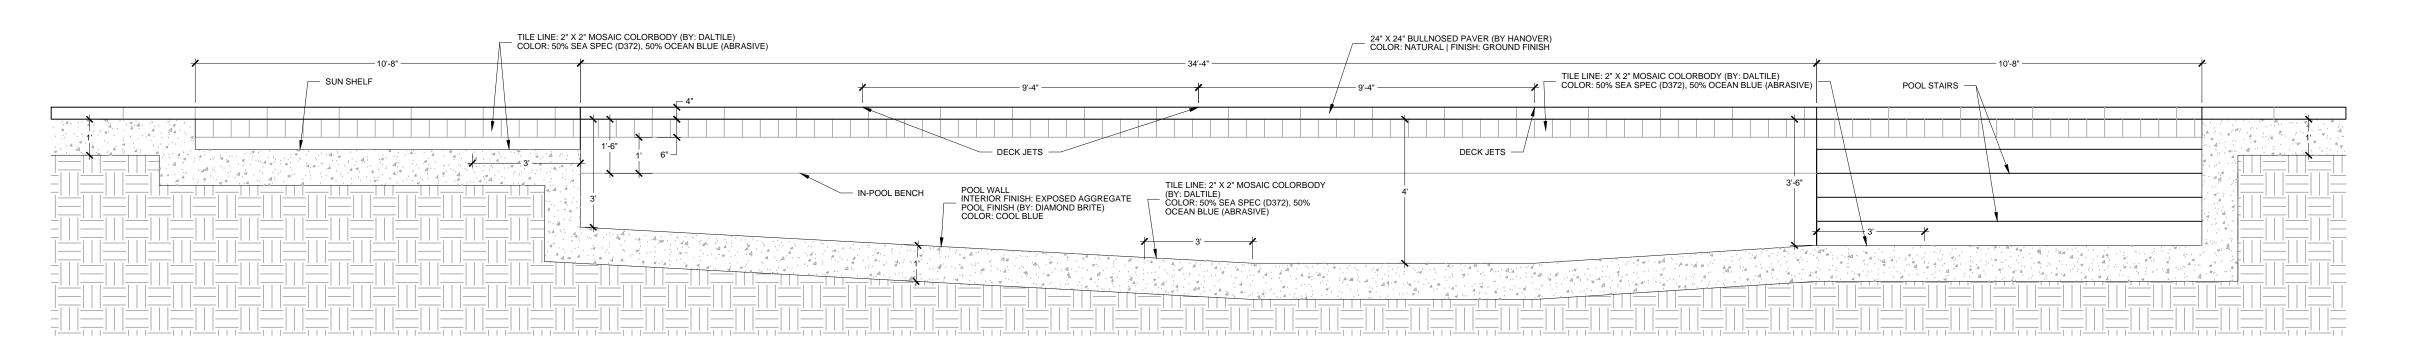

SCALE 3/8" = 1'-0"

2021 REVISED

2

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SE RA OA

DANIEL R.

SPENCER J. OKESON

DANIEL R. ERLANDSON

DESCRIPTION:

ADDENDUM B

ADDENDUM C

S.J.O. & I.K.

06/25/2021

CLIENT DTN MANAGEMENT 2502 LAKE LANSING RD SUITE C, LANSING, MI 48912


SHEET TITLE

SITE DETAILS

SHEET NUMBER



SCREEN WALL

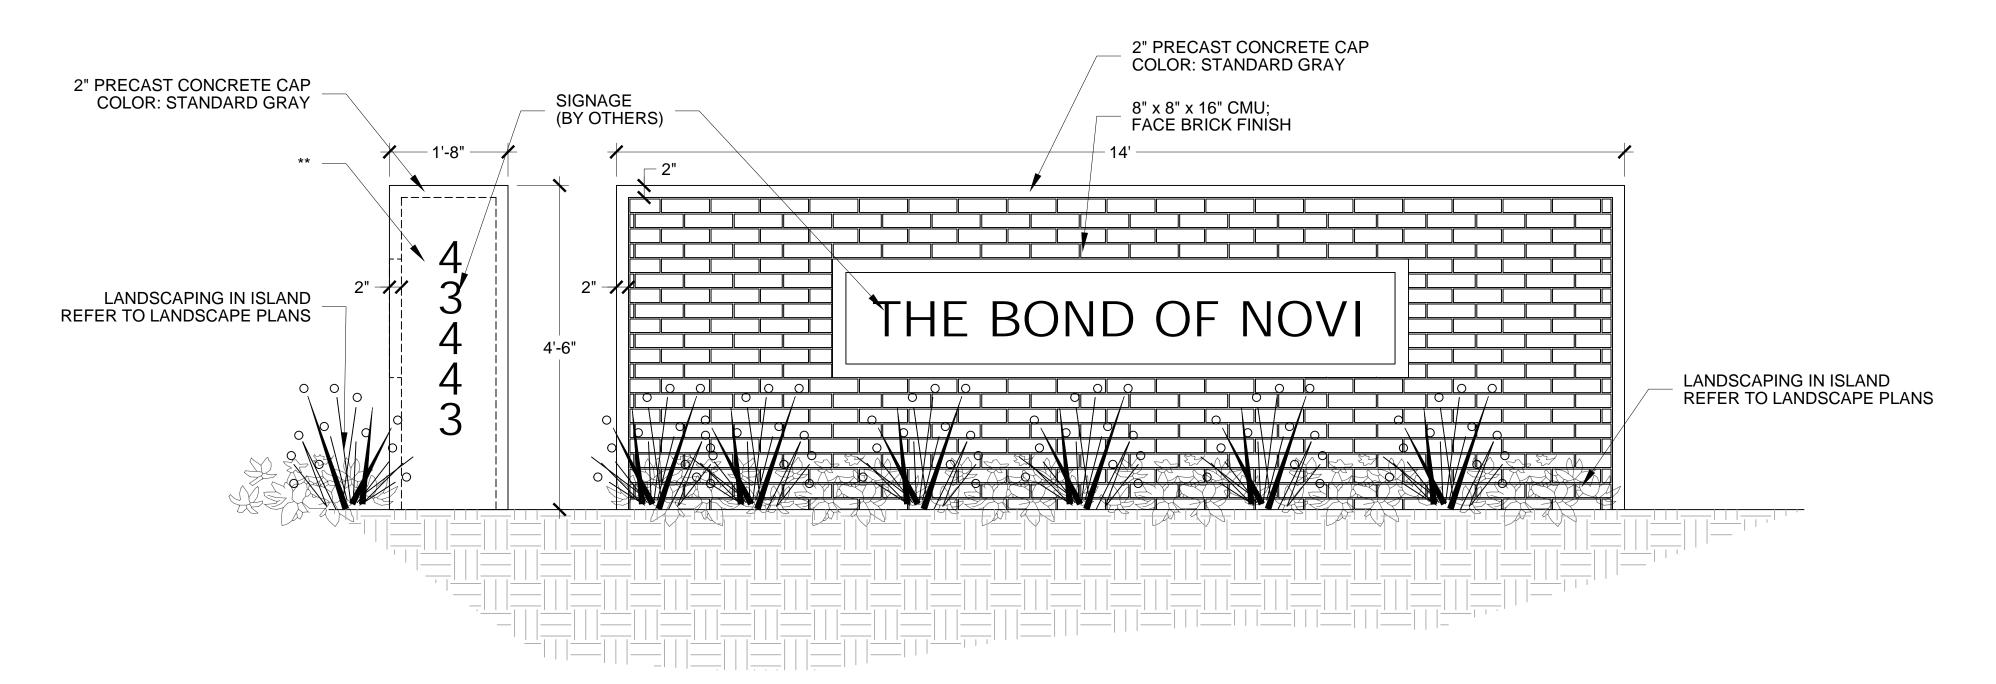

MONUMENT SIGN

SCALE 3/4" = 1'-0"

DESIGNED BY: DRAWN BY:

PLOT DATE:

SPENCER J. OKESON S.J.O. & I.K. DANIEL R. ERLANDSON 06/25/2021

ISSUE FOR PRICING/BIDDING:

ISSUE FOR PERMIT APPLICATION:

ISSUE FOR CONSTRUCTION: ISSUE DATE

REVISION SCHEDULE

	INE VISION SCHEDULE								
NO:	DATE:	DESCRIPTION:							
B	08/14/2020	ADDENDUM B							
c	09/25/2020	ADDENDUM C							

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2021

SE OA DANIEL R. ERLANDSON LANGSPARE




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SHEET TITLE


SITE DETAILS

SHEET NUMBER



WOODLAND PLAN

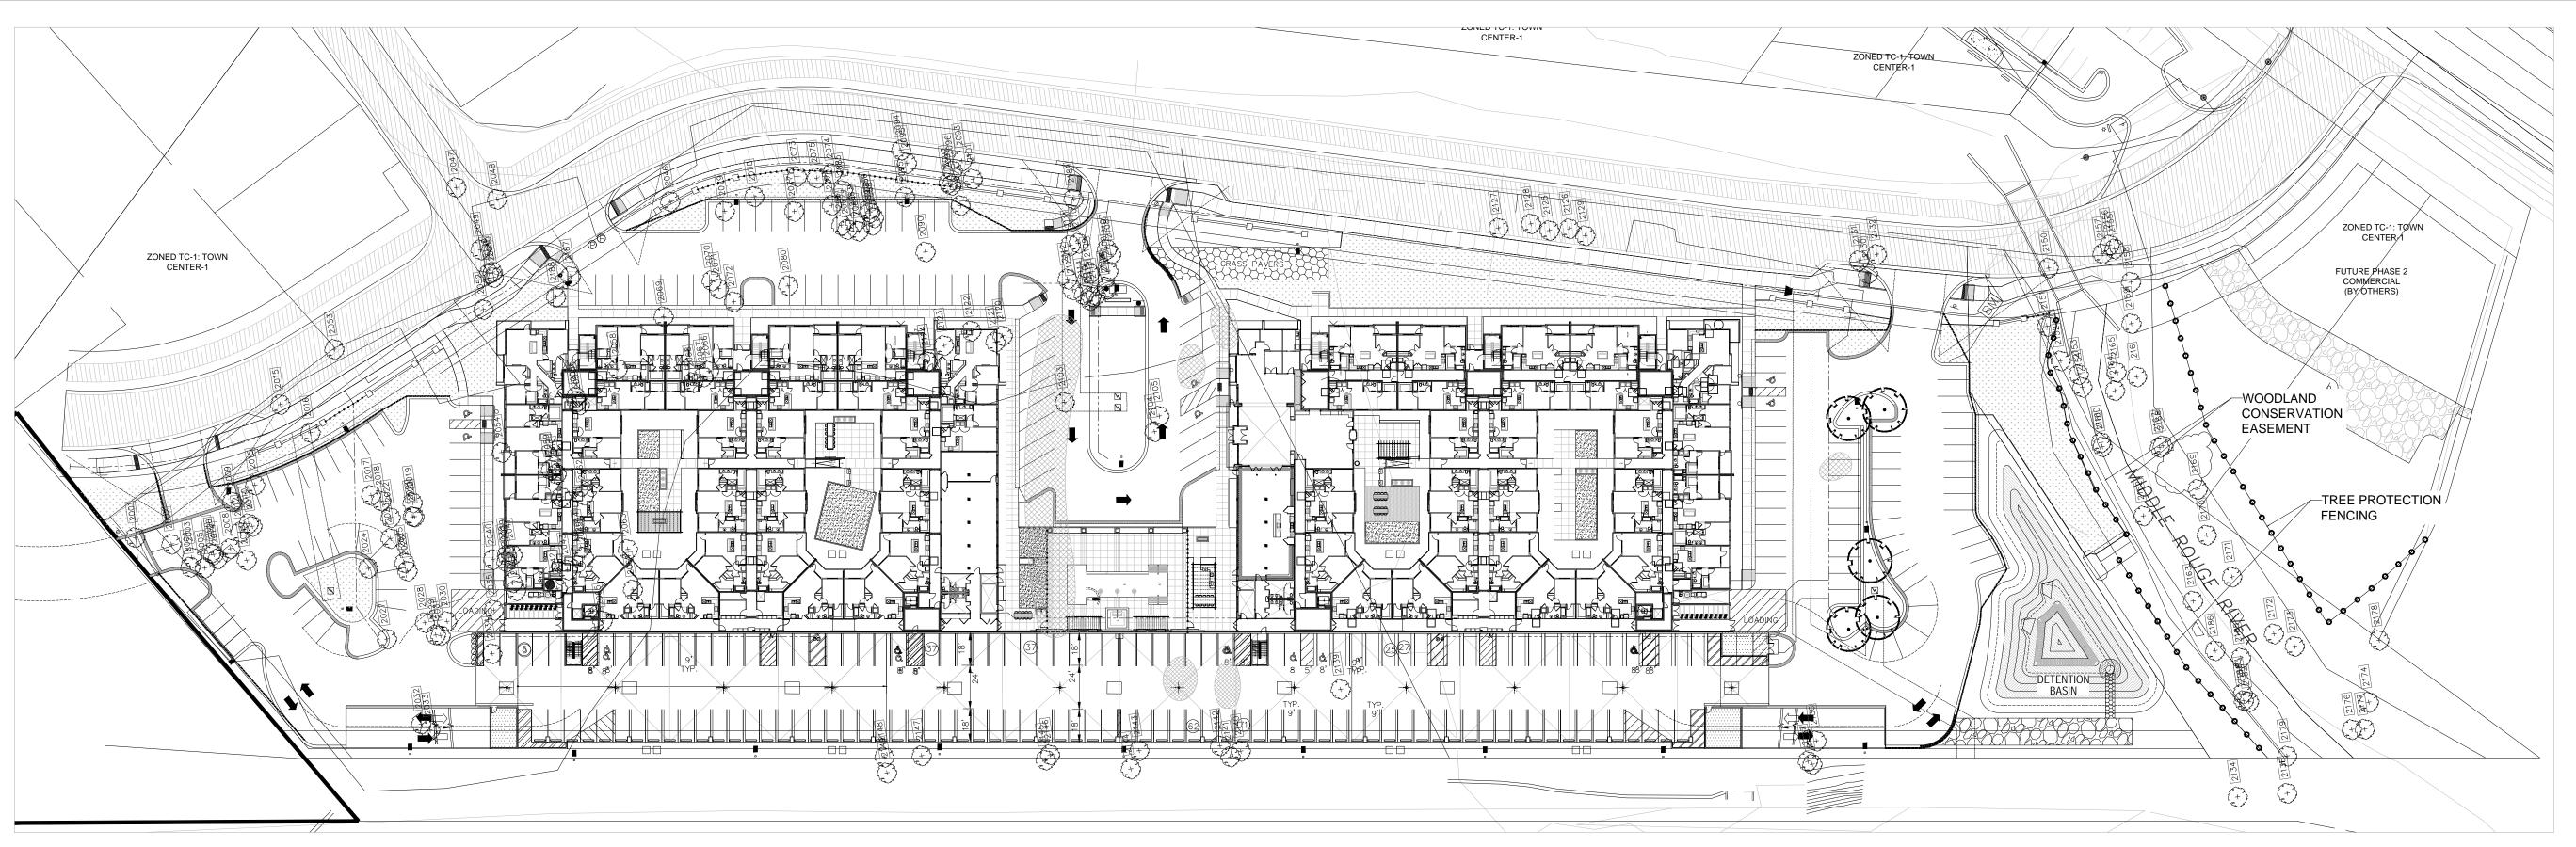SITE

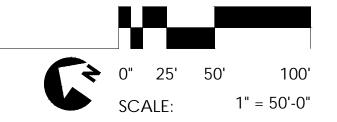

TAG NO.	DIAMETER	COMMON NAME	BOTANICAL NAME	CONDITION	REMARKS	REQUIRED REPLACEMENT	CREDITS	TAG NO.	DIAMETER	COMMO	ON NAME	BOTANICAL NAME	CONDITION	REMARKS	REQUIRED REPLACEMENT	CREDITS	TAG NO.	DIAMETER
2001	Processing Constituting Constitution Constit	Eastern Cottonwood	Populus deltoides	Good	Remove	2	CILLDITO	2076		Eastern Cott		Populus deltoides	Good	Remove	2	CINEDITO	2159	8
2002		Eastern Cottonwood	Populus deltoides	Good	Remove	3		2077	8	Eastern Cott		Populus deltoides	Good	Remove	1		2160	10
2003	11	Eastern Cottonwood	Populus deltoides	Good	Remove	1		2078	13	Eastern Cott	A CONTRACTOR OF THE PARTY OF TH	Populus deltoides	Good	Remove	2		2161	10
2004	11	Eastern Cottonwood	Populus deltoides	Good	Remove	1		2079	12	Eastern Cott	ttonwood	Populus deltoides	Good	Remove	2		2162	8,9
2005		Eastern Cottonwood	Populus deltoides	Good	Remove	4		2080	11	Eastern Cott	ttonwood	Populus deltoides	Good	Remove	1		2163	8
2006		Eastern Cottonwood	Populus deltoides	Good	Remove	1		2081	13,13	Eastern Cott		Populus deltoides	Good	Remove	4		2164	7
2007	8	Eastern Cottonwood	Populus deltoides	Good	Remove	1 1		2082	Continue Consideration of	Eastern Cott	C-100 C-14 C-14 C-14 C-14 C-14 C-14 C-14 C-14	Populus deltoides	Good	Remove	5		2165	7
2008		Eastern Cottonwood	Populus deltoides	Good	Remove	2		2083	9	Eastern Cott	MINISTER WOLDOW	Populus deltoides	Good	Remove	1	<u> </u>	2166	7
2009	11	Eastern Cottonwood	Populus deltoides	Good	Remove	1		2084	9	Eastern Cott		Populus deltoides	Good	Remove	1	-	2167	8
2010 2011	8 14,14	Eastern Cottonwood Eastern Cottonwood	Populus deltoides Populus deltoides	Good Good	Remove Remove	4		2085 2086	13	Eastern Cott		Populus deltoides Populus deltoides	Good Good	Remove	2		2168	8
2012	8	Eastern Cottonwood	Populus deltoides	Good	Remove	1		2087	11	Eastern Cott		Populus deltoides	Good	Remove	1	-	2169 2170	9
2013	175	Eastern Cottonwood	Populus deltoides	Good	Remove	2		2088	11,12	Eastern Cott		Populus deltoides	Good	Remove	3	1	2171	12
2014	12	Eastern Cottonwood	Populus deltoides	Good	Remove	2		2089	13	Eastern Cott	2011	Populus deltoides	Good	Remove	2		2172	8
2015	12	Eastern Cottonwood	Populus deltoides	Good	In Public ROW			2090	- Company of the Company of	Eastern Cott	\$100 PER	Populus deltoides	Good	Remove	6	1	2173	12
2016	10	Black Willow	Salix nigra	Good	In Public ROW			2091	13,13	Eastern Cott	ttonwood	Populus deltoides	Good	Remove	4	i i	2174	13
2017	9	Eastern Cottonwood	Populus deltoides	Good	Remove	1		2092	9	Eastern Cott	ttonwood	Populus deltoides	Good	In Public ROW	0		2176	8
2018	17	Eastern Cottonwood	Populus deltoides	Good	Remove	2		2093	11,15	Eastern Cott	ttonwood	Populus deltoides	Good	In Public ROW	0		2177	17
2019	16,16	Eastern Cottonwood	Populus deltoides	Good	Remove	4		2094	9,13,19	Eastern Cott	ttonwood	Populus deltoides	Good	In Public ROW	0		2178	23
2020	12,14	Eastern Cottonwood	Populus deltoides	Good	Remove	4		2095	10	Eastern Cott	ttonwood	Populus deltoides	Good	In Public ROW			2179	11
2021	10	Eastern Cottonwood	Populus deltoides	Good	Remove	1		2096	9,11	Eastern Cott		Populus deltoides	Good	In Public ROW	0		2180	14
2022	13	Eastern Cottonwood	Populus deltoides	Good	Remove	2		2101	10	American El		Ulmus americana	Good	In Public ROW	0		2181	8
2023	October 10 September 1997	Eastern Cottonwood	Populus deltoides	Good	Remove	2		2102	18	Eastern Cott	A CONTRACTOR OF THE PARTY OF TH	Populus deltoides	Good	Remove	2		2182	10
2024		Eastern Cottonwood	Populus deltoides	Good	Remove	5		2103	13	Eastern Cott	All the second second second second	Populus deltoides	Good	Exempt			2183	13
2025	22	Eastern Cottonwood	Populus deltoides	Good	Remove	3		2104	10	Eastern Cott		Populus deltoides	Good	Exempt			2184	11
2026 2027	16 19	Eastern Cottonwood Eastern Cottonwood	Populus deltoides Populus deltoides	Good Good	Remove	2 2		2105 2106	8 16	Eastern Cott		Populus deltoides Populus deltoides	Good Good	Exempt Remove	2		2185	10
2027	9	Eastern Cottonwood	Populus deltoides	Good	Remove	1		2106	13	Eastern Cott		Populus deltoides Populus deltoides	Good	Remove	2		2186	9
2029	17	Eastern Cottonwood	Populus deltoides	Good	Remove	2		2108	11	Eastern Cott		Populus deltoides	Good	Remove	1		2187 2188	8,12 10
2030	16/3/	Eastern Cottonwood	Populus deltoides	Good	Remove	2		2109	8	Eastern Cott		Populus deltoides	Good	Remove	1	+	2189	11
2031	22	Eastern Cottonwood	Populus deltoides	Good	Remove	3		2110	12	Eastern Cott		Populus deltoides	Good	Remove	2		2190	8
2032	19	Eastern Cottonwood	Populus deltoides	Good	Remove	2		2111	16	Eastern Cott		Populus deltoides	Good	Remove	2		2.100	1
2033	12	Eastern Cottonwood	Populus deltoides	Good	Remove	2		2112	9,11,12	Eastern Cott		Populus deltoides	Good	Remove	4		-	1
2034	Dead				Remove	0		2113	12	Eastern Cott	ttonwood	Populus deltoides	Good	Remove	2			.1
2035	8	Eastern Cottonwood	Populus deltoides	Good	Remove	1		2114	10	Eastern Cott	ttonwood	Populus deltoides	Good	Remove	1			
2036		Eastern Cottonwood	Populus deltoides	Good	Remove	3		2115	7,9	Eastern Cott	ttonwood	Populus deltoides	Good	Remove	1		18/6	
2037	13	Eastern Cottonwood	Populus deltoides	Good	Remove	2		2116	8	Eastern Cott	and the second second second	Populus deltoides	Good	Remove	1			OODLAN
2038	8	Eastern Cottonwood	Populus deltoides	Good	Remove	1		2117	10	Eastern Cott		Populus deltoides	Good	Remove	1		TO	TAL TRE
2039	1000	Eastern Cottonwood	Populus deltoides	Good	Remove	2		2118		Eastern Cott		Populus deltoides	Good	Remove	1		LE	SS:
2040 2041	13	Eastern Cottonwood Eastern Cottonwood	Populus deltoides Populus deltoides	Good	Remove	2 2		2119	10	Eastern Cott		Populus deltoides	Good	Remove	1 3	-		
2041		Eastern Cottonwood	Populus deltoides Populus deltoides	Good Good	Remove Remove	1		2120 2121	12,12	Black Locus American El	54.5	Robinia pseudoacacia	Good Good	Remove Remove	1	-		
2042	57,512	Eastern Cottonwood	Populus deltoides	Good	Remove	2		2121	8	Black Locus		Ulmus americana Robinia pseudoacacia	Good	Remove	1	-		
2044	11	Eastern Cottonwood	Populus deltoides	Good	Remove	1		2123	11	Black Locus		Robinia pseudoacacia	Good	Remove	1		RE	GULATE
2045	9	Eastern Cottonwood	Populus deltoides	Good	Remove	1		2124	8	Green Ash	J.	Fraxinus pennsylvanica	Fair	Remove	1			
2046	8	American Elm	Ulmus americana	Good	Remove	1		2125	12	Austrian Pin	ne	Pinus nigra	Good	In Public ROW	0		RF	PLACEM
2047	16	Eastern Cottonwood	Populus deltoides	Good	In Public ROW	0		2126	1000	Austrian Pin		Pinus nigra	Good	In Public ROW	0			
2048	9	Eastern Cottonwood	Populus deltoides	Good	In Public ROW	0		2127	19,19	Eastern Cott	ttonwood	Populus deltoides	Good	In Public ROW	0	1 1		EES 8" -
2049	10	Eastern Cottonwood	Populus deltoides	Good	In Public ROW	0		2128	13	Austrian Pin	ne	Pinus nigra	Good	In Public ROW	0		TR	EES 11"
2050		Eastern Cottonwood	Populus deltoides	Good	In Public ROW			2129	16	Austrian Pin	ne	Pinus nigra	Good	In Public ROW	0		TR	EES 20"
2051	7	Eastern Cottonwood	Populus deltoides	Good	In Public ROW			2130	13	Austrian Pin		Pinus nigra	Good	In Public ROW	0			EES 30"+
2052	9	Eastern Cottonwood	Populus deltoides	Good	In Public ROW	4.00		2131	17	Austrian Pin		Pinus nigra	Good	In Public ROW	0			
2053	14	Eastern Cottonwood	Populus deltoides	Good	In Public ROW			2132	13	Austrian Pin	ne	Pinus nigra		In Public ROW	0			JLTI-STEI
2054	14	Black Walnut	Juglans nigra	Good	Remove	2		2133		Box Elder		Acer negundo	Good	Off-site			PR	ESERVE
2055 2056	12	Eastern Cottonwood Eastern Cottonwood	Populus deltoides	Good	Remove	2 2		2134	13	Box Elder	ttonwood	Populus deltoides	Good	Off-site		-	SU	B-TOTAL
2057		Eastern Cottonwood	Populus deltoides Populus deltoides	Good Good	Remove Remove	6		2135 2136	6,7,12	Eastern Cott	ttonwood	Acer negundo Populus deltoides	Good Good	Off-site Exempt		-		LESS
2058	11	Black Willow	Salix nigra	Good	Remove	1		2137	10	Eastern Cott		Populus deltoides	Good	Exempt			D.E.	
2059	10	Eastern Cottonwood	Populus deltoides	Good	Remove	1		2138	10	Eastern Cott		Populus deltoides	Good	Exempt		+	KE	QUIRED
2060	11	Eastern Cottonwood	Populus deltoides	Good	Remove	 i	_	2139	Dead	Luotoni ooti		r opulae delleidee	0000	Remove	0	1		
2061		Eastern Cottonwood	Populus deltoides	Good	Remove	1		2140		Eastern Cott	ttonwood	Populus deltoides	Good	Exempt	-	_	SF	E CHART
2062		Eastern Cottonwood	Populus deltoides	Good	Remove	2		2141	21	Eastern Cott		Populus deltoides	Good	Exempt			0_	_ 0
2063	14	Eastern Cottonwood	Populus deltoides	Good	Remove	2		2142	13	Eastern Cott		Populus deltoides	Good	Exempt	Ì	Ť i		
2064	12	Eastern Cottonwood	Populus deltoides	Good	Remove	2		2143	11	Eastern Cott	ttonwood	Populus deltoides	Good	Exempt			RE	MARKS I
2065	12,15	Eastern Cottonwood	Populus deltoides	Good	Remove	3		2144	8	Eastern Cott	ttonwood	Populus deltoides	Good	Exempt			SA	VE
2066	12	Eastern Cottonwood	Populus deltoides	Good	Remove	2		2145	17	Eastern Cott	ttonwood	Populus deltoides	Good	Exempt			CR	EDIT
2067	12	Eastern Cottonwood	Populus deltoides	Good	Remove	2		2146	10	Eastern Cott	ttonwood	Populus deltoides	Good	Exempt			Oiv	
2068	13	Eastern Cottonwood	Populus deltoides	Good	Remove	2		2147	11	Eastern Cott		Populus deltoides	Good	Exempt				
2069	8	Eastern Cottonwood	Populus deltoides	Good	Remove	1		2148	7	Eastern Cott		Populus deltoides	Good	Exempt			RE	MOVE
2070		Eastern Cottonwood	Populus deltoides	Good	Remove	1		2149	9	Eastern Cott		Populus deltoides	Good	Off-site	1020			
2071		Eastern Cottonwood	Populus deltoides	Good	Remove	1		2150	14,14	Eastern Cott	ttonwood	Populus deltoides	Good	In Public ROW	0		EV	EMPT
2072	8,9	Eastern Cottonwood	Populus deltoides	Good	Remove	3		2151	8	Box Elder		Acer negundo	Fair	In Public ROW	0			∟IVIF I
2073	8,12	Eastern Cottonwood	Populus deltoides	Good	Remove	3		2152	9	Black Willov	M.	Salix nigra	Good	REMOVE	2			
2074		Eastern Cottonwood	Populus deltoides	Good	Remove	6		2153	9	Eastern Cott		Populus deltoides	Good	REMOVE	2	2 2		
2075	Dead				Remove	U		2154 2155	Dead	Eastern Cott	DOOWHOL	Populus deltoides	Good	REMOVE In Public ROW	0			(a . N I
								2156	11	American El	lm	Ulmus americana	Good	In Public ROW	0			te: No rep
								2157	Dead	/ Unionical i Cl	art.	Jimus americana	5000	In Public ROW	0		\$7	7,200 (19
									- Jour								т .	, ,

QUIRED ACEMENT	CREDITS	TAG NO.	DIAMETER	COMMON NAME	BOTANICAL NAME	CONDITION	REMARKS	REQUIRED REPLACEMENT	CREDITS
2		2159	8	Eastern Cottonwood	Populus deltoides	Good	REMOVE	2	
1		2160	10	Eastern Cottonwood	Populus deltoides	Good	REMOVE	2	
2		2161	10	Eastern Cottonwood	Populus deltoides	Good	REMOVE	2	
2		2162	8,9	American Elm	Ulmus americana	Good	REMOVE	2	
1		2163	8	Sugar Maple	Acer saccharum	Good	Credit		2
4		2164	7	Sugar Maple	Acer saccharum	Good	Credit		2
5		2165	7	American Elm	Ulmus americana	Good	REMOVE	2	
1		2166	7	American Elm	Ulmus americana	Good	REMOVE	2	
1		2167	8	American Elm	Ulmus americana	Good	REMOVE	2	77
1		2168	8	Pin Cherry	Prunus pensylvanica	Good	Credit		2
2		2169	9	Eastern Cottonwood	Populus deltoides	Good	REMOVE	2	
1		2170	8	American Elm	Ulmus americana	Good	REMOVE	2	1
3		2171	12	Eastern Cottonwood	Populus deltoides	Good	REMOVE	2	
2		2172	8	Eastern Cottonwood	Populus deltoides	Good	REMOVE	2	
6		2173	12	Eastern Cottonwood	Populus deltoides	Good	REMOVE	2	
4		2174	13	Quaking Aspen	Populus tremuloides	Good	REMOVE	3	
0		2176	8	Sugar Maple	Acer saccharum	Good	Credit		2
0		2177	17	Eastern Cottonwood	Populus deltoides	Good	REMOVE	3	
0		2178	23	Sugar Maple	Acer saccharum	Good	Credit		4
		2179	11	Box Elder	Acer negundo	Fair	REMOVE	2	
0		2180	14	Box Elder	Acer negundo	Fair	REMOVE	3	
0		2181	8	Black Locust	Robinia pseudoacacia	Good	REMOVE	2	
2		2182	10	Box Elder	Acer negundo	Fair	REMOVE	2	
		2183	13	Box Elder	Acer negundo	Fair	REMOVE	3	
		2184	11	Black Locust	Robinia pseudoacacia	Good	REMOVE	2	
		2185	10	American Elm	Ulmus americana	Good	REMOVE	2	_
2		2186	9	American Elm	Ulmus americana	Good	REMOVE	2	1
2		2187	8,12	Eastern Cottonwood	Populus deltoides	Good	Remove	3	
1		2188	10	Eastern Cottonwood	Populus deltoides	Good	Remove	1	
1		2189	11	Common Apple	Malus spp.	Good	Remove	1	
2		2190	8	Eastern Cottonwood	Populus deltoides	Good	In Public ROW		
2						Required	Replacements	193	
4							Credits		12

WOODLAND SUMM	ARY:				
TOTAL TREES		185 TREES			
LESS:					
DEAD, C	OFF-SITE, ROW TREES	37 TREES			
NET TRI	EES	148 TREES			
REGULATED TREES	REMOVED	103 TREES			
REPLACEMENT REC	QUIRED				
TREES 8" - 11"	43 TREES X 1 =	43 TREES			
TREES 11" - 20"	38 TREES X 2 =	76 TREES			
TREES 20" - 30"	3 TREES X 3 =	09 TREES			
TREES 30"+	0 TREES X 4 =	00 TREES			
MULTI-STEMMED TF	REES (19 TREES)	77 TREES			
PRESERVED NON-R					
SUB-TOTAL REPLAC	205 TREES				
LESS CREDIT	12 TREES				
REQUIRED REPLAC	EMENTS	193 TREES			

SEE CHART FOR REMOVED VS. PRESERVED TREES

REMARKS KEY:	
SAVE	


TREES WILL BE SAVED. TREE IS LOCATED OUTSIDE OF A WOODLAND AREA

AND WILL BE SAVED.

REMOVE TREE IS LOCATED IN A REGULATED WOODLAND AND WILL BE REMOVED.

> TREE IS DEAD OR LOCATED OUTSIDE OF A WOODLAND AREA.

Note: No replacement trees are proposed to be planted on site and a payment of \$77,200 (193 tree credits x \$400) will be paid into the City of Novi Tree Fund.

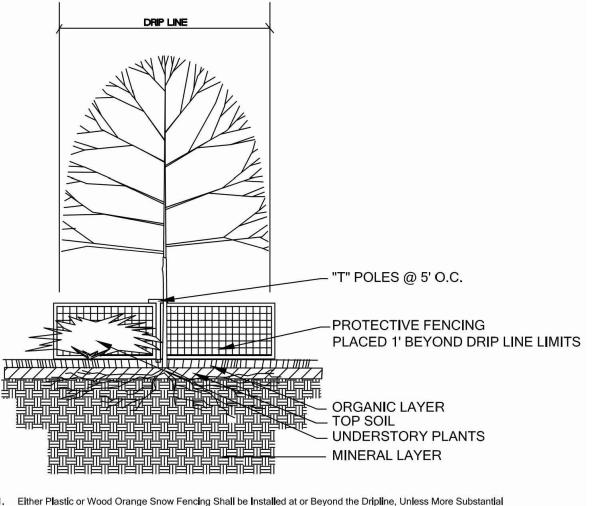

- 1. Either Plastic or Wood Orange Snow Fencing Shall be Installed at or Beyond the Dripline, Unless More Substantial
- Fencing is Required. 2. Stakes Shall be Metal "T" Poles Spaced no Further than 5' on Center.
- 3. Fencing Shall not be Installed Closer to the Tree than the Dripline of Those Trees to be Saved. Special Circumstances Shall be Reviewed by the City.
- 4. Fencing Shall be Erected Prior to Construction. The City Shall be Notified Once the Fencing is Instaled for
- Under no Circumstances Shall the Portective Fencing be Removed Without Proper Approval from the City.
 No Person Shall Conduct any Activity Within Areas Proposed to Remain. This Shall Include, but not Limited to:

 No Solvents or Chemicals Within Protected Areas.
 No Building Materials or Construction Equipment Within Protected Areas.
 - c. No Grade Changes, Including Fill, Within Protected Areas. d. No Removal of Vegetation from the Ground Up Without Permission from the Proper Reviewing Authority, Including the Woodlands Review Board.
- e. Any Required Swale Needs to be Directed Around the Protected Areas. Instances Where Swales are Approved Through a Protected Area, the Swales Need to be HAND DUG. Machinery of Any Kind is
- Regulated Woodland or Regulated Trees Adjacent to the Property are Also Required to be Protected Whether or not they are Shown on the Plan.

TREE PROTECTION DETAIL: NOT TO SCALE

PHRAGMITES AUSTRALIS LOCATIONS TO BE REMOVED NOTE: REFER TO SHEET L4.06 FOR REMOVAL INSTRUCTIONS



DESIGNED BY: DRAWN BY:

PLOT DATE:

ISSUE DATE

SPENCER J. OKESON S.J.O. & I.K. DANIEL R. ERLANDSON 06/25/2021

ISSUE FOR PRICING/BIDDING:

ISSUE FOR PERMIT APPLICATION:

ISSUE FOR CONSTRUCTION:


	REVISION SCHEDULE										
NO:	DATE:	DESCRIPTION:									
B	08/14/2020	ADDENDUM B									
c	09/25/2020	ADDENDUM C									

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1-JUNE-2

2021



HUMPHREYS & PARTNERS LANDSCAPE ARCHITECTURE, L.L.C. 5339 ALPHA ROAD SUITE 300 DALLAS, TX 75240 T: (972) 701-9636 F: (972) 701-9639 W: www.hplastudio.com

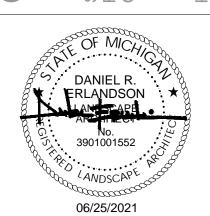CLIENT DTN MANAGEMENT 2502 LAKE LANSING RD SUITE C, LANSING, MI 48912

SHEET TITLE

WOODLAND PLAN

SHEET NUMBER